
Proposed Development for: **Bonair Developments** 153 Bonair Cresent (Block B) Silverdale, Auckland

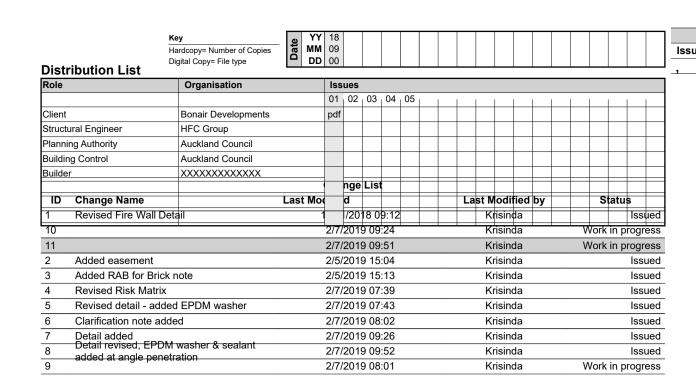








002 Scope of Works & Keynotes



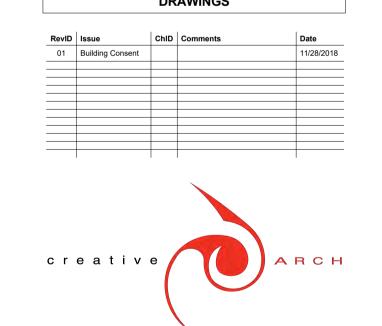

ALL ARCHITECTURAL DRAWINGS TO BE **READ IN CONJUNCTION WITH ENGINEERING**



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Bonair Developments

Proposed Development for:

153 Bonair Cresent (Block B) Silverdale, Auckland

KN checked: JM dwg n#:

2/7/2019 BC Block B rev n#: NOTE: Drawings are ½ scale @ A3

CAD ref: KrisindaBIM Server: CAL-BIM - BIMcloud Basic for ARCHICAD 21/Creative Arch/2005_Broadway Property Group_BLOCK B_BC

Notos			190mm Exterior masonry walls with Solid plaster finish to exterior,	
Notes 1	GENERAL		refer to engineering for reinforcing requirements, Constructed in accordance with NZS4210, refer to specific notes for strapping and lining requirements. FRR240/240/240	
1.00.00 1.00.01	GENERAL NOTES Compliance Standard	3.02.04	Timber Strapping & Lining w/Insulation Masonry block wall to be strapped with 50x50mm H1.2 battens on dpc at 600crs with Audex Greenstuff R1.3 40mm fibreglass	3.12.00
1.00.02	ALL WORK IS TO COMPLY WITH NZS3604.2011, NZS4229.1999 AND THE NZBC. Discrepancies in Documentation	3.02.05	insulation installed between with 10mm Gib board lining. Timber Strapping & Lining Masonry block wall to be strapped with 20x50mm H1.2 battens on	3.12.01
	For resolution of any discrepancies between architectural drawings, engineering drawings, specifications or manufacturers details, please refer to Architect prior to manufacture or commencement of	3.03.00	dpc at 600crs installed between with 10mm Gib board lining. NOTE: Substitute with 10mm Gib Aqualine in wet areas FIRE RATED WALLS	3.14.00
1.00.03	the affected works. Specification	3.03.00	Korok Intertenancy Interior Fire Rated Wall	3.14.01
1.00.04	All drawings to be read in conjunction with Architectural Specification Dimensions		KOROK KIT01 -/60/60 Fire Rated Intertenancy Wall: 51mm KOROK panels with 90x45 timber framing either side - studs at max 600 crs. 20mm cavity to one side. 15 mm cavity to the other. Audex	
1.00.05	Contractor to verify all dimensions on site prior to commencing work. Town Planning Refer to the conditions of the Resource Consent for compliance with		Greenstuff R2.2 Insulation both sides. 10mm Gib Standard Plasterboard either side. Use 6mm RAB in lieu of Gib in ceiling cavity. Fire Rated sealant to perimeter of walls. All fixed in accordance with manufacturers requirements.	4
1.01.00	aesthetics, planting etc. Resource consent ref: BUN60312463 SITE INFORMATION	3.03.02	5216S 20 Series Masonry Fire Rated Intertenancy Wall	4.01.00
1.01.01	Proposed Building Proposed buildings to be constructed as part of this consent. Refer to Architectural Plans and specifications for specific details. Engineering design plans and specifications for all structural	3.03.02	FRR240/240 - 190 mm thick Fire Rated intertenancy wall. Installed to Structural Engineers Details. 10mm Paint Finish Gib on 50x50mm H1.2 timber strapping with R1.3 Insulation to either side. Fire Rated sealant to perimeter.	4.01.00a 4.01.02
1.01.05	components. Fire Report. Geotechnical design plans and specifications for all geotechnical components. Existing Spot Levels	3.03.03	60/60/60 Post Fire Stability Brick Cladding Wall James Hardie JHETGR60a 60/60/60 Post Fire Stability Exterior Timber Framed Wall with Brick Cladding: 140x45 SG8 H1.2 Full	
	All heights of the Existing Contours have been provided by Churchill LDS Topographical Survey.		Height Timber Framing. Studs at max 600 crs, Nogs at max 800 crs, James Hardie 90mm Mineral Insulation. 13mm Gib Fyreline to interior face, Brick Veneer on cavity on 6mm RAB to exterior face.	4.02.00 4.02.05
1.01.06	Site Contours Site contours as taken from civil plans by Crang Civil. Refer to the Services Plan for heights of all services and Lid Levels and Inverts.	3.03.04	G0/60/60 Post Fire Stability - Stria James Hardie JHETGR60a 60/60/60 Post Fire Stability Exterior Timber Framed Wall with JH Stria fibre cement cladding: 140x45	
1.01.10	Retaining Walls Retaining walls - setout, design; read in conjunction with Crang Civil civil drawings and reports.		SG8 H1.2 Full Height Timber Framing. Studs at max 600 crs, Nogs at max 800 crs, James Hardie 90mm Mineral Insulation. 13mm GIB Fyreline to interior face. Stria cladding on cavity on 6mm RAB to exterior face.	4.02.37
1.02.00 1.02.02	TEMPORARY SERVICES/SITE PROTECTION Allow for Temp. Hoarding	3.03.05	60/60/60 Post Fire Stability EZpanel Cladding Wall -	
	Building Contractors to temporarily hoard the building platform from public access in accordance with the requirements of OSH. Ensure a Hazard board is erected to the main entry of the site where site visitors sign in.		James Hardie JHETRR60 60/60/60 Post Fire Stability Exterior Timber Framed Wall with EZ Panel cladding: 140x45SG8 H1.2 Full Height Timber Framing. Studs at max 600 crs, Nogs at max 800 crs, James Hardie 90mm Mineral Insulation. Lightweight aerated concrete cladding on cavity. 6mm RAB to exterior faces (both sides).	4.02.39
1.02.03	Recycling of Waste Materials All metals, glass, timber and paper are to be separated for recycling. Separation may occur off site if managed by specialist constructors.	3.03.07	Korok Intertenancy Exterior Fire Rated Wall KOROK KIT01 -/60/60 Fire Rated Intertenancy Wall: 51mm KOROK	4.03.00 4.03.01
1.02.04	Site Cleanliness Ensure site is kept clean during construction. Remove all rubbish, noxious matter and organic matter from the area that result from the proposed works.		panels with 90x45 timber framing either side - studs at max 600 crs. Min 20mm cavity to one side. Min 15 mm cavity to the other. Autex Greenstuff R2.2 Insulation both sides. Exterior cladding on cavity on 6mm James Hardie RAB to either side. Fire Rated sealant to perimeter of walls. All fixed in accordance with manufacturers	
1.02.07	Site Toilet Provide portable toilet facilities, maintain and regularly clean to a reasonable standard.	3.03.09	requirements. 60/60/60 Post Fire Stability Fibre Cement Cladding Wall James Hardie JHETRR60 60/60/60 Post Fire Stability Exterior	4.03.02
1.02.08	Scaffolding Provide external access and scaffolding required, erect in accordance with the scaffolding regulations, maintain and remove on completion. Ensure roadway and driveway access to the public and the other units is kept clear.		Timber Framed Wall with Fibre Cement cladding: 140x45 SG8 H1.2 Full Height Timber Framing. Studs at max 600 crs, Nogs at max 800 crs, James Hardie 90mm Mineral Insulation. 6mm RAB to each side. Profiled Metal cladding on cavity on 6mm RAB to exterior face. Fibre Cement cladding on cavity on 6mm RAB to interior cupboard face.	4.03.03
1.02.14	Final Clean Commercial clean shall be provided for at the completion of the project to the interior and exterior.	3.03.13	60/60/60 Post Fire Stability Profiled Metal Cladding Wall James Hardie JHETGR60a 60/60/60 Post Fire Stability Exterior Timber Framed Wall with Profiled Metal Cladding: 140x45 SG8 H1.2 Full Height Timber Framing. Studs at max 600 crs, Nogs at max 800 crs, James Hardie 90mm Mineral Insulation. 13mm Gib Fyreline to	4.03.04
2	SITE	3.04.00	min 800 AFFL, 13mm Standard Gib above to interior face. Profiled Metal cladding on cavity on 6mm RAB to exterior face. TIMBER WALLS	
2.01.00	SERVICES	3.04.01	Internal Framed Walls - 90mm	4.03.05
2.01.02	Services All services to Units in accordance with the Crang Civi civil drawings and reports. Contractors to locate all connection points and highlight for all future trades. All invert levels to be confirmed prior to		Generally construct with 90x45 SG8 KD H1.2 framing with studs @ 600crs and nogs @ 800crs to NZS3604.2011 unless noted otherwise. Ensure all insulation within framing where applicable, is secured into place with DanBand straps in accordance with the requirements of E2/AS1. Nog for all fittings, fixtures, linings, bracing	
2.03.00	commencement of works. PREPARATION/GROUNDWORK		panels and trims. DPC (malthoid) between bottom plate and conc. slab and fixed with M12 bolts @ 900crs. Refer to the Structural Layouts for the bracing requirements.	4.03.06
2.03.01	Removal of Vegetation All vegetation to be scrapped and removed from the immediate area where the contract works will occur. Dispose of safely at an authorised refuse transfer station.	3.04.05	External Framed Walls - 90mm Generally construct with 90x45 SG8 KD H1.2 framing with studs on Hi and Dri packers at crs as per setout plans and nogs @ 600crs to NZS3604.2011 unless noted otherwise. Ensure all insulation within	
2.03.02	Site Clearance (Landscaping) Remove any planting, shrubbery and landscaping in order to gain access to the works and to erect scaffolding. Site Clearance (Rubbish)		framing where applicable, is secured into place with DanBand straps in accordance with the requirements of E2/AS1. Nog for all fittings, fixtures, linings, bracing panels and trims. DPC (malthoid) between bottom plate and conc. slab and fixed with M12 bolts @ 900crs. Refer to the Structural Layouts for the bracing requirements. 6mm	4.03.08
2.03.04	Remove all rubbish, noxious matter and organic matter from the area covered by the proposed works. Site Surfacing	3.04.23	RAB to exterior face of walls. External Framed Walls - 140mm Generally construct with 140x45 SG8 KD H1.2 framing with studs on	
2.03.05	Contractor is to refer to the Landscape Architects layout for designation for Landscaping and Hardscaping. Excavate and Backfill		Hi and Dri packers at 600 crs and nogs @ 600crs to NZS3604.2011 unless noted otherwise. Nog for all fittings, fixtures, linings, bracing panels and trims. DPC (malthoid) between bottom plate and conc. slab and fixed with M12 bolts @ 900crs. 6mm RAB to exterior face	4.03.09
	Refer to Geotechnical Report and Crang Civil documentation for specific parameters for excavation and backfill requirements to prepare building platform. To be strictly read in conjunction with	3.05.00	of walls. ROOFS	
2.04.00	engineers foundation and retaining design. FOUNDATIONS	3.05.00a 3.05.01	TRUSSES Specific Design Trusses	4.03.10
2.04.01	Min. FFL above FGL. Finished slab level to be 225mm above finished natural ground level or 150mm above concrete paved area, as per the New Zealand Building Code.	0.00.01	Specific design trusses @ centres and fixings as noted on the truss manufacturer plans and specifications. Truss treatment to be H1.2 minimum, unless noted otherwise. Refer to manufacturers truss design for details. Trusses shown on architectural are indicative	4.04.00
3	STRUCTURE	.	only. all truss information is to be referred to truss manufacturer documents. Building Contractor to ensure all heel heights and roof steps are correct.	4.04.01
3.01.00	GENERAL NOTES	3.06.00 3.06.06	PURLINS 90x45 SG8 H1.2 Timber Purlins	
3.01.01	Engineering Drawings All architectural drawings are to be read in conjunction with engineering drawings by HFC. Any conflicting information is to be clarified by the Architect prior to commencement of work.	3.08.00	90x45 SG8 H1.2 treated purlins @ 900mm crs to roof areas, fixed to framing with 1/10g self drilling screw 80mm long fixing as per NZS 3604. CEILING BATTENS	4.04.02
3.01.08	Concrete Strength All concrete strengths to be in accordance with the design of the Structural Engineer. Ensure bearing capacity of the building platform is in accordance with these design calculations.	3.08.01 3.10.00	Soffit Battens 90x45 SG8 H1.2 ceiling battens @ 600crs. FLOORS	4.04.03
3.01.09	Concrete Work Refer to Architectural drawings for all nibs, rebates, recesses etc. and for all setout dimensions and finished levels. Ensure all reinforcing sizing, frequency and locations are in accordance with	3.10.00a 3.10.01	FLOOR REBATES Brick 120mm rebate Rebate to accomodate brick veneer.Rebate to be 120mm wide by	4.04.04
3.01.10	the requirements of the Structural Engineers design. Timber Framing Unless specifically stated elsewhere the minimum timber sizes,		depth as shown on drawings. Rebate detailed as per manufacturers specification - Refer to architectural plan for recesses, dimensions and levels ONLY.	4.04.07
3.01.11	spacings and grade shall be in accordance with NZS3604.2011. Timber Treatment Unless specifically stated on timber treatment notes on floor plans, the minimum treatment shall be in accordance with NZBC B2/AS1	3.10.02	Brick Set-down Set-down to face of masonry to engineers details to accomodate brick veneer. Rebate to be 120mm wide by depth as shown on drawings. Rebate detailed as per manufacturers specification - Refer to architectural plan for recesses, dimensions and levels ONLY.	-2.001
3.01.12	and the BRANZ timber treatment requirements. Stainless Steel Fixings Stainless steel fixings to be used throughout building within sea	3.10.03	Joinery 30mm Rebate 30mm Deep Rebate to accomodate entry door, sliding door and full	4.04.08
2 00 00	Stainless steel fixings to be used throughout building within sea spray zone. Main contractor to ensure all fixings comply with all relevant NZ standards and NZBC.		height window joinery. Rebate to be 30mm deep with width to suit wall framing - Refer to architectural plan for recesses, dimensions and levels ONLY. C.O.S. all rebate sizes with joinery manufacturer prior to forming rebate.	4.04.09
3.02.00 3.02.00a	WALLS CONCRETE WALLS	3.11.00	CONCRETE FLOORS	
3.02.01	20 Series Masonry Walls 190mm masonry walls refer to engineering for reinforcing requirements, Constructed in accordance with NZS4210, refer to specific notes for strapping and lining requirements. FRR240/240/240	3.11.05	Rib-Infill Floor System Rib and Infill floor slab as designed and detailed by structural engineer. 150 Rib + 25 infill + 100 topping. Refer to structural engineer's plans for structural layout & reinforcing. Refer to architectural plan for recesses, dimensions and levels only. 3155FR	4.04.20
3 02 03	20 Series Masonry Exterior Walls			

3.11.06 Concrete Slab on Grade Floor

3.02.03 20 Series Masonry Exterior Walls

aster finish to exterior, ents, Constructed in notes for strapping and		Concrete slab on grade floor. 100 thick slab on grade with mesh on DPM on 15mm sand blinding on 150mm compacted hardfills. Refe to structural engineer's plans and specification for structural layout reinforcing. Refer to architectural plan for recesses, dimensions and levels only.
tion 50mm H1.2 battens on 0mm fibreglass board lining.	3.12.00	RAISED TIMBER BALCONY DECKING
50mm H1.2 battens on Gib board lining. NOTE: reas	3.12.01	Vitex 140x19 Raised Timber Decking Vitex 140x19 timber decking on raised Outdure Qwickbuild aluminium. Vitex decking system to have 3mm gaps, Selected coating applied to all faces.
ed Wall noy Wall: 51mm KOROK	3.14.00 3.14.01	Precast Stair Precast concrete stairs to comply with the requirements of D1/AS1 for Private Stair. Min Tread 280mm, max riser 190mm. All stairs to have 50dia bandrail set 000mm above the pitch line of the stairs
e - studs at max 600 crs. e other. Audex n Gib Standard		have 50dia handrail set 900mm above the pitch line of the stairs. Refer to Structural Engineers drawings for precast details.
ieu of Gib in ceiling alls. All fixed in ts.	4	ENCLOSURE
enancy Wall	4.01.00	ROOFING ROOF CLADDING
intertenancy wall. mm Paint Finish Gib on nsulation to either side.	4.01.00a 4.01.02	O.55BMT Colorsteel Endura Steel&Tube Plumdek (Roofing) O.55BMT Colorsteel Endura Steel&Tube Plumdek roofing system o
adding Wall Fire Stability Exterior Ox45 SG8 H1.2 Full		roofing underlay on 90x45 battens at max 900 crs at pitch as per roof plans, sections and elevations. Install strictly as per manufacturer's specifications and details.
rs, Nogs at max 800 crs, nm Gib Fyreline to n RAB to exterior face.	4.02.00 4.02.05	SPOUTING/DOWNPIPES Steel&Tube Square Plumbline Gutter
Fire Stability Exterior ent cladding: 140x45 s at max 600 crs, Nogs		Steel&Tube Square Plumbline Coloursteel Endura Gutter on international brackets [as per manufacturers specification] on steel fascia. Install strictly as per manufacturer's specifications and details. Brackets and gutter to be finished to match roofing.
al Insulation. 13mm GIB wity on 6mm RAB to	4.02.37	Steel&Tube 80 dia Colorsteel Endura downpipes
Cladding Wall -		Steel&Tube 80dia Colorsteel Endura downpipes. Ensure downpipe location is within boundary of respective unit. Install strictly as per manufacturer's specifications and details. Downpipes to be finished to match roofing and gutter.
e Stability Exterior : 140x45SG8 H1.2 Full rs, Nogs at max 800 crs,	4.02.39	Timber Pre-primed Fascia 250mm 25mm x250mm Pre-primed paint finish Fascia finished to match roofing. Install strictly as per manufacturer's specifications and
htweight aerated kterior faces (both sides). ted Wall	4.03.00	details. Refer details for height. FLASHINGS
ncy Wall: 51mm KOROK e - studs at max 600 crs.	4.03.01	Flashings General Provide all flashings to internal & external corners, heads and sills of
wity to the other. Autex ior cladding on cavity on Rated sealant to ith manufacturers		openings and where indicated on architectural and manufacturer details. Visible flashings to match adjacent joinery or roofing materials
ment Cladding Wall re Stability Exterior	4.03.02	PVC kickout flashing PVC kickout flashing installed at base of roofing above the guttering and fixed under the apron flashing where the roof meets a vertical
lding: 140x45 SG8 H1.2 00 crs, Nogs at max 800 . 6mm RAB to each side.	4.03.03	wall. Refer to details. 0.55BMT Colorsteel Endura Over Flashing 0.55BMT Colorsteel Endura Over Flashing purpose made to match
AB to exterior face. Fibre interior cupboard face. Metal Cladding Wall		roofing pitch and profile. Flashing for roof penetrations on roofs with less than 8 degrees. Take flashing from roof penetration element to under ridge/apex flashing. Flashing edge notched to fit over roofing profile. Seperate all timber members to steel members with a layer
ire Stability Exterior dding: 140x45 SG8 H1.2 00 crs, Nogs at max 800	4.03.04	of DPC. Prefinished to match roofing. 0.55BMT Colorsteel Endura Back Flashing
. 13mm Gib Fyreline to o interior face. Profiled terior face.		Prefinished 0.55BMT Colorsteel Endura Back Flashing purpose made flashing with turned edge to be placed behind cladding junction. Seperate all timber members to steel members with a layer of DPC. Ensure all laps & overhangs comply with E2/AS1 January
2 framing with studs @ 1 unless noted ng where applicable, is accordance with the fixtures, linings, bracing	4.03.05	2017 Amendment 7 0.55BMT Colorsteel Endura Custom Flashings Prefinished 0.55BMT Endura purpose made flashings with turned edge - Ensure all laps & overhangs comply with E2/AS1 January 2017 Amendment 7. Measure and confirm all dimensions on site prior to manufacturing. Seperate all timber members to steel members with a layer of DPC. Visible flashings prefinished to
oottom plate and conc. fer to the Structural	4.03.06	matched to adjacent joinery of roofing materials 0.55BMT Colorsteel Endura Eave Flashing 0.55BMT Colorsteel Endura Eave Flashing purpose made to match
2 framing with studs on s and nogs @ 600crs to ure all insulation within ace with DanBand straps		roofing pitch and profile as per E2/AS1 for roof pitches less than 10deg. Installed in accordance with E2/AS1. Turn-down low-end terminations to form drip edge. Seperate all timber members to steemembers with a layer of DPC. Prefinished to match roofing.
AS1. Nog for all fittings, PC (malthoid) between M12 bolts @ 900crs. ng requirements. 6mm	4.03.08	0.55BMT Colorsteel Endura Barge Flashing 0.55BMT Colorsteel Endura Barge Flashing purpose made to mate roofing pitch and profile with birds beak at bottom edge. Ensure flashing cover over roof cladding to be min. 2 ribs and fascia downstand cover to be min. 70mm. Flashing edge notched to fit over roofing profile. Seperate all timber members to steel members with
1.2 framing with studs on 00crs to NZS3604.2011 ixtures, linings, bracing	4.03.09	layer of DPC. Prefinished to match roofing. 0.55BMT Colorsteel Endura Apron Flashing 0.55BMT Colorsteel Endura Apron Flashing purpose made to match
oottom plate and conc. m RAB to exterior face		roofing pitch and profile. Ensure flashing cover over roof cladding to be min. 2 ribs. Flashing edge notched to fit over roofing profile. Seperate all timber members to steel members with a layer of DPC
	4.03.10	Prefinished to match roofing. 0.55BMT Colorsteel Endura Ridge Flashing 0.55BMT Colorsteel Endura Ridge Flashing purpose made to match
gs as noted on the truss s treatment to be H1.2 manufacturers truss		roofing pitch and profile. Ensure flashing cover over roof cladding to be min. 200mm. Flashing edge notched to fit over roofing profile. Seperate all timber members to steel members with a layer of DPC Prefinished to match roofing.
c <mark>tural are indicative</mark> truss manufacturer Il heel heights and roof	4.04.00	TANKING/MEMBRANES
	4.04.01	Ardex Shelterseal 3000X Tanking Ardex Shelterseal 3000X pe and stick Tanking installed strictly as per manufacturers specifications and details to below ground applications - foundations, retaining walls etc 4131A
crs to roof areas, fixed to long fixing as per NZS	4.04.02	Thermakraft Thermathene 300 DPM Thermakraft Thermathene Orange 300 micron polythene damp- proof membrane (DPM) under slab / footings. Install strictly as per manufacturer's specifications and details. 4161T
	4.04.03	Themakraft Supercourse 500 DPC Thermakraft Supercourse 500 DPC between concrete/concrete masonry /aluminium and timber members. Install strictly as per manufacturer's specifications and details. 4161T
to be 120mm wide by ed as per manufacturers recesses, dimensions	4.04.04	Ardex WPM 189 2 layer Torch-on Membrane Ardex WPM 189 2 layer Torch-on Membrane installed strictly in accordance with manufacturers requirements. Dual Layer system to decks below raised decking
etails to accomodate depth as shown on	4.04.07	ARDEX WPM Undertile Waterproofing ARDEX WPM 750 Weldtec Internal Undertile Sheet Waterproofing Membrane to all wet areas. Install strictly as per manufacturer's specifications and details.
rers specification - Refer is and levels ONLY. oor, sliding door and full the provide with width to suit	4.04.08	Sikalastic 152 Sikalastic 152 Exterior Waterproofing Membrane applied to expose face of Slab and rebates. All in accordance with manufacturers
deep with width to suit recesses, dimensions th joinery manufacturer	4.04.09	requirements. Cemix Seal to blockwork Cemix Brick and Block Sealer Applied to block face prior to lining with brick cladding. All in accordance with manufacturers
ailed by structural Refer to structural	4.04.20	requirements. Thermakraft Covertek 407 Roof Underlay Thermakraft Covertek 407 self supporting roof underlay fixed over purlins. Install strictly as per manufacturer's specifications and
orcing. Refer to		details. Where roof pitches require, ensure support mesh is installe

finish to exterior, Constructed in s for strapping and		Concrete slab on grade floor. 100 thick slab on grade with mesh on DPM on 15mm sand blinding on 150mm compacted hardfills. Refer to structural engineer's plans and specification for structural layout & reinforcing. Refer to architectural plan for recesses, dimensions and levels only. 3155FR
n H1.2 battens on n fibreglass rd lining.	3.12.00	RAISED TIMBER BALCONY DECKING
n H1.2 battens on	3.12.01	Vitex 140x19 Raised Timber Decking Vitex 140x19 timber decking on raised Outdure Qwickbuild aluminium. Vitex decking system to have 3mm gaps, Selected
board lining. NOTE:	3.14.00	coating applied to all faces. STAIRS
Vall	3.14.01	Precast Stair Precast concrete stairs to comply with the requirements of D1/AS1
Vall: 51mm KOROK uds at max 600 crs. ner. Audex		for Private Stair. Min Tread 280mm, max riser 190mm. All stairs to have 50dia handrail set 900mm above the pitch line of the stairs. Refer to Structural Engineers drawings for precast details.
o Standard of Gib in ceiling		
All fixed in	4 4.01.00	ENCLOSURE ROOFING
ncy Wall rtenancy wall.		ROOF CLADDING
Paint Finish Gib on ation to either side.	4.01.02	0.55BMT Colorsteel Endura Steel&Tube Plumdek (Roofing)
ng Wall Stability Exterior		0.55BMT Colorsteel Endura Steel&Tube Plumdek roofing system on roofing underlay on 90x45 battens at max 900 crs at pitch as per roof plans, sections and elevations. Install strictly as per
5 SG8 H1.2 Full logs at max 800 crs,	4.02.00	manufacturer's specifications and details. SPOUTING/DOWNPIPES
Gib Fyreline to B to exterior face.	4.02.05	Steel&Tube Square Plumbline Gutter Steel&Tube Square Plumbline Coloursteel Endura Gutter on internal
Stability Exterior sladding: 140x45		brackets [as per manufacturers specification] on steel fascia. Install strictly as per manufacturer's specifications and details. Brackets and gutter to be finished to match roofing.
max 600 crs, Nogs sulation. 13mm GIB on 6mm RAB to	4.02.37	7411M Steel&Tube 80 dia Colorsteel Endura downpipes
dding Wall -	4.02.01	Steel&Tube 80dia Colorsteel Endura downpipes. Ensure downpipe location is within boundary of respective unit. Install strictly as per manufacturer's specifications and details. Downpipes to be finished
ability Exterior 0x45SG8 H1.2 Full	4.02.39	to match roofing and gutter. Timber Pre-primed Fascia 250mm
ogs at max 800 crs, ight aerated		25mm x250mm Pre-primed paint finish Fascia finished to match roofing. Install strictly as per manufacturer's specifications and details. Refer details for height.
or faces (both sides). Wall	4.03.00	FLASHINGS
Vall: 51mm KOROK uds at max 600 crs. to the other. Autex	4.03.01	Flashings General Provide all flashings to internal & external corners, heads and sills of
ladding on cavity on ed sealant to nanufacturers		openings and where indicated on architectural and manufacturer details. Visible flashings to match adjacent joinery or roofing materials
nt Cladding Wall	4.03.02	PVC kickout flashing PVC kickout flashing installed at base of roofing above the guttering
ability Exterior : 140x45 SG8 H1.2		and fixed under the apron flashing where the roof meets a vertical wall. Refer to details.
rs, Nogs at max 800 m RAB to each side. o exterior face. Fibre	4.03.03	0.55BMT Colorsteel Endura Over Flashing 0.55BMT Colorsteel Endura Over Flashing purpose made to match roofing pitch and profile. Flashing for roof penetrations on roofs with
ior cupboard face. al Cladding Wall		less than 8 degrees. Take flashing from roof penetration element to under ridge/apex flashing. Flashing edge notched to fit over roofing
Stability Exterior g: 140x45 SG8 H1.2 rs, Nogs at max 800	4.02.04	profile. Seperate all timber members to steel members with a layer of DPC. Prefinished to match roofing.
nm Gib Fyreline to erior face. Profiled	4.03.04	0.55BMT Colorsteel Endura Back Flashing Prefinished 0.55BMT Colorsteel Endura Back Flashing purpose made flashing with turned edge to be placed behind cladding
r face.		junction. Seperate all timber members to steel members with a layer of DPC. Ensure all laps & overhangs comply with E2/AS1 January 2017 Amendment 7
ming with studs @	4.03.05	0.55BMT Colorsteel Endura Custom Flashings Prefinished 0.55BMT Endura purpose made flashings with turned
less noted here applicable, is dance with the		edge - Ensure all laps & overhangs comply with E2/AS1 January 2017 Amendment 7. Measure and confirm all dimensions on site prior to manufacturing. Seperate all timber members to steel
res, linings, bracing m plate and conc. o the Structural		members with a layer of DPC. Visible flashings prefinished to matched to adjacent joinery of roofing materials
	4.03.06	0.55BMT Colorsteel Endura Eave Flashing 0.55BMT Colorsteel Endura Eave Flashing purpose made to match
ming with studs on d nogs @ 600crs to all insulation within		roofing pitch and profile as per E2/AS1 for roof pitches less than 10deg. Installed in accordance with E2/AS1. Turn-down low-end terminations to form drip edge. Seperate all timber members to steel
vith DanBand straps Nog for all fittings,	4.03.08	members with a layer of DPC. Prefinished to match roofing. 0.55BMT Colorsteel Endura Barge Flashing
malthoid) between polts @ 900crs. quirements. 6mm		0.55BMT Colorsteel Endura Barge Flashing purpose made to match roofing pitch and profile with birds beak at bottom edge. Ensure flashing cover over roof cladding to be min. 2 ribs and fascia
		downstand cover to be min. 70mm. Flashing edge notched to fit over roofing profile. Seperate all timber members to steel members with a layer of DPC. Prefinished to match roofing.
raming with studs on s to NZS3604.2011 es, linings, bracing	4.03.09	0.55BMT Colorsteel Endura Apron Flashing 0.55BMT Colorsteel Endura Apron Flashing purpose made to match
m plate and conc. AB to exterior face		roofing pitch and profile. Ensure flashing cover over roof cladding to be min. 2 ribs. Flashing edge notched to fit over roofing profile.
	100.40	Seperate all timber members to steel members with a layer of DPC. Prefinished to match roofing.
	4.03.10	0.55BMT Colorsteel Endura Ridge Flashing 0.55BMT Colorsteel Endura Ridge Flashing purpose made to match roofing pitch and profile. Ensure flashing cover over roof cladding to
noted on the truss atment to be H1.2 ufacturers truss		be min. 200mm. Flashing edge notched to fit over roofing profile. Seperate all timber members to steel members with a layer of DPC. Prefinished to match roofing.
al are <mark>ind</mark> icative s manufacturer el heights and roof	4.04.00	TANKING/MEMBRANES
er neights and roof	4.04.01	Ardex Shelterseal 3000X Tanking Ardex Shelterseal 3000X pe and stick Tanking installed strictly as per manufacturers specifications and details to below ground
o roof areas, fixed to	4.04.02	applications - foundations, retaining walls etc 4131A Thermakraft Thermathene 300 DPM
fixing as per NZS		Thermakraft Thermathene Orange 300 micron polythene damp- proof membrane (DPM) under slab / footings. Install strictly as per
	4.04.03	manufacturer's specifications and details. 4161T Themakraft Supercourse 500 DPC
	4.04.00	Thermakraft Supercourse 500 DPC between concrete/concrete masonry /aluminium and timber members. Install strictly as per manufacturer's specifications and details.
	4.04.04	4161T Ardex WPM 189 2 layer Torch-on Membrane
e 120mm wide by s per manufacturers esses, dimensions		Ardex WPM 189 2 layer Torch-on Membrane installed strictly in accordance with manufacturers requirements. Dual Layer system to decks below raised decking
,	4.04.07	ARDEX WPM Undertile Waterproofing ARDEX WPM 750 Weldtec Internal Undertile Sheet Waterproofing
s to accomodate h as shown on		Membrane to all wet areas. Install strictly as per manufacturer's specifications and details.
specification - Refer d levels ONLY.	4.04.08	Sikalastic 152 Sikalastic 152 Exterior Waterproofing Membrane applied to expected
sliding door and full with width to suit		Sikalastic 152 Exterior Waterproofing Membrane applied to exposed face of Slab and rebates. All in accordance with manufacturers requirements.
sses, dimensions nery manufacturer	4.04.09	Cemix Seal to blockwork Cemix Brick and Block Sealer Applied to block face prior to lining
		with brick cladding. All in accordance with manufacturers requirements.
	4.04.20	Thermakraft Covertek 407 Roof Underlay

in conjunction with roofing paper.

4.04.26 3M Flashing Tape

```
Approved 3M 8067 All weather flashing tape as per manufacturer's
                                                                      specifications and details. Install strictly as per manufacturer's
                                                                                                                                         4.08.00 SEALANTS
                                                                      specifications and details
                                                          4.05.00 CLADDING
                                                          4.05.02 Plytech 12mm Exterior Grade Ply Soffit Lining
                                                                      Plytech Radiata Decorative SD 12mm Exterior Grade H3.2 LOSP
                                                                      Ply Soffit lining on 35 x 70 (unless specifically sized for specific
                                                                      depth. Refer to architectural details) H1.2 timber framing battens @
                                                                      600mm crs. with factory applied Blonded / Clear Coat finish and
                                                                     further site applied coating. C/S SS screw fixings. Use Shadowclad
                                                                      negative detail at sheet joints. Refer specification.
                                                                    Specialized Plaster System
                                                                      Specialized plaster System over 20 series masonary blockwork,
                                                                      Float textured finish by Specialized Systems. Min 2 coats of paint.
                                                                      Colour TRD. All installation in accordance with manufacturers
                                                                      specifications. System only for timber framed wing walls.
                                                          4.05.08 Midland NZ Brick Veneer
                                                                      Midland NZ brick veneer with 50mm cavity with RAB on timber
                                                                      framed walls, to NZS 3604 : 2011. Provide weep holes @800mm
                                                                      max centres and 10mm ventilation gap between top of brick and
                                                                      soffit lining. Wall ties and fixings in accordance with NZS 4210:
                                                                     2001. Standard range motar, colour to match brick. The 2 storey
                                                                      brick cladding system used on this building must be completed to
                                                                      'Design Note TB1' refer to Midland Brick for Design Note TB1. Install
                                                                      strictly as per manufacturer's specifications and details.
                                                          4.05.09 Specialized System EZ Panel Lightweight Cladding
                                                                      Specialized System FZ Panel 50mm autoclayed lightweight concrete
                                                                      Facade System over 50x20mm High Density EPS vertical cavity
                                                                      battens at 600crs max. Float textured finish by Specialized Systems.
                                                                      Min 2 coats of paint. Colour TBD. All installation in accordance with
                                                                      manufacturers specifications. System only for timber framed wing
                                                                                                                                         5.01.00 WALL LINING
                                                                   0.55BMT Colorsteel Endura Steel&Tube Paneldek
                                                                      (Cladding)
                                                                      0.55BMT Colorsteel Endura Steel&Tube Paneldek vertical cladding.
                                                                      Fix over separation DPC over 20x45 H3.2 horizontal timber cavity
                                                                      battens at max 600crs. Cavity battens to be castellated on both
                                                                      faces to provide drainage and ventilation and must be used
                                                                      horizontally only. Fix cladding with S&T concealed fixing clip. Install
                                                                      strictly as per manufacturer's specifications and details.
                                                                   6mm James Hardie (RAB)
                                                                      6mm thick James Hardie Rigid Air Barrier RAB board fixed in
                                                                      accordance with manufacturer's specifications and details. Use only
                                                                      in areas where fire rating is required on a timber framing system
                                                                      inconjunction with Gib Fyreline. Refer to architectural details. Seal
                                                                      vertical joints with sealing tape and horizontal joints with James
                                                                      Hardie proprietary RAB flashings. Install strictly as per
                                                                      manufacturer's specifications and details. Refer to Fire report and
flashings to internal & external corners, heads and sills of 4.05.23
                                                                     6mm JH HardieFlex cladding
                                                                      6mm thick James Hardie Hardieflex Fibre Cement cladding over
                                                                      45x20 H3.2 vertical cavity battens at max 600 cr
                                                                      Install strictly as per manufacturer's specifications and details.
                                                          4.05.25 4.5mm JH Eclipsa Soffit Lining
                                                                      4.5mm James Hardie Eclipsa soffit lining on 45 x 90 (unless
                                                                      specifically sized for specific depth. Refer to architectural details)
                                                                      H1.2 timber framing @ max 600mm crs. Paint finish with uPVC
                                                                      jointers @600crs. Install strictly as per manufacturer's specifications
                                                                      and details
                                                                     14mm JH Stria cladding
                                                                      14mm thick James Hardie Stria Fibre Cement cladding over 45x20
                                                                      H3.2 vertical cavity battens at max 600 cr
                                                                      Install strictly as per manufacturer's specifications and details.
                                                                     Specialized Plaster System over battens
                                                                      Specialized plaster System over 30mm High Density EPS Float
                                                                      textured finish by Specialized Systems. Min 2 coats of paint. Colour
                                                                      TBD. All installation in accordance with manufacturers.
                                                                                                                                         5.04.00 STAIRS
                                                                      specifications. System only for timber framed wing walls
                                                         4.05.28 Specialized System EZ Panel Lightweight Cladding
                                                                      (40mm cavity)
                                                                      Specialized System EZ Panel 50mm autoclaved lightweight concrete
                                                                      Facade System over 40mm High Density EPS vertical cavity battens
                                                                      at 600crs max. Float textured finish by Specialized Systems. Min 2
                                                                      coats of paint. Colour TBD. All installation in accordance with
                                                                      manufacturers specifications. System only for timber framed wing
                                                          4.06.00 DOORS WINDOWS & SKYLIGHTS
                                                                      All glazing to be double glazed and comply with N.Z.S 422301:2008
                                                         4.06.03 Safety Glass
                                                                      Grade A safety glass to all showers & overhead glazing, All glazing
                                                                      to comply with NZS 4223.3:2016. Incorporating Amendment No. 1
                                                                      Refer to window and door schedule for glass selections.
Colorsteel Endura Barge Flashing purpose made to match 4.06.06
                                                                    NZ Fire Doors Entry Doors
                                                                                                                                                      Selected carpet over underlay, installed as per manufacturer's
                                                                     NZ Fire Doors Entry Doors (-/60/30SM) with colour as per Resource
                                                                                                                                                     specification. Selection TBC by client.
                                                                      Consent specifications. Rebate 30mm deep and size must be
                                                                      confirmed with manufacturer prior to rebate installation. Include paint
                                                                      grade radiata pine architraves. Refer to window and door schedule.
                                                                      Confirm size on site prior to manufacture. Install strictly as per
                                                                      manufacturer's specifications and details. Hardware TBC by client
Colorsteel Endura Apron Flashing purpose made to match 4.06.07
                                                                    Fairview Elite Powdercoated Rebated Aluminium
                                                                                                                                         6.02.00 WALL FINISH
                                                                      Sliding Doors
                                                                      Elite Fairview Classic Residential 35 Powdercoated Rebated
                                                                      Aluminium glazed Sliding Doors with Flush track Sills. Colour as per
                                                                      Resource Consent specifications. Rebate 30mm deep and size must
                                                                      be confirmed with manufacturer prior to rebate installation. Clear
                                                                      double glazed with paint grade radiata pine architraves. Refer to
                                                                      window and door schedule. Confirm size on site prior to
                                                                      manufacture. Install strictly as per manufacturer's specifications and
                                                                      details. Hardware TBC by client.
                                                          4.06.08 Fairview Elite Powdercoat Aluminium Windows
                                                                      Elite Fairview Classic Residential 35 Powdercoated Aluminium
                                                                      Windows. Colour as per Resource Consent specifications. Double
                                                                      glazed with paint grade radiata pine architraves. Obscure glass to
                                                                      bathrooms, wc's and ensuites. Refer to window and door schedule.
                                                                                                                                         7.01.00 GENERAL
                                                                      Confirm size on site prior to manufacture. Install strictly as per
```

4.06.12	Exterior Window Aluminum RHS Window Frame
4.06.11	Spectrum Fin Screen Louvres Spectrum 115x17 aluminum RHS fins louvre system fixed to 115x3 Aluminium plate top and bottom fixed to underside of concreet bean / deck edge. Powdercoated finish to match joinery. Install strictly as per manufacturer's specifications and details.
	manufacturer's specifications and details. Hardware TBC by client.
	4.06.11

Spectrum (or approved similar) 150 x 40 aluminum RHS frame. Powdercoated finish to match joinery. Install strictly as per manufacturer's specifications and details.

4.06.14 Spectrum Clearspan Face Hung Aluminium Fin Balustrade Spectrum Clearspan Face Hung Aluminium Fin Balustrade on Castaway bracket. 40x20 Balusters to 1000 AFFL. No Handrail. Powdercoated finish to match joinery. Install strictly as per

manufacturer's specifications and details. 4.07.00 INSULATION

Autex Greenstuff R2.2 Wall insulation (90mm), or similar with equivalent R-value, installed as per manufacturer's specifications

4.07.02 R3.2 Ceiling Insulation Autex Greenstuff R3.2 ceiling insulation (200mm), or similar with equivalent R-value, installed as per manufacturer's specifications and instructions. Ensure 25mm clearance between top of insulation and underside of roofing.

4.07.03 R1.3 Wall Insulation (Strapping) Autex Greenstuff Masonry Blanket R1.3 / 40mm, or similar with equivalent R-value. Wall strapping insulation (45mm) installed as per manufacturer's specifications and instructions. Ensure timber strapping system as per keynote: 3.02.04 Timber Strapping

R2.5 Midfloor Insulation Autex Greenstuff R2.5 Wall / 100mm used in Midfloor insulation, or 7.03.00 ELECTRICAL similar with equivalent R-value. STC 43 insulation installed as per

manufacturer's specifications and instructions.

4.08.01 Sealants, Mastics and Fillers All sealants, mastics and fillers are to be compatible with all materials and finishes. Contractor to check and confirm prior to installation. Install strictly as per manufacturer's specifications and

7.04.01

balcony cupboards.

7.05.01 Extract Fan

7.06.00 SECURITY/ALARM

7.06.01 Smoke Detectors

7.05.00 VENTILATION/AIRCONDITIONING

with Fire Report and drawings.

7.07.00 COMMUNICATIONS/NETWORK

7.07.02 New Phone Connection

EXTERIOR

8.02.00 PAVEMENT/DRIVEWAY/ACCESS

Selected Concrete Pavers

New Concrete Paving

8.01.00 LANDSCAPE PLANTING

8.01.02 Landscape Finishing

requirements.

for details

8.04.06 Letterbox

8.04.07 Bin Enclosure

8.03.00 LANDSCAPE STRUCTURES

8.03.01 Cirtex Timber Retaining Walls

Resource Consent drawings.

drawings. Client supplied

each unit.

to be design build by HVAC contractor.

4.08.02 PEF & Sealant PEF Backing rod and Sealant. Ensure all laps and overhangs comply with E2/AS1. Install strictly as per manufacturer's specifications and details.

4.08.03 Firetherm Rainbar 60-25 Cavity Fire Stop Firetherm Rainbar 60-25: 60 minute intumescent composite cavity Fire Stop for cavities up to 25mm. Installed to manufacturers requirements to all nominal 20mm cavities between horizontal and vertical unit separations

4.08.05 Fire rated sealant Approved fire rated sealant to all penetrations and connections as per details. Install strictly as per manufacturer's specifications and

4.08.06 Firetherm Rainbar 60-50 Cavity Fire Stop Firetherm Rainbar 60-50: 60 minute intumescent composite cavity Fire Stop for cavities up to 50mm. Installed to manufacturers requirements to all nominal 50mm cavities between horizontal and vertical unit separations.

INTERIOR

5.01.01 10mm Gib Board Lining 10mm Gib Board lining fixed horizontally or vertically over selected framing. Gib stopped to level 4min, finish for painting. Square stopped to ceiling. Install strictly as per manufacturer's specifications and details. Refer to engineer drawings for bracing locations.

10mm Gib Aqualine lining 10mm Gib Aqualine lining fixed horizontally or vertically over selected framing in wet areas. Gib stopped to level 4min. finish for painting. Square stopped to ceiling. Install strictly as per manufacturer's specifications and details. Contractor to confirm with client selected tiles are compatible with 10mm Gib Aqualine lining. Client to ensure selection of ceramic tiles does not exceed 20kg/m2 Confirm with client prior to lining installation. Consult with contractor and designer prior to lining installation if selected tiles exceed permitted weight.

5.01.05 13mm Gib Fyreline 13mm Gib Fyreline Board lining fixed horizontally or vertically over selected framing. Gib stopped to level 4min. finish for painting. Square stopped to ceiling. Install strictly as per manufacturer's specifications and details.

5.02.00 CEILING LINING

5.02.01 13mm Gib Ceiling Lining 13mm Gib Ceiling lining fixed to Suspended Rondo or DONN metal grid system @ 600crs. Gib stopped to level 4, finish for painting. Square stopped at wall. Install strictly as per manufacturer's specifications and details.

13mm Gib Aqualine Ceiling Lining 13mm Gib Aqualine ceiling lining fixed to Suspended Rondo or DONN metal grid system @ 600crs. Gib stopped to level 4, finish for painting. Square stopped at wall. Install strictly as per manufacturer's 8.04.00 MISC specifications and details.

5.04.01 Handrail to Stairs Spectrum Clearspan Aluminium Balustrade and Handrail to stairs as per NZBC D1 1 January 2017 Amendment 6.

Timber Skirting Finger jointed pine skirting, 60 x 10 single bevel pine. Paint finish. Install skirting board to overlay surface as per acoustic report. Gap to be sealed with sealant to match skirting.

Interior Door Timber Reveals 30mm rebated pine jamb reveals. Paint quality finish

FINISH

6.01.00 FLOOR FINISH 6.01.02 Carpet on Underlay

Selected ceramic floor tiles on waterproof membrane on Jacobsens Regupol 4515-S acoustic underlay. Install strictly as per manufacturer's specifications and details.

Selected wall tiles on waterproof membrane installed as per manufacturers specifications. Refer to Interior design drawings for location. Wall tiles selection TBC by client. Contractor to confirm with client selected tiles are compatible with 10mm Gib Aqualine lining. Client to ensure selection of ceramic tiles does not exceed 20kg/m2 Confirm with client prior to lining installation. Consult with contractor and designer prior to lining installation if selected tiles exceed permitted weight.

SERVICES

as required.

7.01.01 General Drainage and Services Notes Locate existing power, water, telephone and sanitary drainage services. Allow to inform network operators as necessary.

7.02.00 LIQUID SUPPLY/DISPOSAL

7.02.01 Storm Water and Waste Water Requirements

Refer Crang Civil civil drawings and reports for stormwater and waste water requirements. 7.02.02 Water supply Refer to Crang Civil civil drawings and reports for location of water

supply and meter locations for each unit. 7.02.03 New Water Connection Provide new water connection to new units from existing supply line

7.02.04 100mm uPVC Stormwater Line 100mm uPVC stormwater to connect into main line. Refer to Crang Civil civil drawings and reports for site and drainage information. Ensure all heights and falls are checked against the connection

height on site prior to commencement of works. 100mm uPVC Sewer Line 100mm uPVC sewer line to connect into main line. Refer to Crang Civil civil drawings and reports for site and drainage information. Ensure all heights and falls are checked against the connection

7.02.20 HWC Rheem 177litre 1720x488 HWC. Install strictly as per manufacturer's

height on site prior to commencement of works.

specifications and details & NZ Seismic requirements 7.02.42 Acrylic Showers Acryclic based showers. Ensure waterproof membrane and

components are installed strictly as per manufacturer's specifications and details. Confirm size of base on site and timber pack surrounding walls as required to fit standard sized based. Confirm all dimensions on site.

STRUCTURAL ENGINEERING PLANS & SPECIFICATION BY HFC GROUP TRUSS MANUFACTURER'S PLANS & SPECIFICATION BY PLACEMAKERS FIRE ENGINEERING DESIGN REPORT BY HFC GROUP ACOUSTIC REPORT BY HEAGLEY ACOUSTICS STORMWATER & SANITARY CONNECTION POINTS BY CRANG CIVIL

PLANS TO BE READ IN CONJUNCTION WITH THE FOLLOWING:

7.03.01 New Power Connection TIMBER GRADE/TREATMENT: Refer to Crang Civil drawings for location of power supply and refer to architectural plans for Switchboard and Meter Board locations for **DECK FOUNDATION & FRAMING** each unit. Refer to architectural plans for power outlet and light switch locations for each unit. 7.04.00 HEATING/COOLING Heatpump Selected heatpump. Installation in accordance with manufacturers

specifications. Indicative location shown only. Outdoor unit located in

Provide fan/ducting extraction fans to all bathrooms, ensuites and

extract fan is located above a shower or bath, ensure extract fan is

system including Fan specification, pipe type and diameter and run

Provide domestic smoke alarms as required to F7/AS1 Cl 3.1 of the

space. Refer to the Finishes Plans for locations. Read in conjunction

Refer to architecural plans for location of New Phone connection for

Refer to landscaping plans by nominated consultant, refer Bonair

100mm thick 17.5Mpa concrete placed on 50mm min. compacted

Landscape Architects plans. Paver FFL to min, 150mm lower than

Cirtex Timber Retaining Walls to max height of 1m. 150x50 H4 Pinus

190mm thk Masonry Retaining Walls. Stack Bond, plaster Finish,

Max Height 1m TBC. Refer to HFC Structural Engineers Drawings

Freestanding Spectrum Aluminium Vertical Batten Fence and Gate.

Letterboxes for each unit with type, location and finish as per

Bin Enclosure for each unit with location as per Resource Consent

hard fill. Finish as per Landscape Plan by nominated consultant.

refer Bonair developments for specific landscape finishing

Selected concrete pavers installed in accordance with the

radiata roughsawn rails and 75x50 top rail. All installed in

accordance with manufacturers requirements

8.03.10 Spectrum Exterior Aluminum Vertical Batten Fence &

Powdercoat finish as per Resource Consent drawings.

200 Series Masonry Retaining Walls

developments for specific landscape finishing requirements.

NZBC. Detectors to be placed within 3m of any possible sleeping

shower rated. Extract fun duct runs indicative only. Ectract Fan

internal WC's. Fans to be switched on when light is activated. Where

<u> Timber species and grade</u> <u>Treatment</u> Building piles/poles: H5 CCA Radiata Pine Retaining Wall uprights: Radiata Pine H5 CCA Retaining Wall horizontal timber: H4 CCA H3.2 CCA Bearers: Pinex verified SG8 Deck floor joists: Laserframe SG8 H1.2 Boron **EXTERIOR WALL FRAMING** <u>Treatment</u> Timber species and grade Exterior walls: Laserframe SG8 H1.2 Boron Exterior joinery sill plate: Laserframe SG8 H3.1 LOSP Laserframe SG8 H3.1 LOSP Exterior bottom plates: H3.1 LOSP Laserframe SG8 Parapets: Laserframe SG8 H1.2 Boron Laserframe SG8 H1.2 Boron Packers under parapet caps: Enclosed decks and balconies: Laserframe SG8 H1.2 Boron Cavity battens: Radiata pine merchantable H3.1 LOSP Timber grade <u>Treatment</u> Trusses Laserframe SG8 H1.2 Boron Purlins: Laserframe SG8 H1.2 Boron Ceiling joists: Laserframe SG8 H1.2 Boron Valley boards: Radiata Pine merchantable H1.2 Boron Enclosed flat roof framing: Laserframe SG8 H1.2 Boron

<u>LAMINATED VENEER LUMBER (LVL)</u> Futurebuild

INTERIOR FRAMING Timber species and grade <u>Treatment</u> Non structural walls: Laserframe SG8 H1.2 Boron Structural and braced walls: Laserframe SG8 H1.2 Boron Laserframe SG8 H1.2 Boron Lintels Surrounding wet area walls: Laserframe SG8 H1.2 Boron

<u> Type</u>

HyONE H3.1 LOSP

EXTERIOR FINISHING TIMBERS Timber species and grade <u>Treatment</u> <u>Member</u> Weatherboards Pinex finger jointed pre-primed H3.1 LOS Fascia/barge boards: Pinex finger jointed pre-primed H3.1 LOSP Soffit lining: H3.1 LOSP Exterior mouldings Pinex finger jointed pre-primed H3.1 LOSP Timber Windows/Doors: Radiata Pine H3.1 LOSP

INTERIOR FINISHING TIMBERS **Treatment** Timber species Architraves None Pinex pine Skirtings: Pinex pine Exterior walls Door/window Jambs: Radiata Pine merchantable H_{3.1} LOSP Interior walls Door/window Jambs: Pinex pine

POWER / TELEPHONE / WATER SERVICES / GAS:

All drainage shall be in accordance with the local council. The contractor shall liaise with and co-operate with all Network Utility Operators.

All plumbing and drainage in accordance with AS/NZS 3500.2 or G13/AS1 plumbing and drainage code.

Check and verify all dimensions on site before commencing work. The contractor shall locate all existing services at the proposed connection points prior to commencing work. The connections shall be done in accordance with the local council requirements.

The contractor shall take all necessary precautions during excavation to avoid any disruption of existing services. All existing services shall be reinstated to their original condition and to the satisfaction of the Architect or Engineer.

Ensure all stormwater and sewer piping under driveways has a depth of cover of

375mm and that the bedding and fill material complies with E1/AS1 figure 13(b)

ALL WORK TO BE CARRY OUT IN ACCORDANCE WITH THE NEW ZEALAND

ALL ARCHITECTURAL DRAWINGS TO BE **READ IN CONJUNCTION WITH ENGINEERING** DRAWINGS BY HFC GROUP LTD



Auckland **p**:+64 9 309 6032 info@creativearch.co.nz www.creativearch.co.nz DESIGN AND DRAWINGS ARE COPYRIGHT OF CREATIVE ARCH LTD CONTRACTOR TO VERIFY ALL DIMENSIONS ON SITE BEFORE COMMENCING ALL RESTRICTED BUILDING WORK TO BE CARRIED OUT BY LICENSED BUILDING PRACTITIONERS project title: Proposed Development for: **Bonair Developments** 153 Bonair Cresent (Block B)

Silverdale, Auckland sheet title: Scope of Works & Keynotes drawn: **KN** checked: **JM** dwg n#:

liob n#: date created date plotted:


scale:

29 Nixon St.

PO Box 78 282 Grey Lynn

2/7/2019 2/7/2019 BC Block B rev n#: 1:1 @ A1 NOTE: Drawings are ½ scale @ A3

CAD ref: KrisindaBIM Server: CAL-BIM - BIMcloud Basic for ARCHICAD 21/Creative Arch/2005_Broadway Property Group_BLOCK B_BC

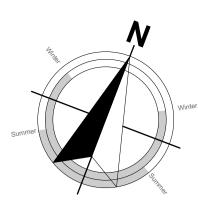

SITE DESCRIPTION:


153 Bonair Cresent (Block B)
Silverdale

LOTS: 1 DP: 525711 CT: 846464 AREA: 4787m²


Auckland

ZONE: Millwater South Precinct - Single House Zone

Wind Zone: H
EQ Zone: 1
Exposure Zone: C

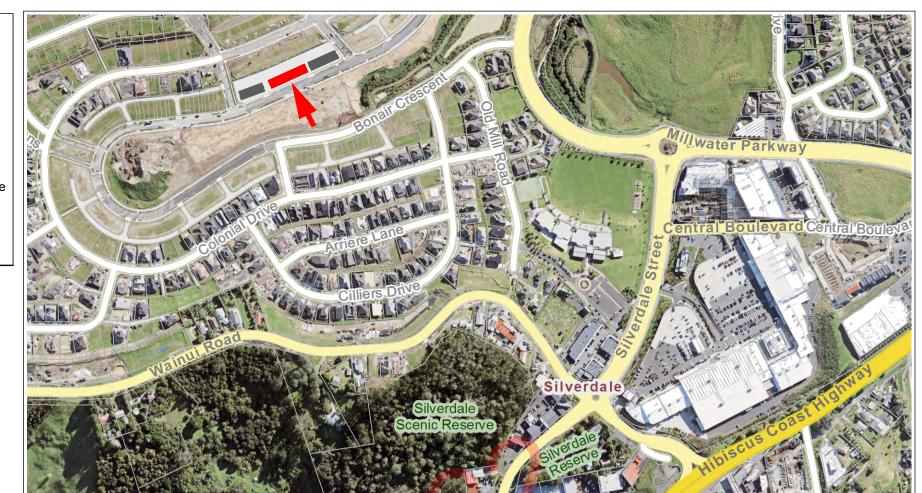

Site Location Plan

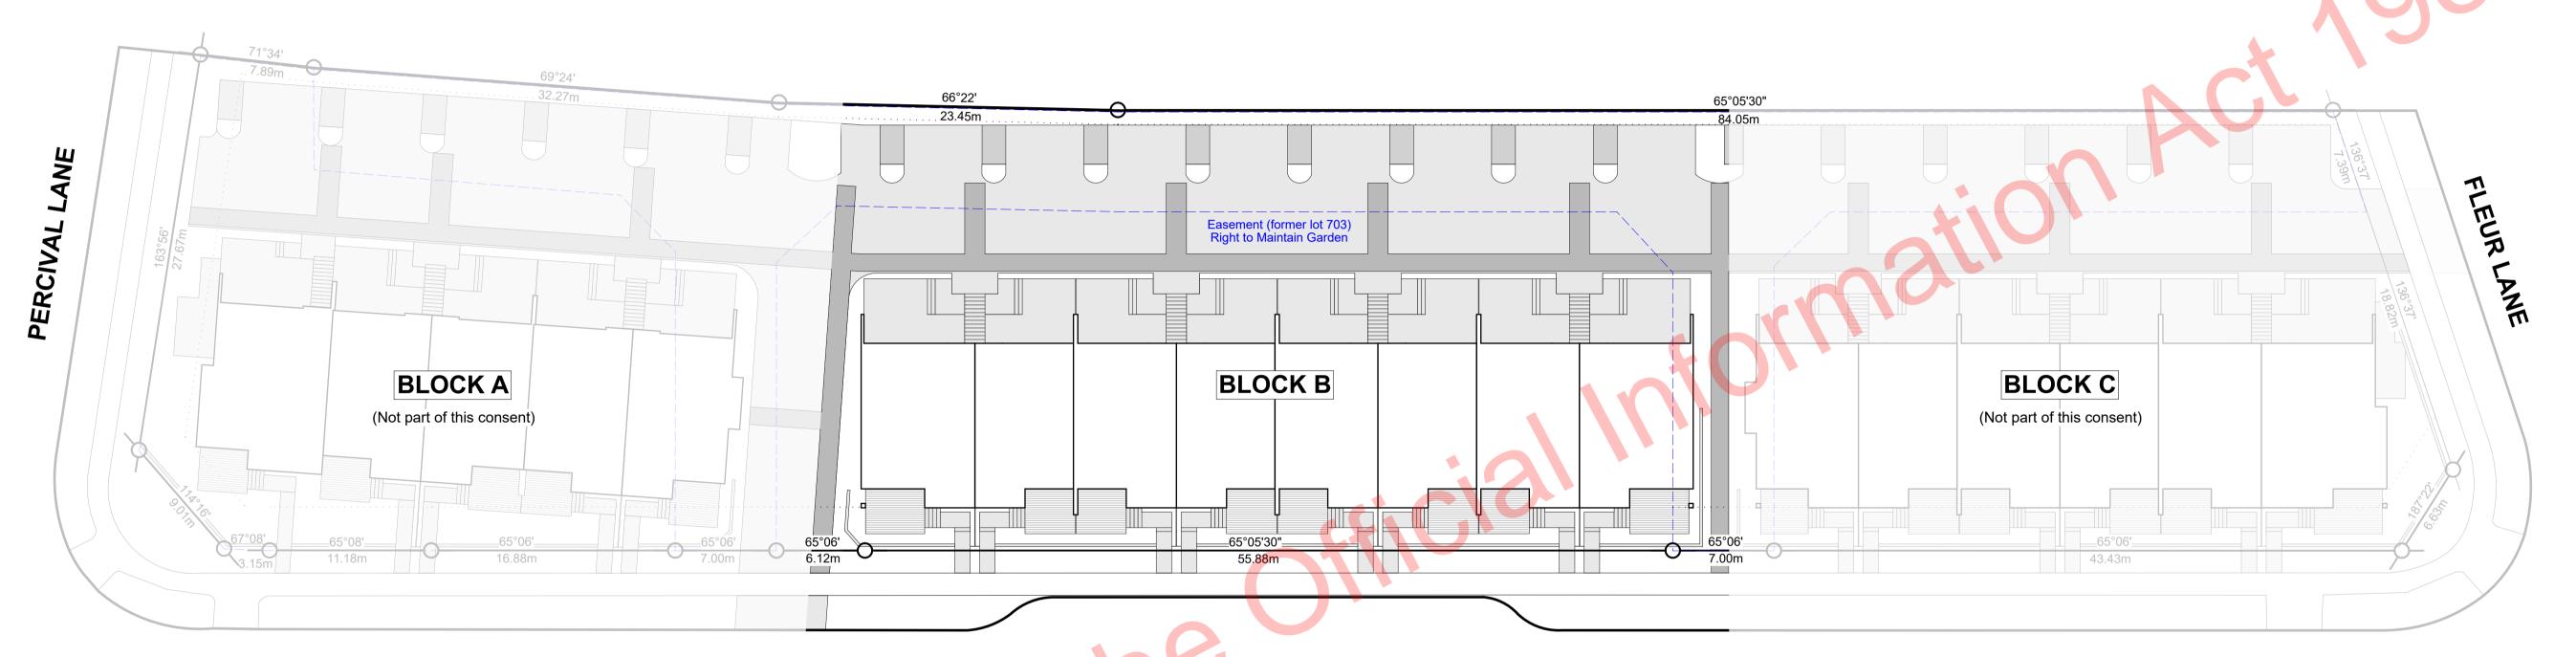

BONAIR CRESCENT

Released

ALL ARCHITECTURAL DRAWINGS TO BE READ IN CONJUNCTION WITH ENGINEERING DRAWINGS BY HFC GROUP LTD

RevID Issue ChID Comments Date

01 Building Consent 11/28/20



29 Nixon St, Grey Lynn PO Box 78 282 Grey Lynn Auckland

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DESIGN AND DRAWINGS ARE COPYRIGHT OF CREATIVE ARCH LTD

CONTRACTOR TO VERIFY ALL DIMENSIONS ON SITE BEFORE COMMENCING WORK

ALL RESTRICTED BUILDING WORK TO BE CARRIED OUT BY LICENSED BUILDING PRACTITIONERS

project title:

for:
Bonair Developments

Proposed Development for:

at:
153 Bonair Cresent (Block B)
Silverdale, Auckland

Silverdale, Aucklasheet title:
Overall Site Plan


| drawn: KN checked: JM | dwg n#: | job n#: | 2005 | date created: | 11/28/2018 | date plotted: | 2/7/2019 |

issue: BC Block B rev n#:


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NOTE: Drawings are ½ scale @ A3

CAD ref: KrisindaBIM Server: CAL-BIM - BIMcloud Basic for ARCHICAD 21/Creative Arch/2005_Broadway Property Group_BLOCK B_BC

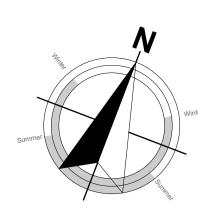


SITE DESCRIPTION: IMPERMEABLE SURFACE: LANDSCAPING REQUIREMENTS: BUILDING COVERAGE: PERMEABLE SURFACE: EARTH WORKS: PRIVATE OPEN SPACE: 153 Bonair Cresent (Block B) Maximum Building Coverage = 40% Maximum Impermeable Surface Coverage = 60% Minimum Permeable Surface Coverage = 40% Calculation per civil engineer, refer to: Private Open Space required: Front Yard Landscaping Requirements = 50% Site Area = 4787m², therefore 40% = 1915m² Site Area = $4787m^2$, therefore $60\% = 2872m^2$ Site Area = 4787m², therefore 40% = 1915m² Front yard = 650m², therefore 40% = 260m² Silverdale $20m^2$ for ground floor units, therefore 19 units x $20m^2 = 380m^2$. Auckland Crang Civil Consulting Engineers Proposed Building Coverage Proposed Roof Coverage...... Proposed Permeable Surfaces..... 831m² Proposed Front Yard Landscaping..... 352m² Project No: 1233 and $8m^2$ for first floor units, therefore 19 units x $8m^2 = 152m^2$ Proposed Drive & Footpath.... LOTS: 1 . 1592m² Block A..... ...497m² Drawing No.: C210 DP: 525711 ..786m² Dated: May 2018 Block B... (not covered by roof) POS Achieved Ground Floor: 19 units x 23.21m² = 441m² (includes slatted decks less than 1m above ground) TOTAL FRONT YARD LANDSCAPING: 352m2 (54%) CT: 846464 Block C.... Proposed Patios & Stairs... POS Achieved First Floor: 19 units x 11.86m² = 225m² AREA: 4787m² Storage Units.....70m² (not covered by roof) (COMPLIES) TOTAL PERMEABLE SURFACE: 831m² (17%) (COMPLIES) ZONE: Millwater South Precinct - Single House Zone (includes balconies over 1m above ground) (excludes slatted decks less than 1m above ground) (INFRINGES BY 1084m²) Wind Zone: TOTAL BUILDING COVERAGE: 1945m² (41%) TOTAL IMPERMEABLE SURFACE: 3956m² (83%) EQ Zone: (INFRINGES BY 30m²) (INFRINGES BY 1084m²) Exposure Zone:

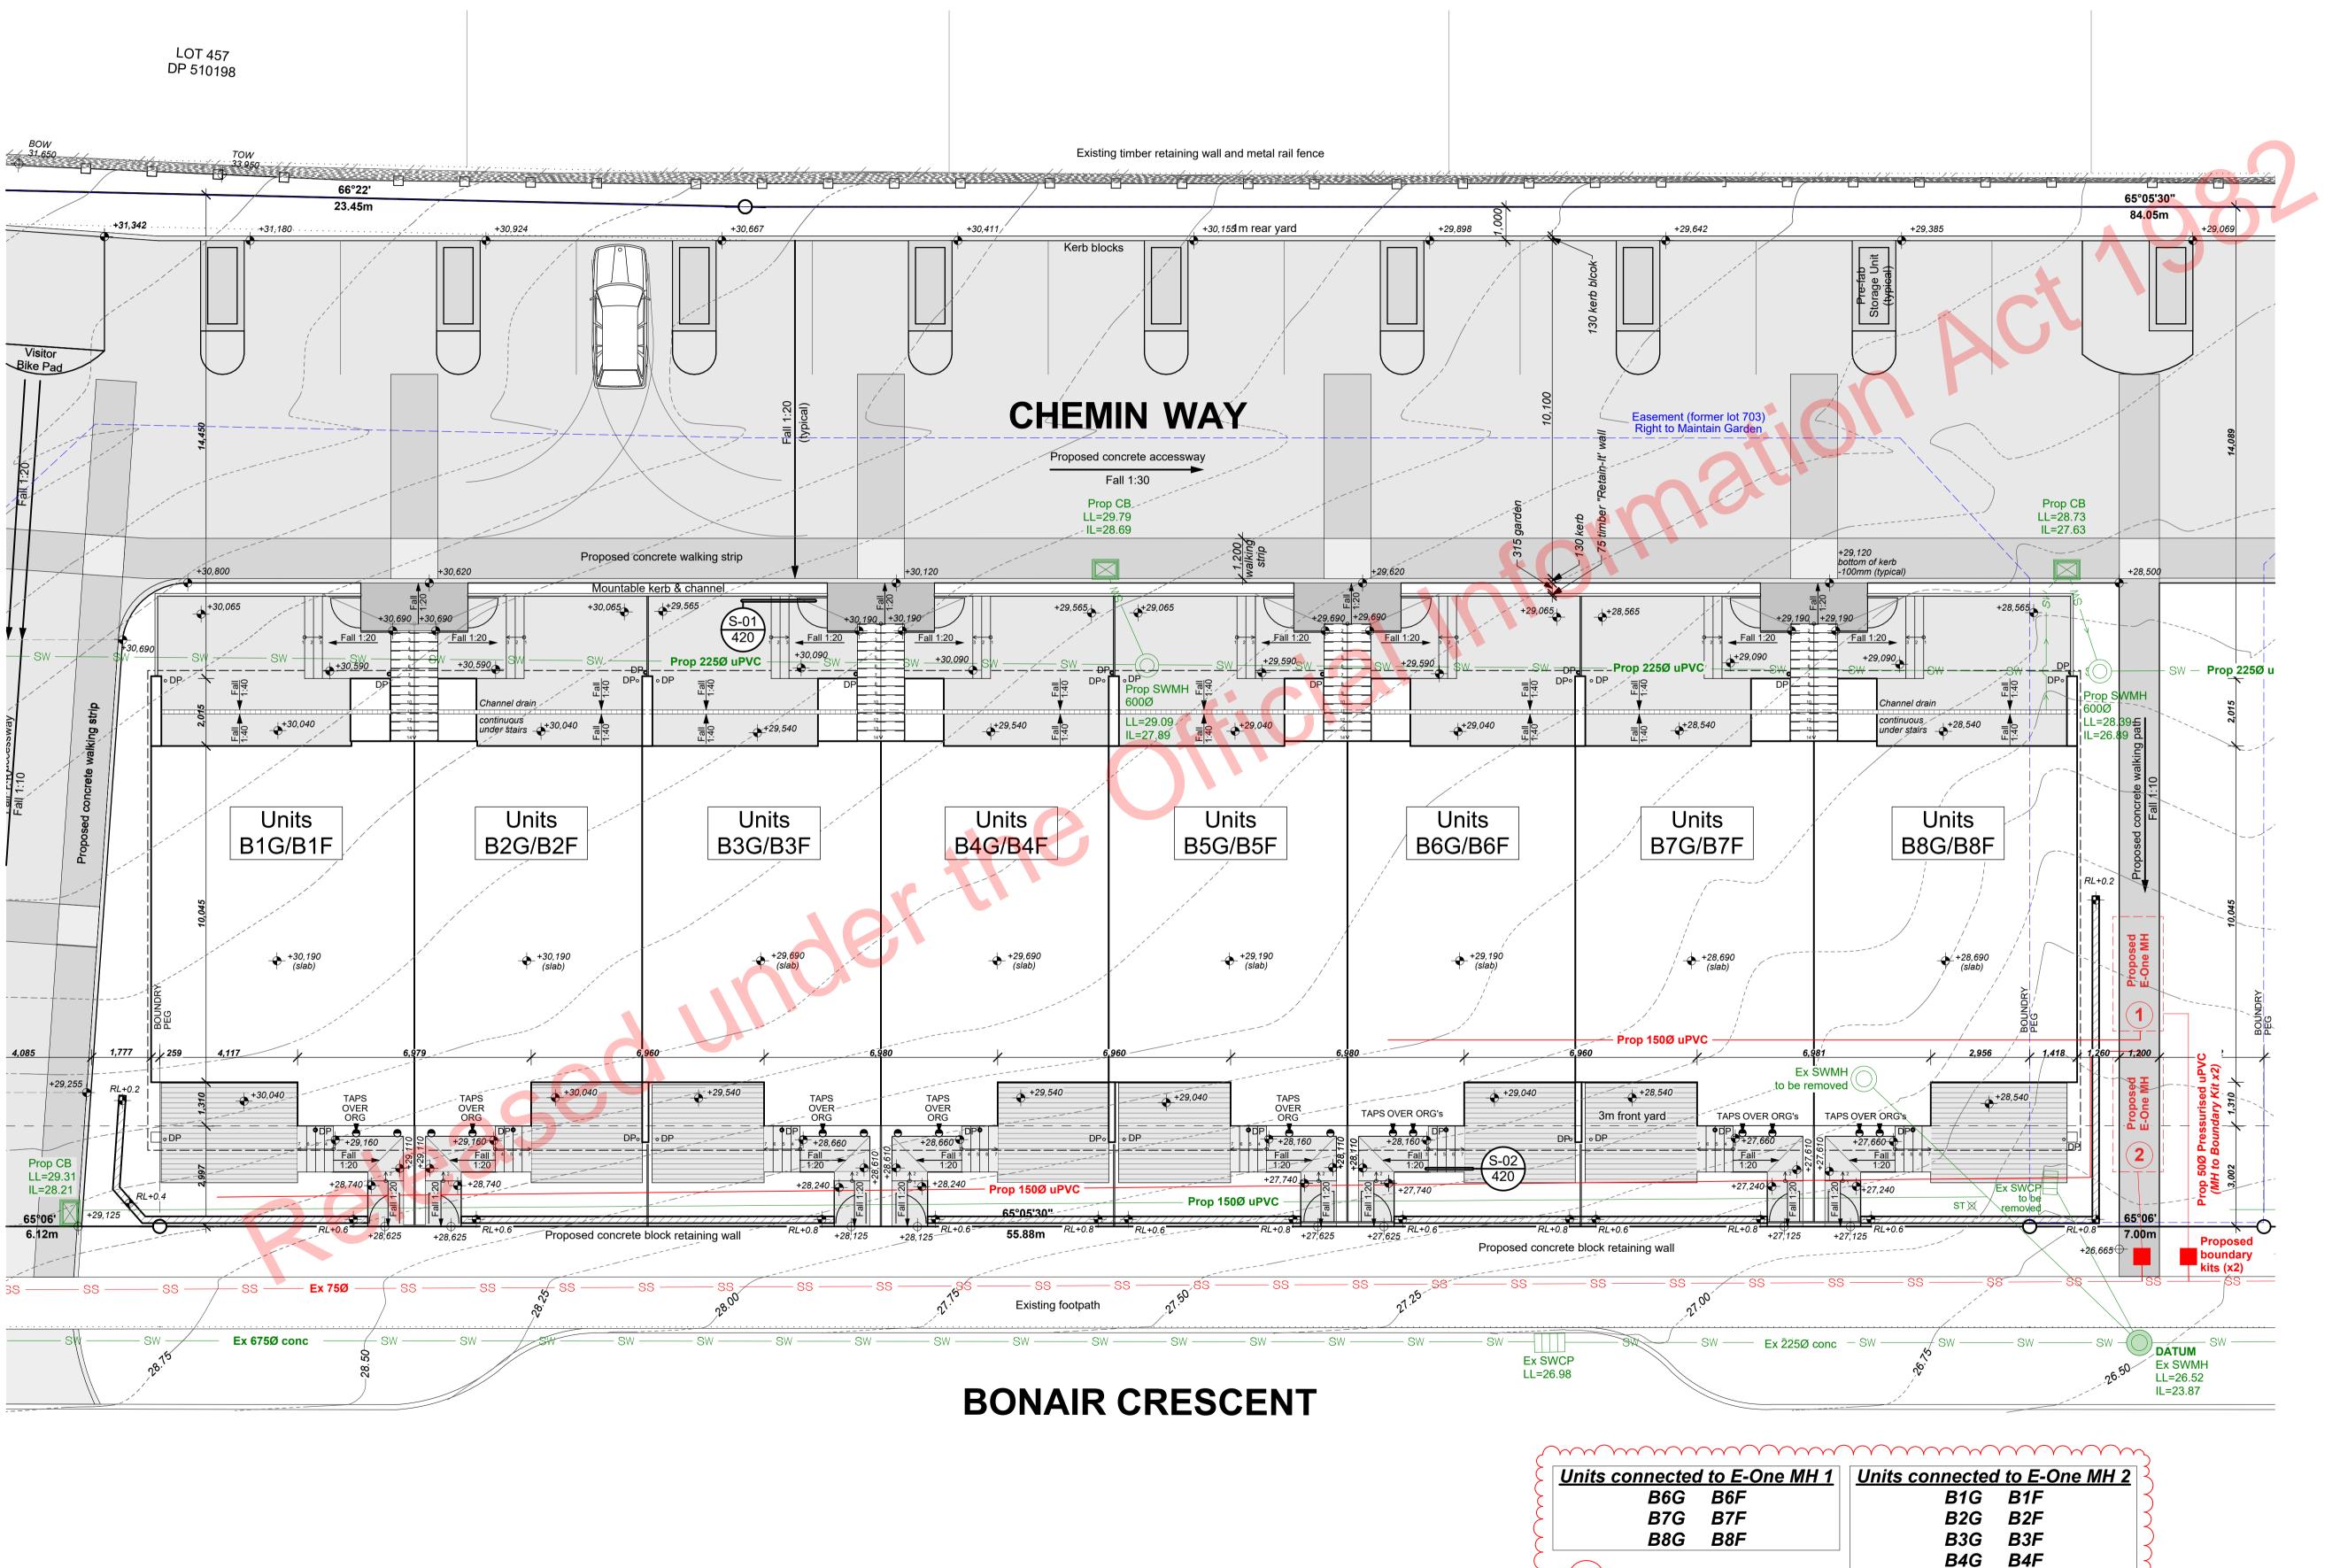

(02-2)

B5G B5F

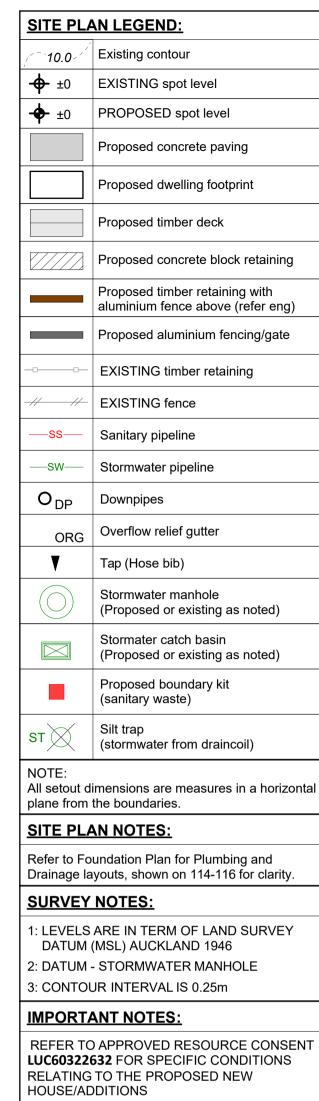



ENSURE THESE CONDITIONS ARE READ BEFORE THE COMMENCEMENT OF THE BUILDING WORK, TO ENSURE THAT THESE CONDITIONS ARE COMPLIED WITH.

REFER TO GEOTECHNICAL REPORT

RevID	Issue	ChID	Comments	Date	
01	Building Consent			11/28/2018	
02	RFI 1	02-1	Added easement	2/7/2019	
02	RELI	02-2	Clarification note added	2///2019	



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Proposed Development for:

Bonair Developments


153 Bonair Cresent (Block B) Silverdale, Auckland


sheet title:

Proposed Site Plan

drawn: KN checked: JM dwg n#: 2005 101 2/7/2019 2/7/2019 BC Block B rev n#:

NOTE: Drawings are ½ scale @ A3 CAD ref: KrisindaBIM Server: CAL-BIM - BIMcloud Basic for ARCHICAD 21/Creative Arch/2005_Broadway Property Group_BLOCK B_BC

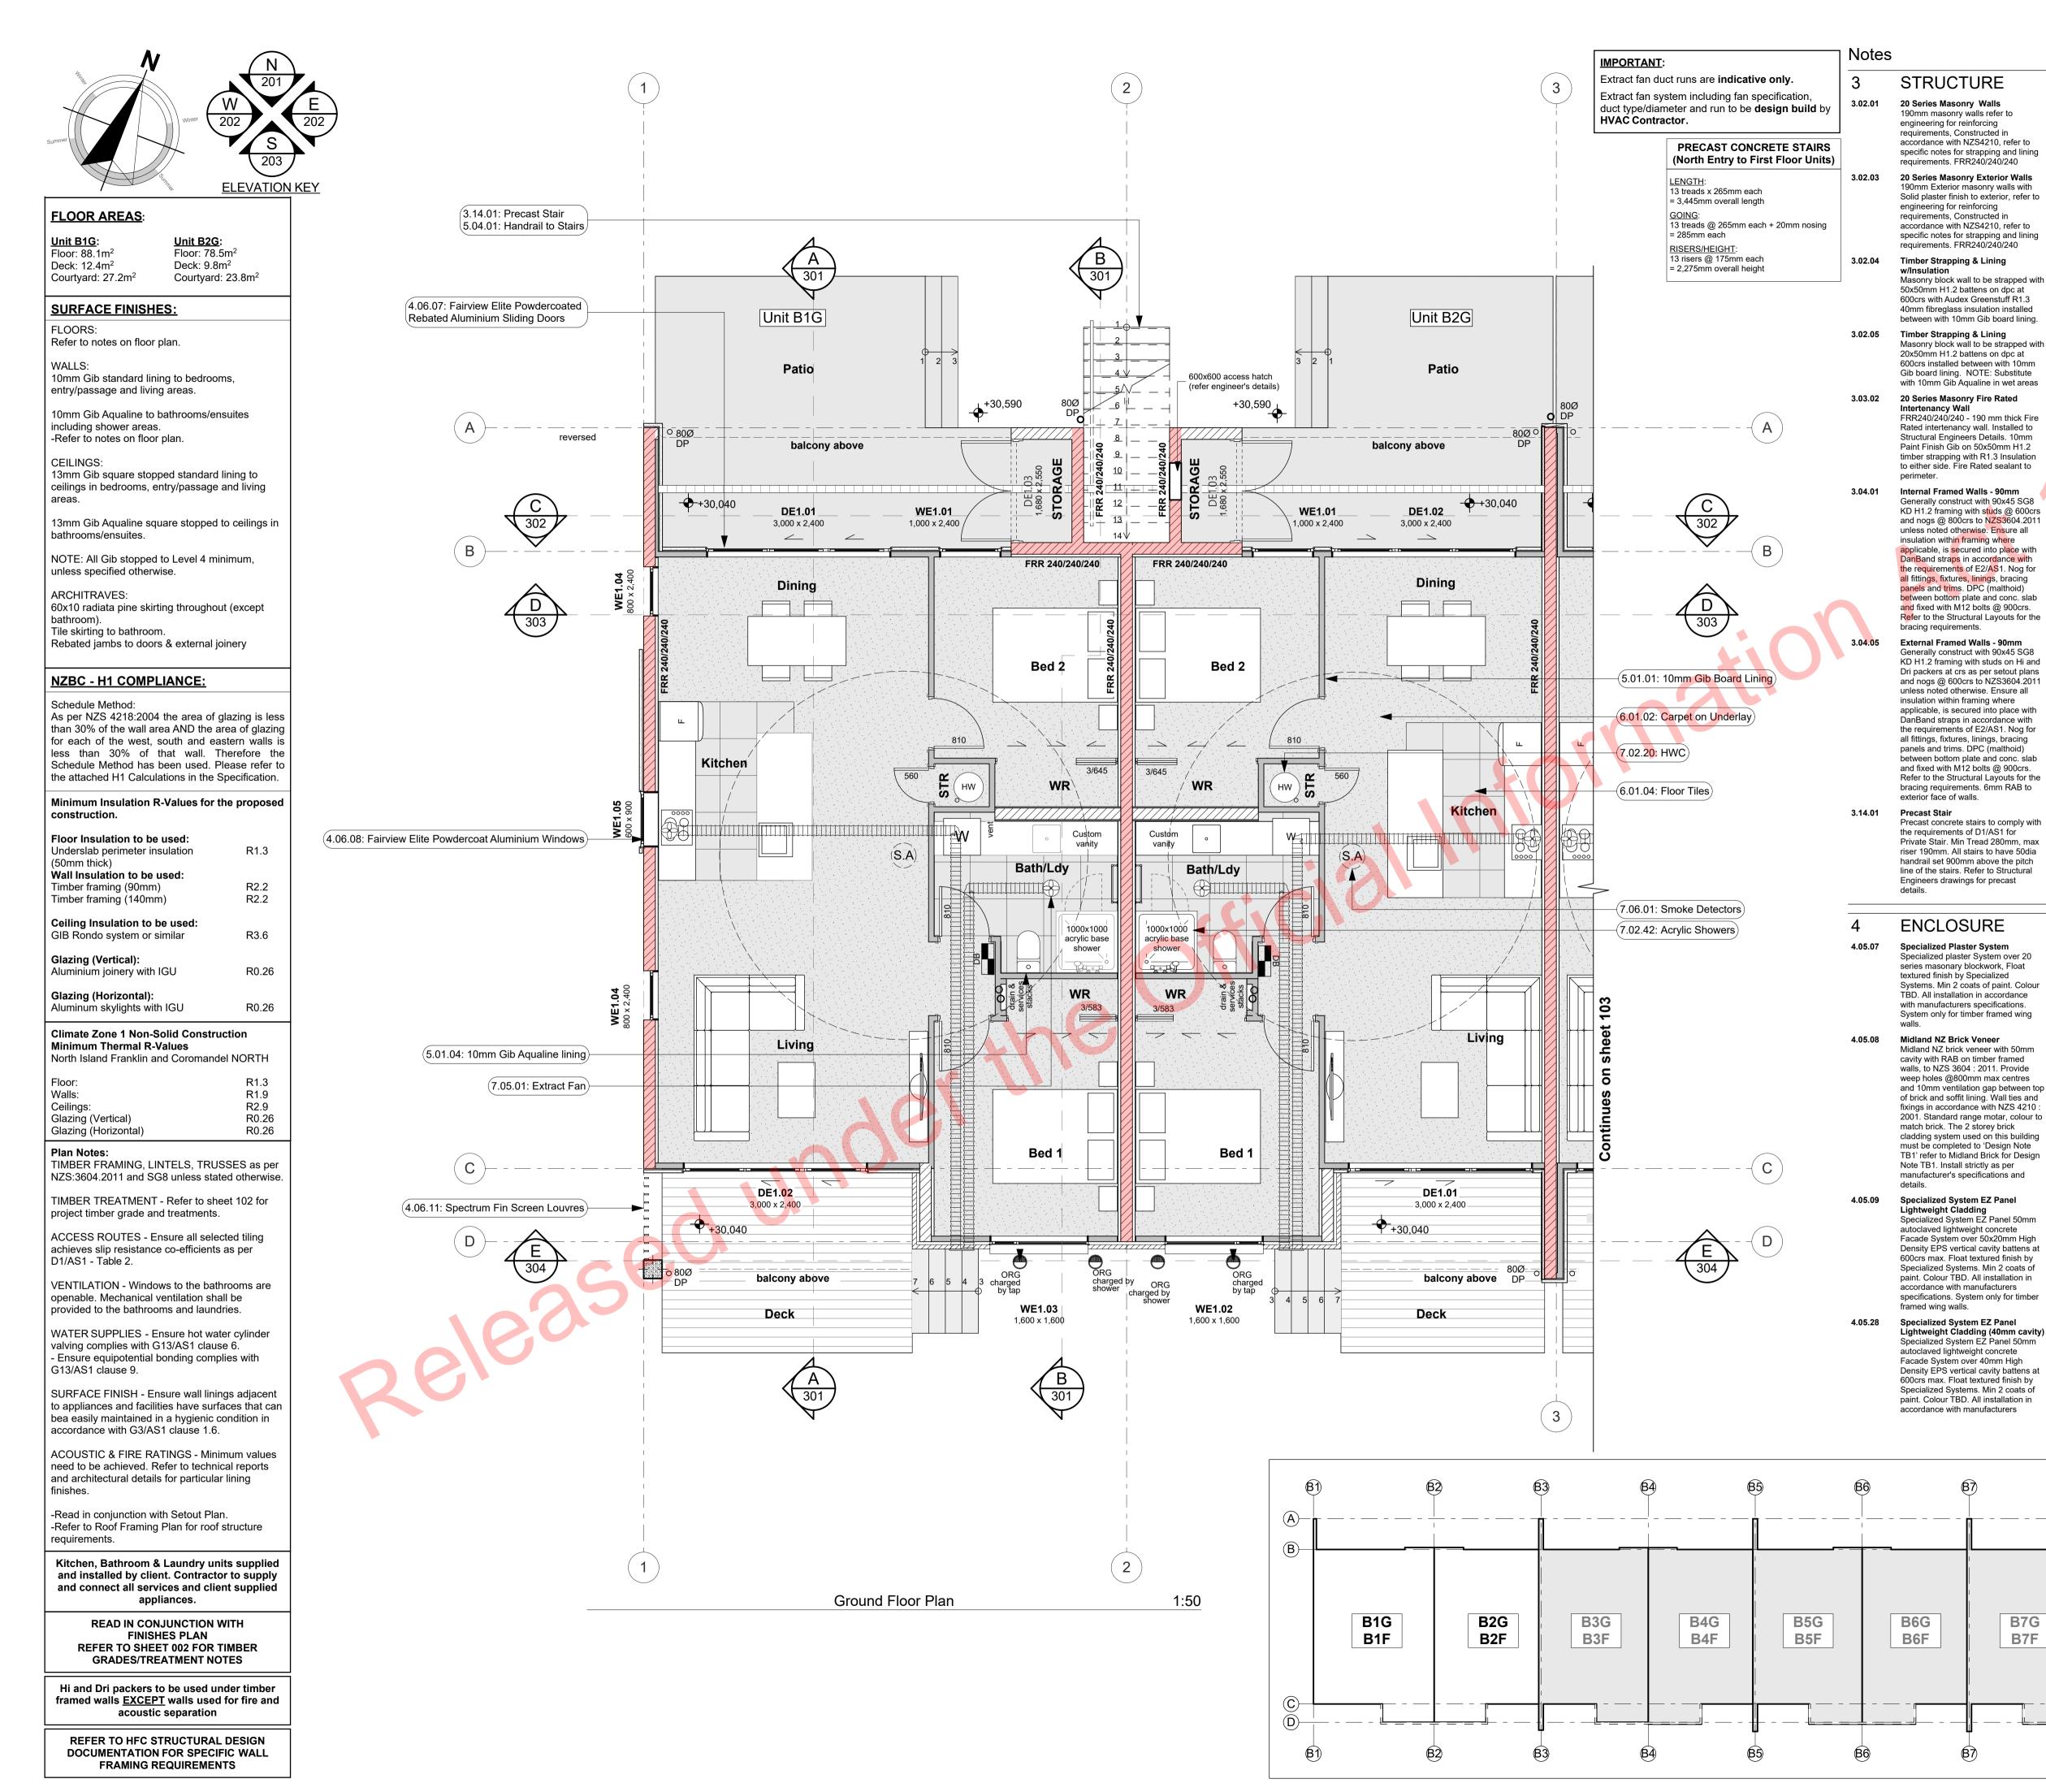

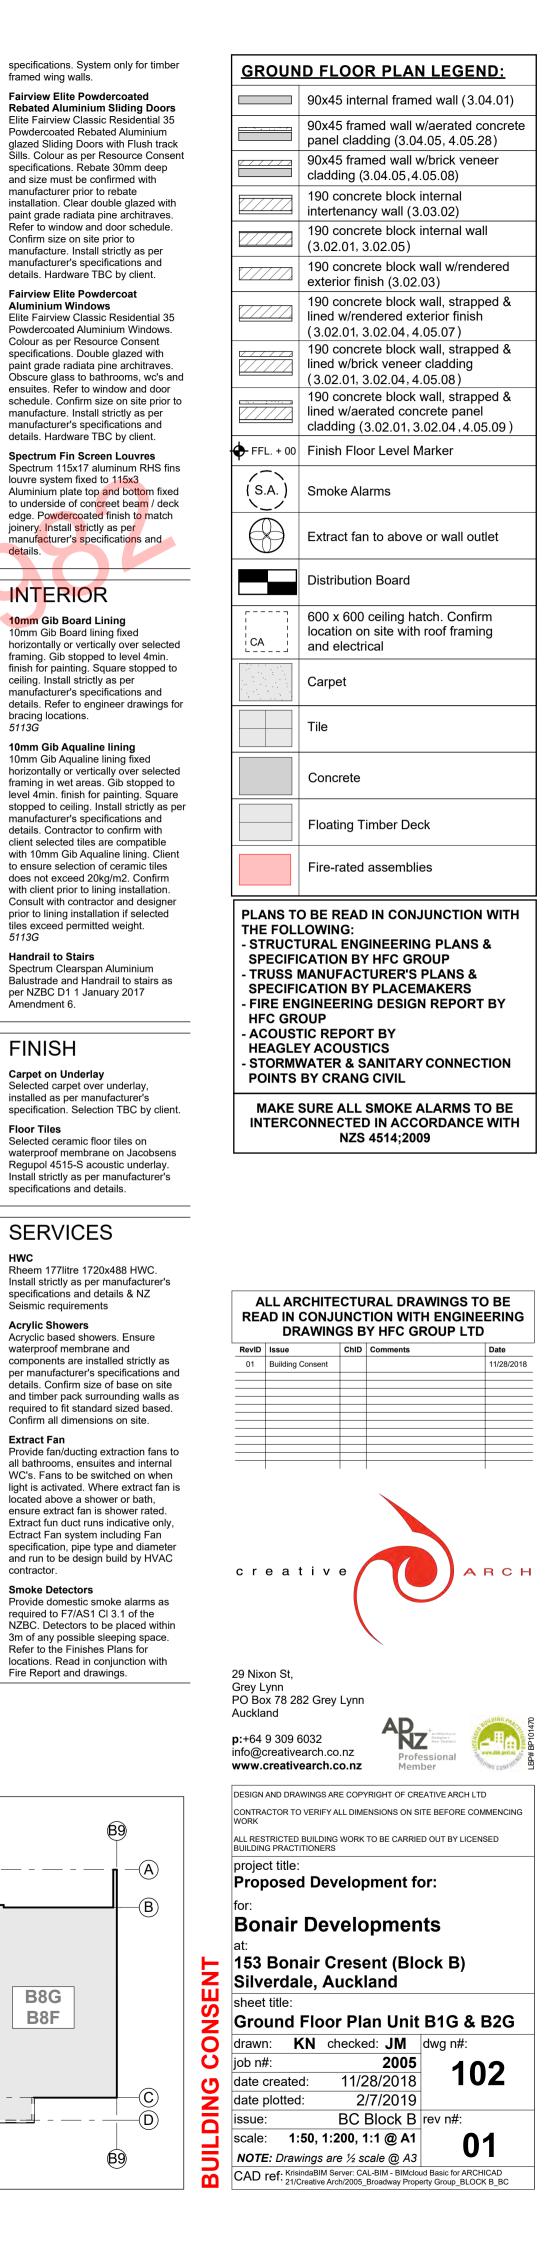

framed wing walls.

INTERIOR

bracing locations.

Handrail to Stairs

Amendment 6.

FINISH

Floor Tiles

Carpet on Underlay

Seismic requirements

Acrylic Showers

Extract Fan

contractor.


B7G


B7F


Smoke Detectors


B8G


B8F

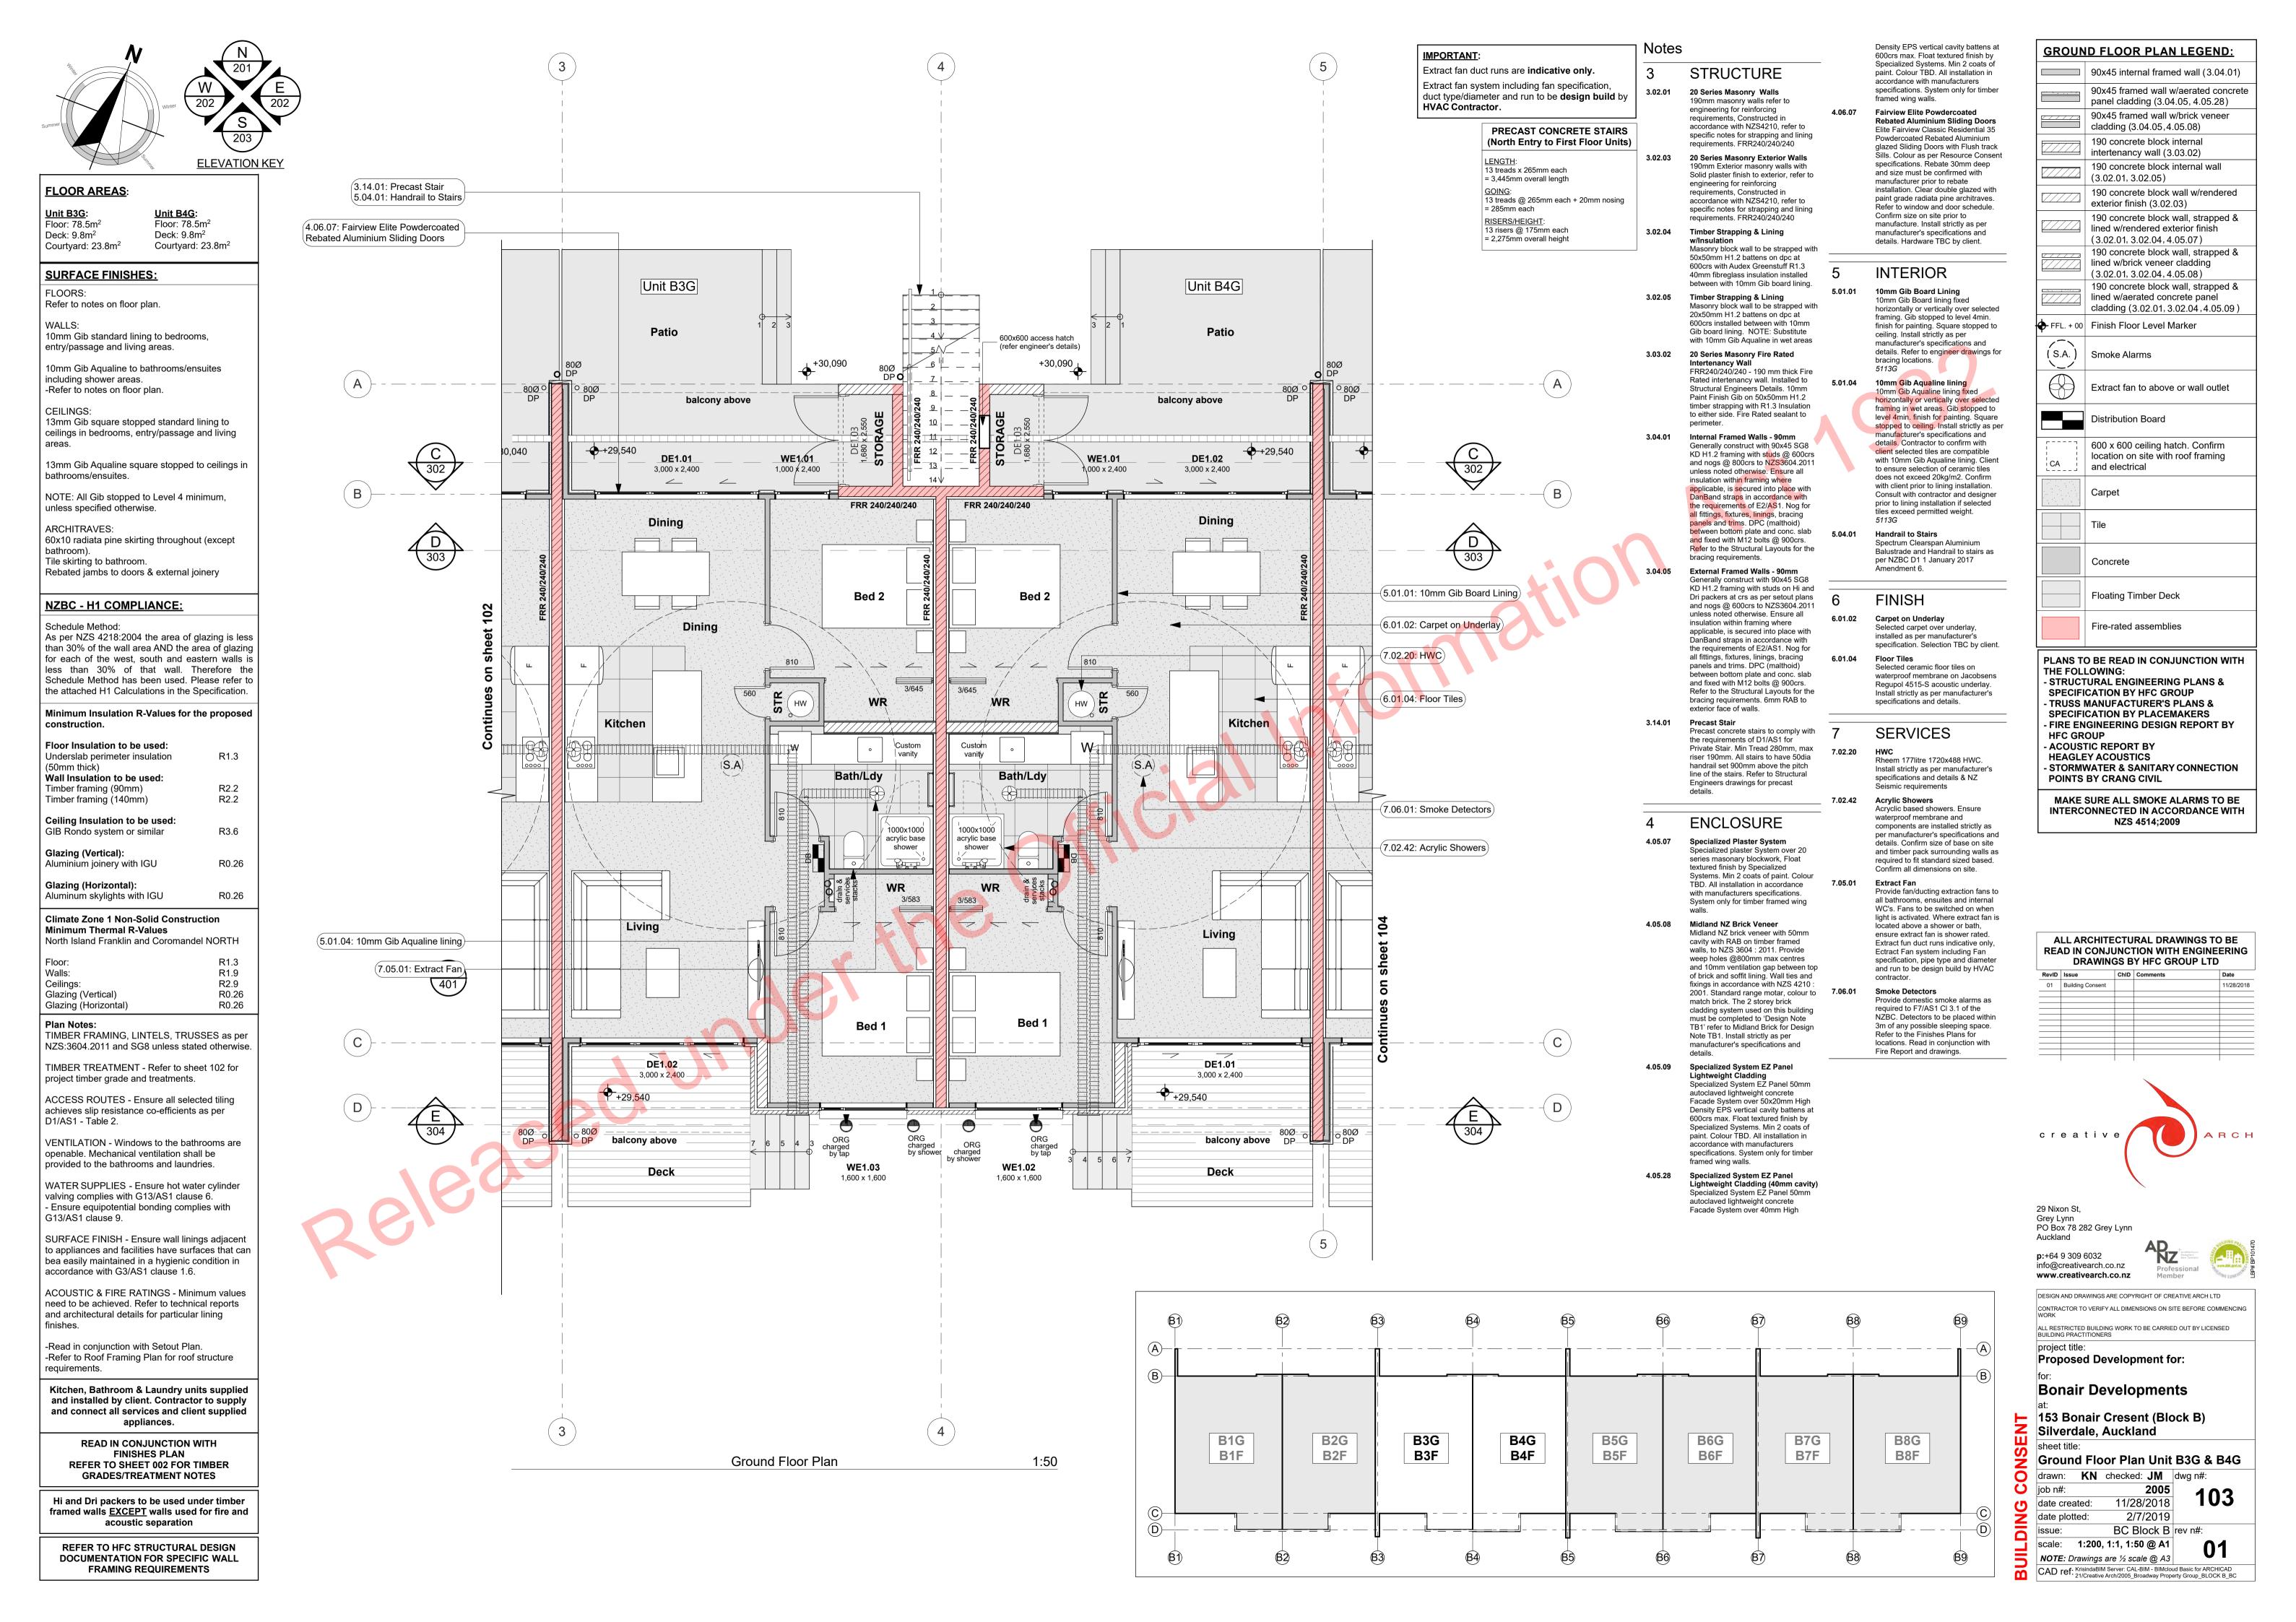


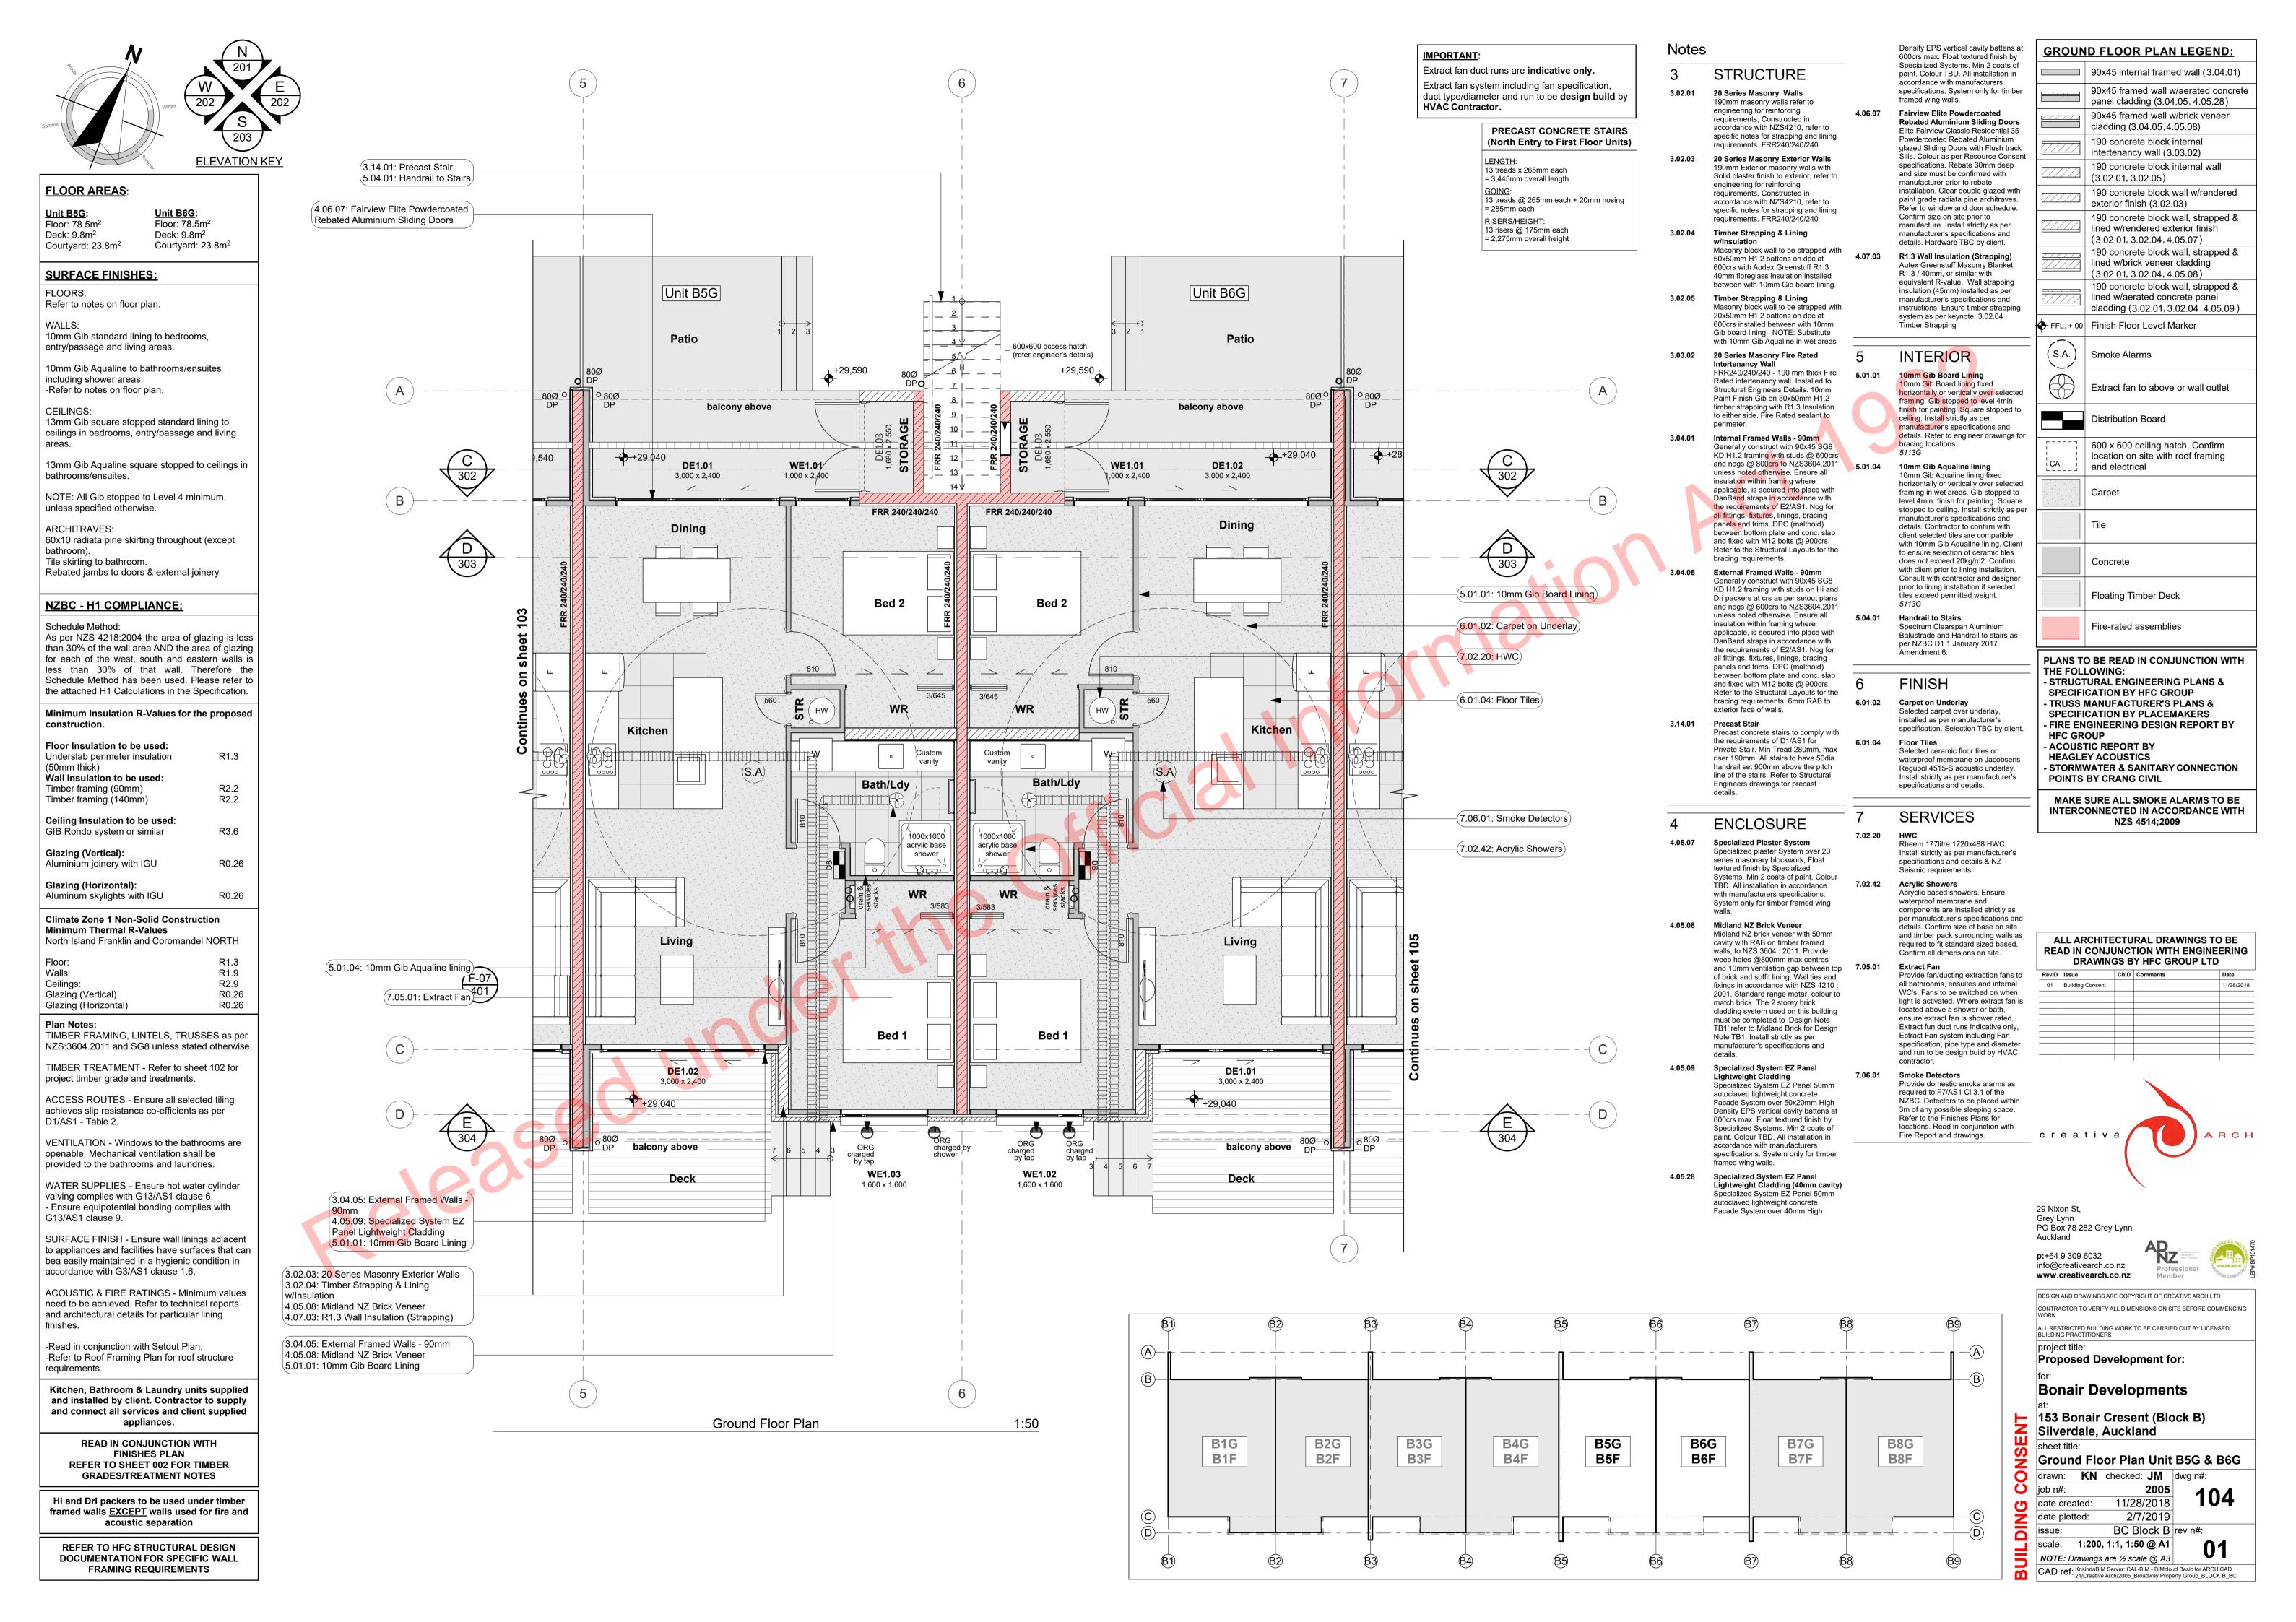


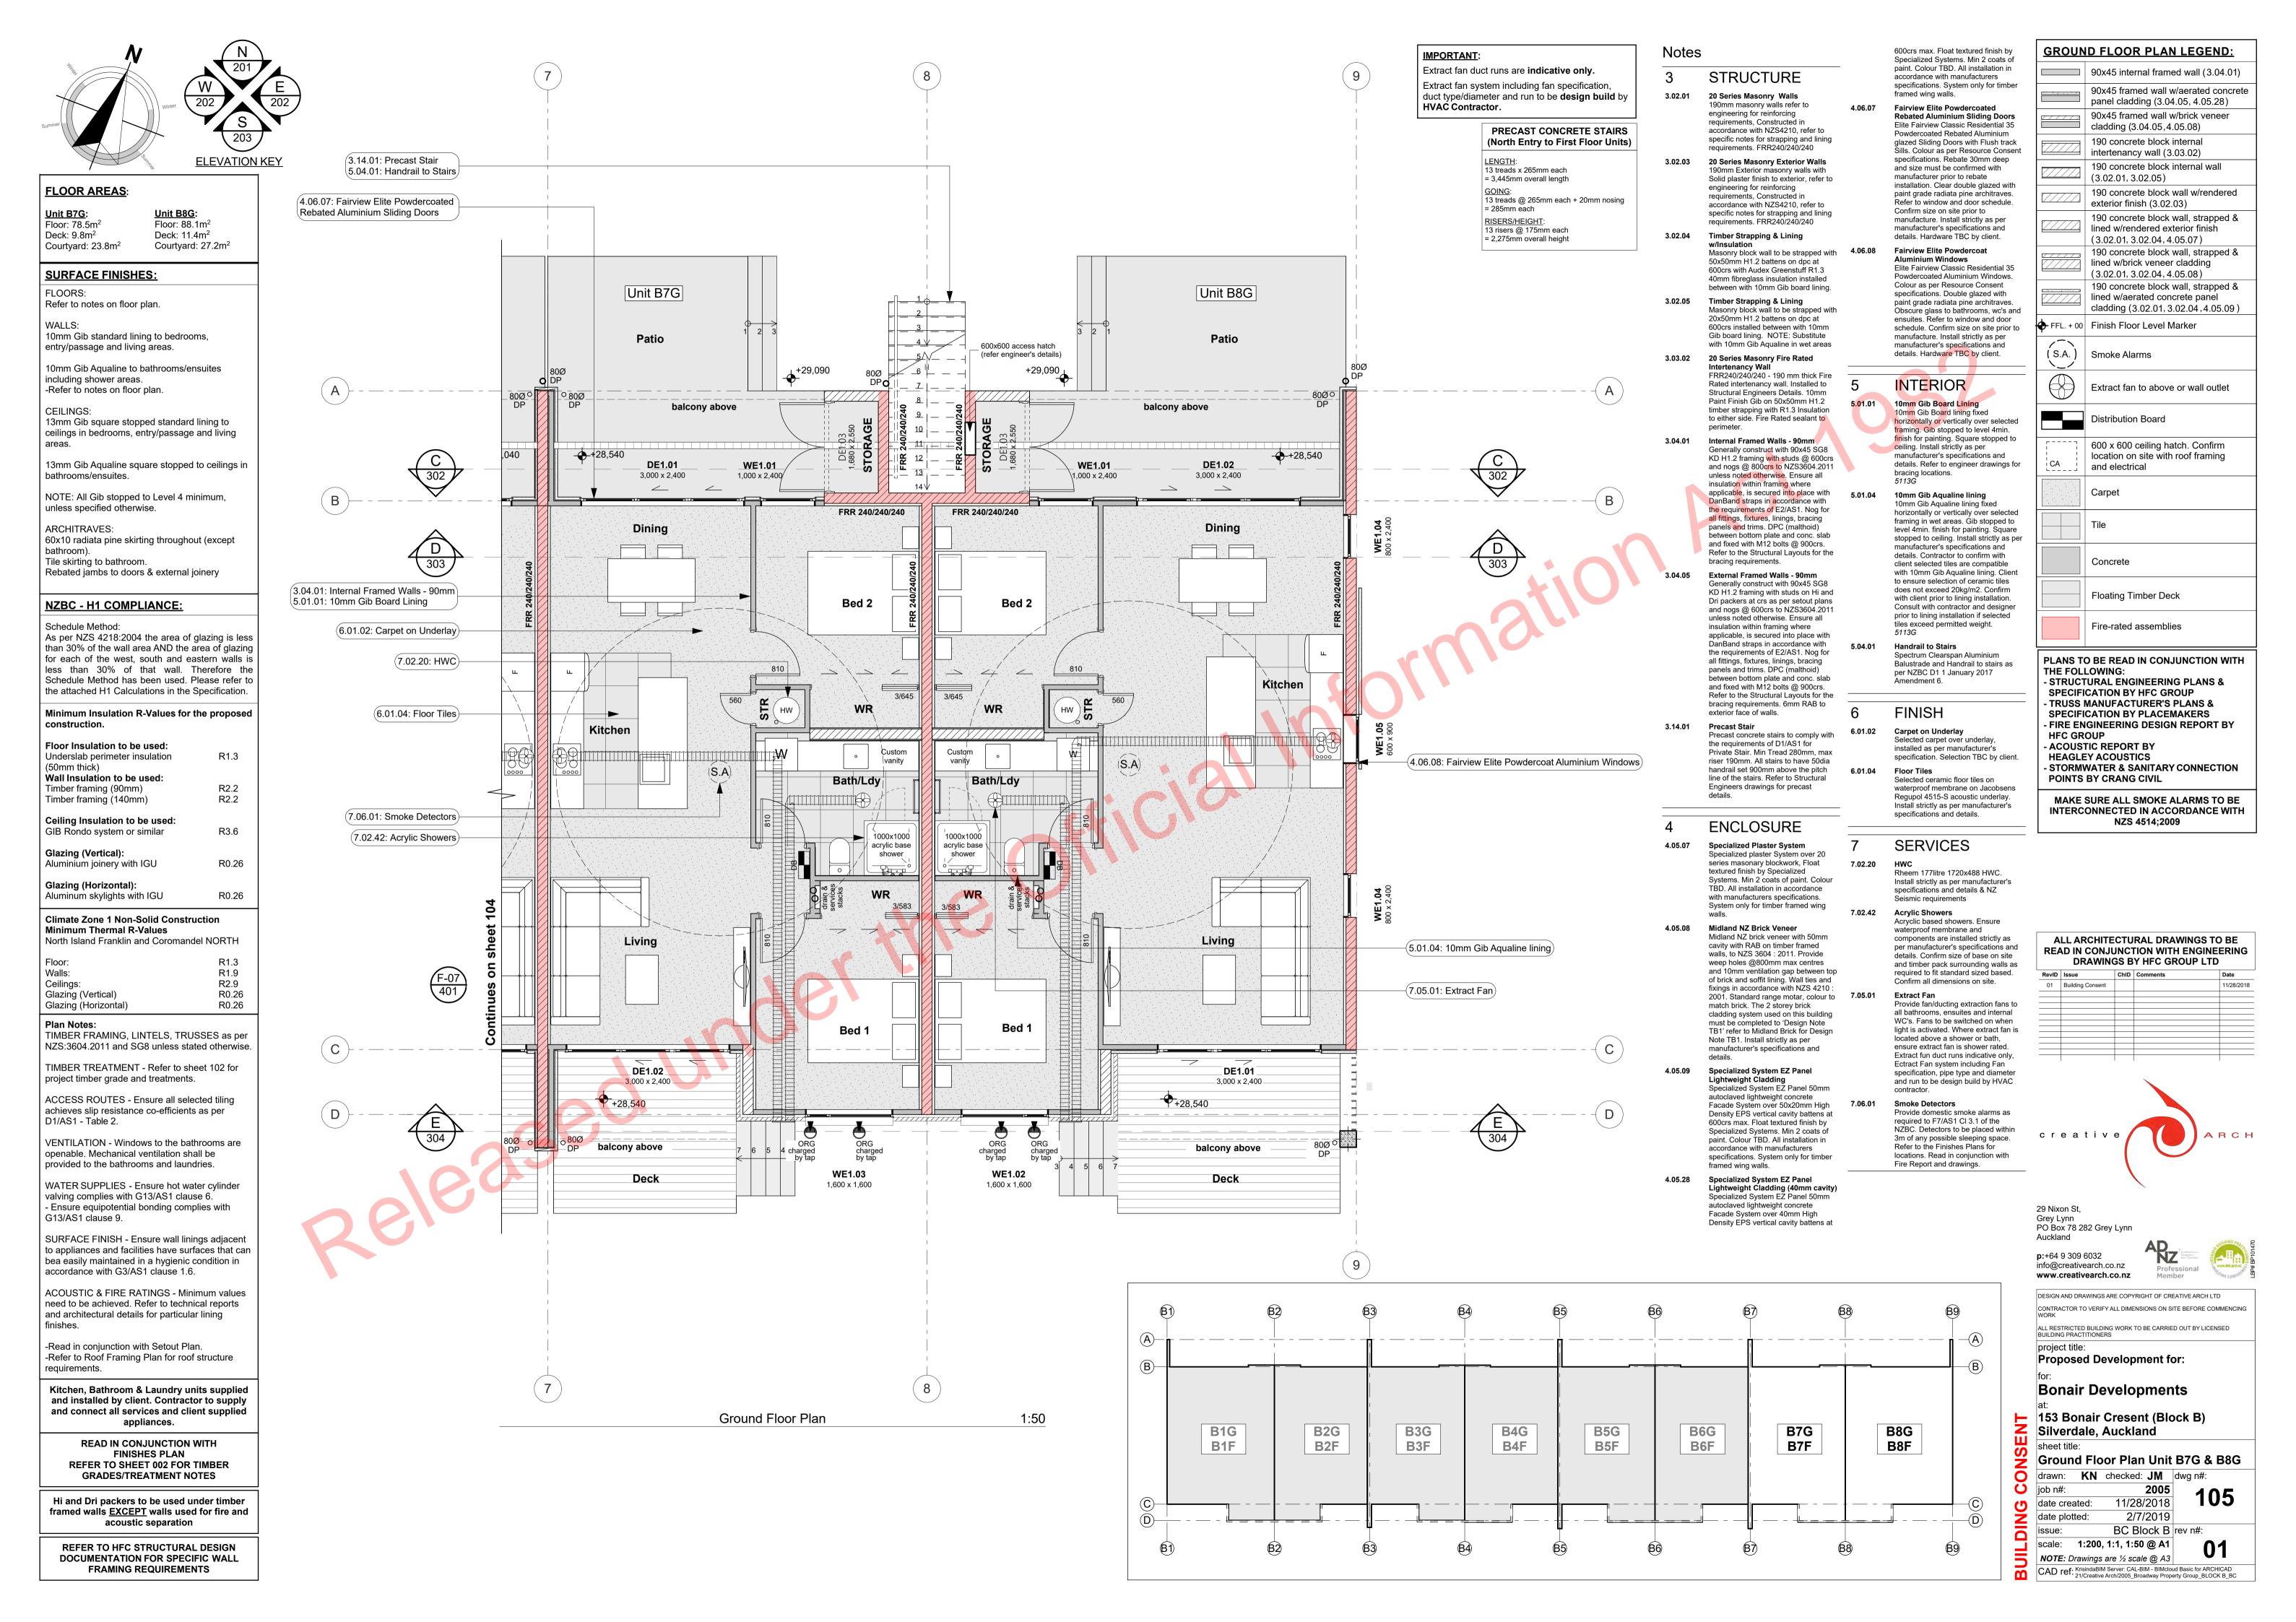


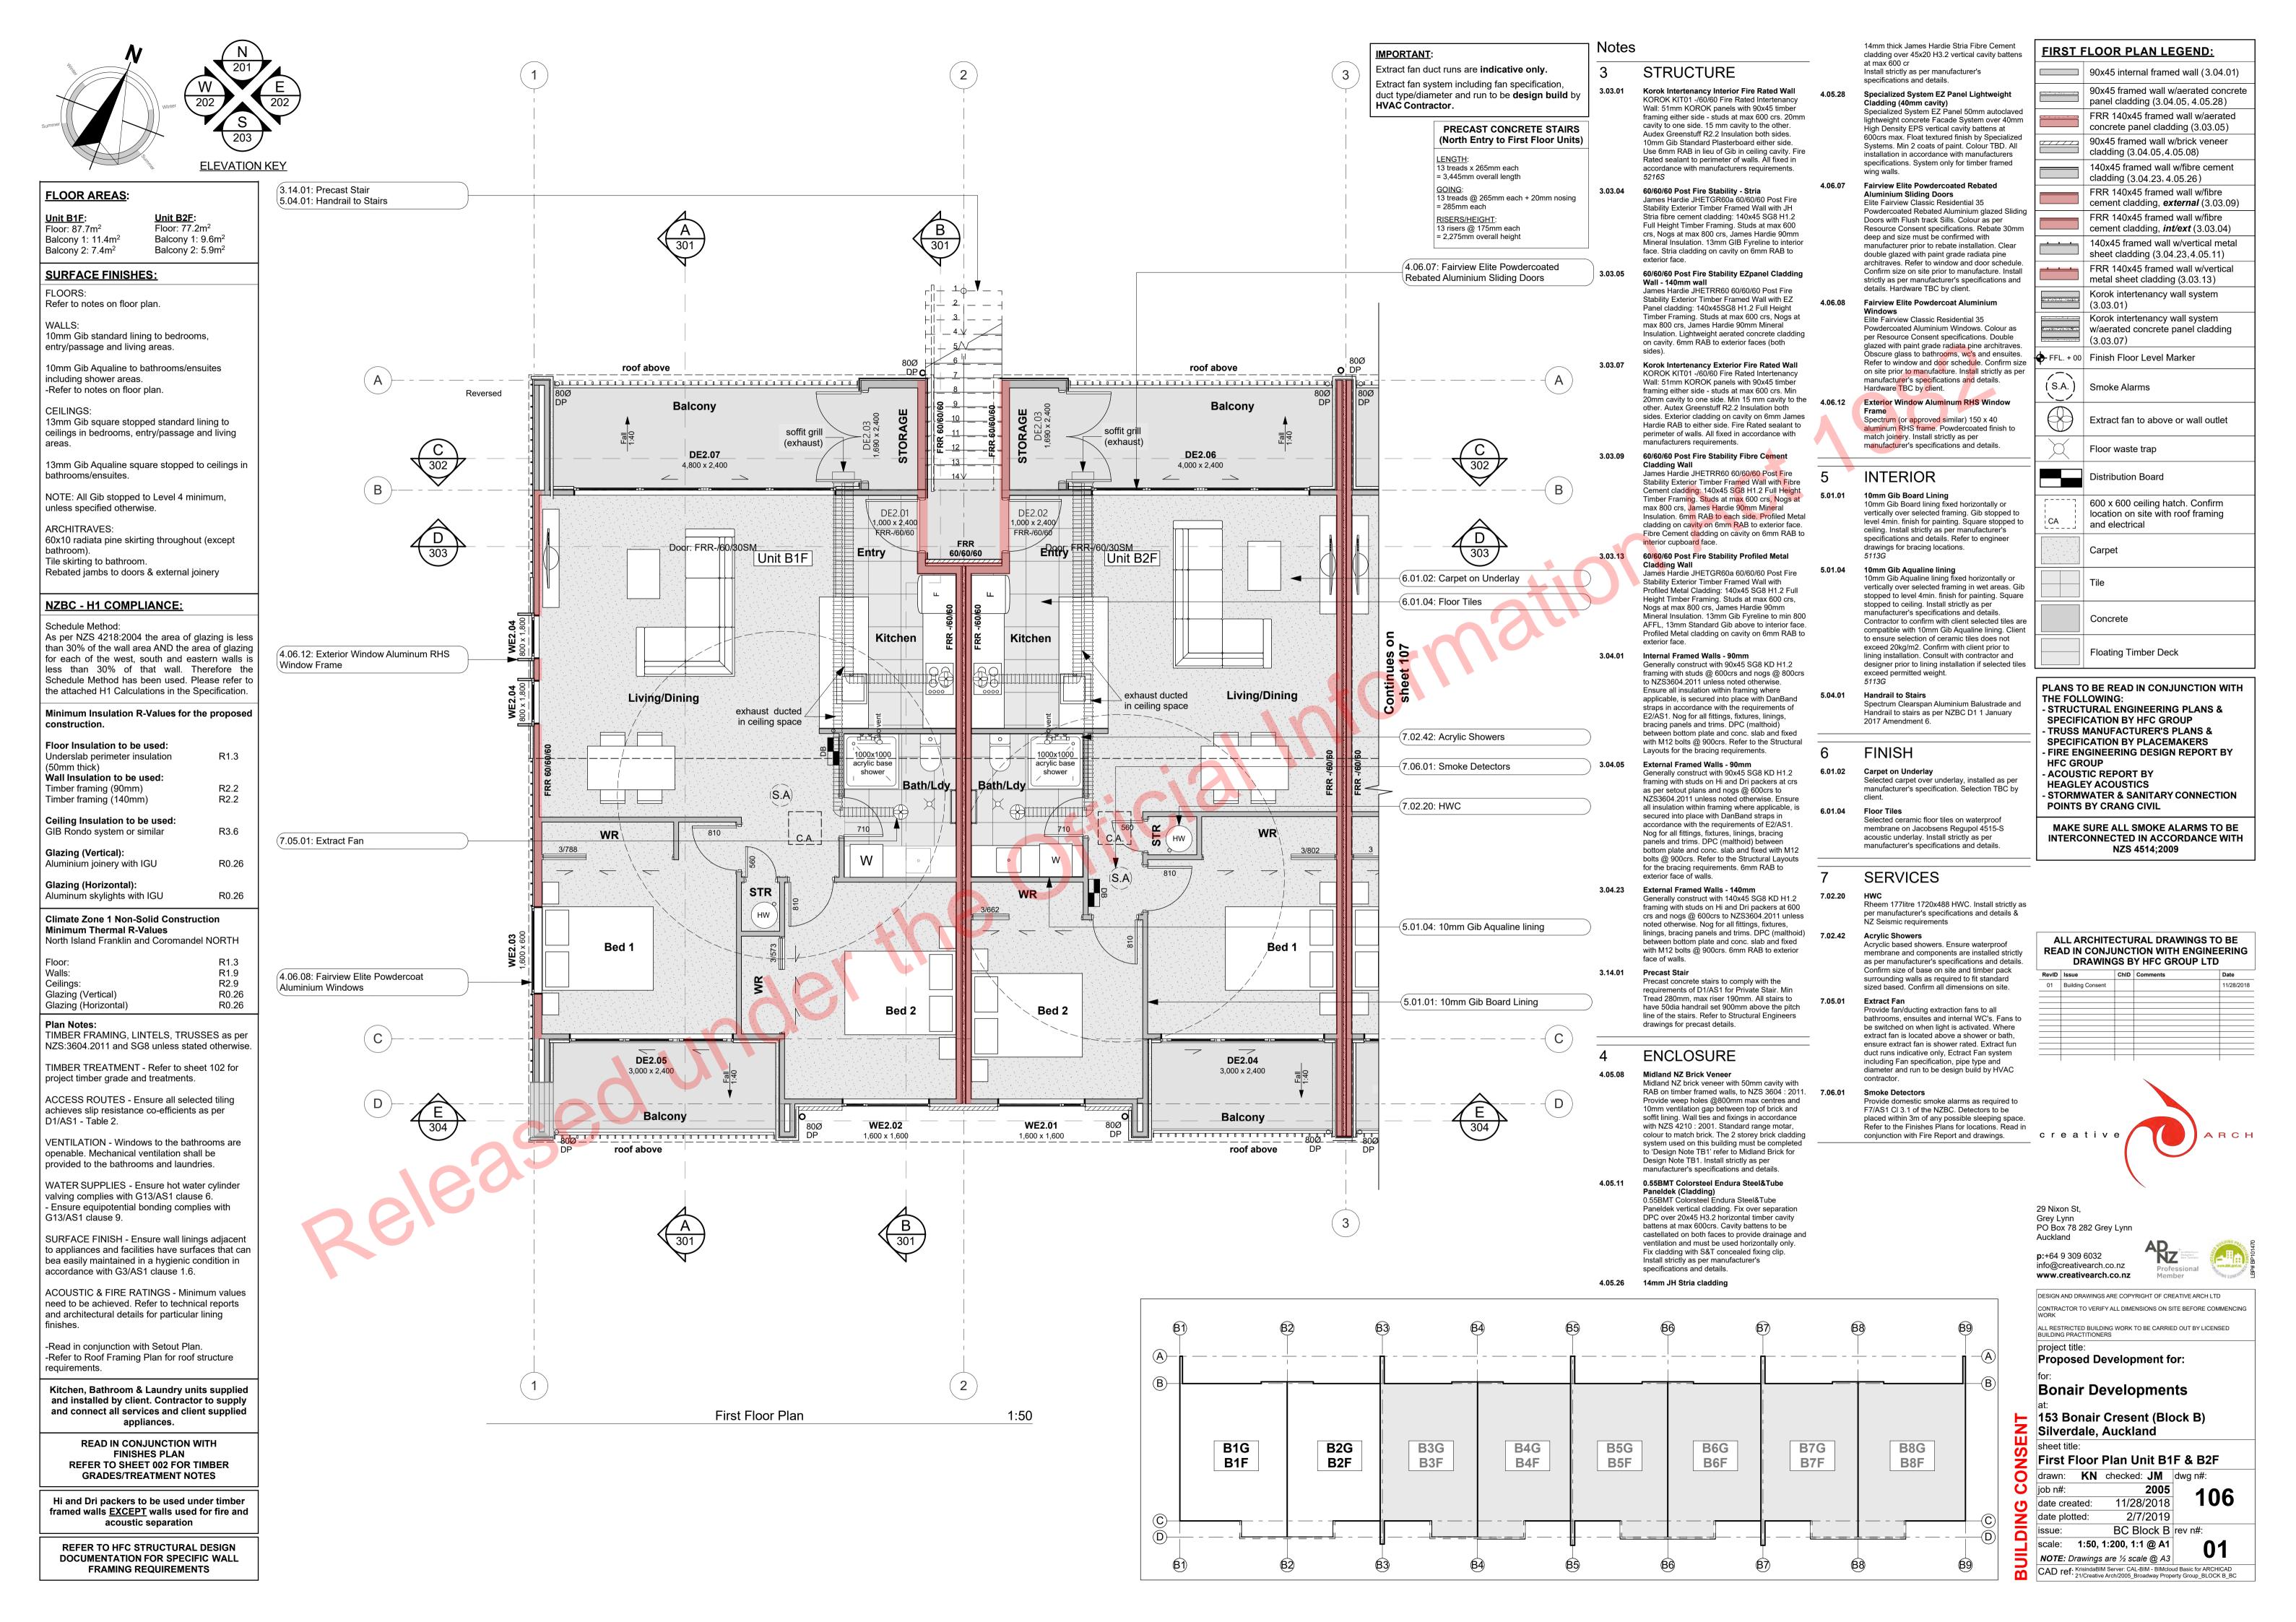


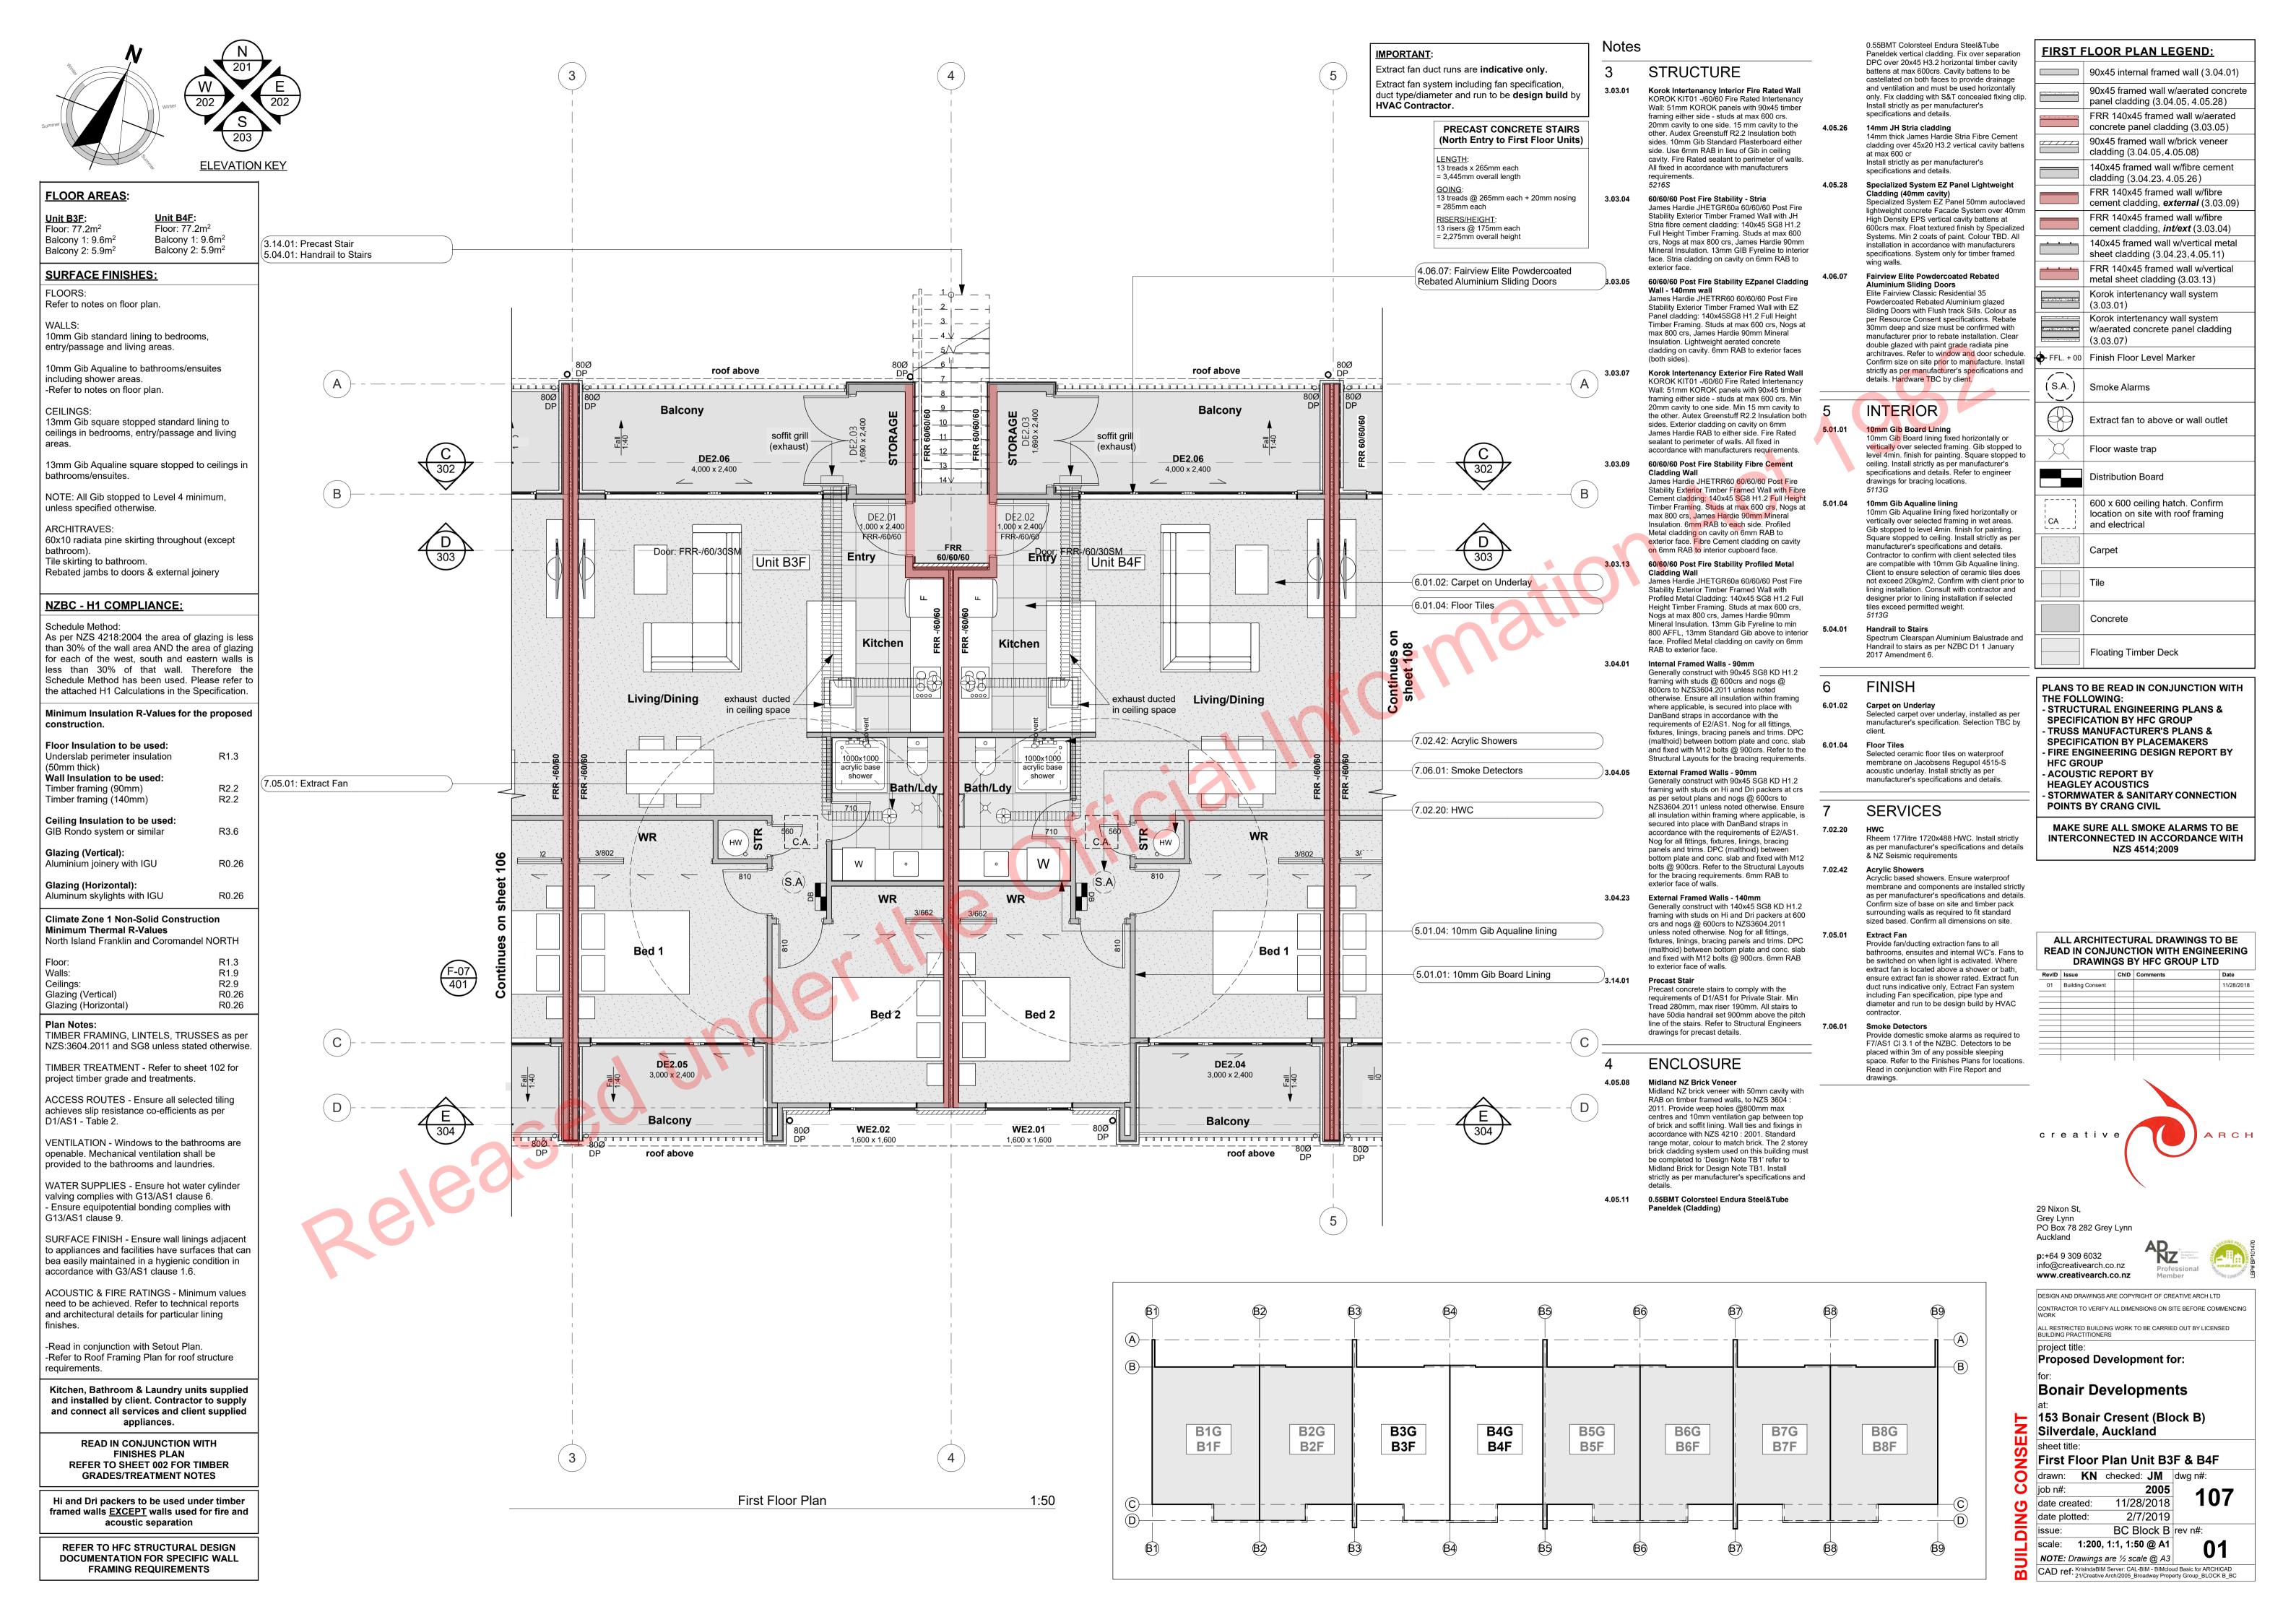

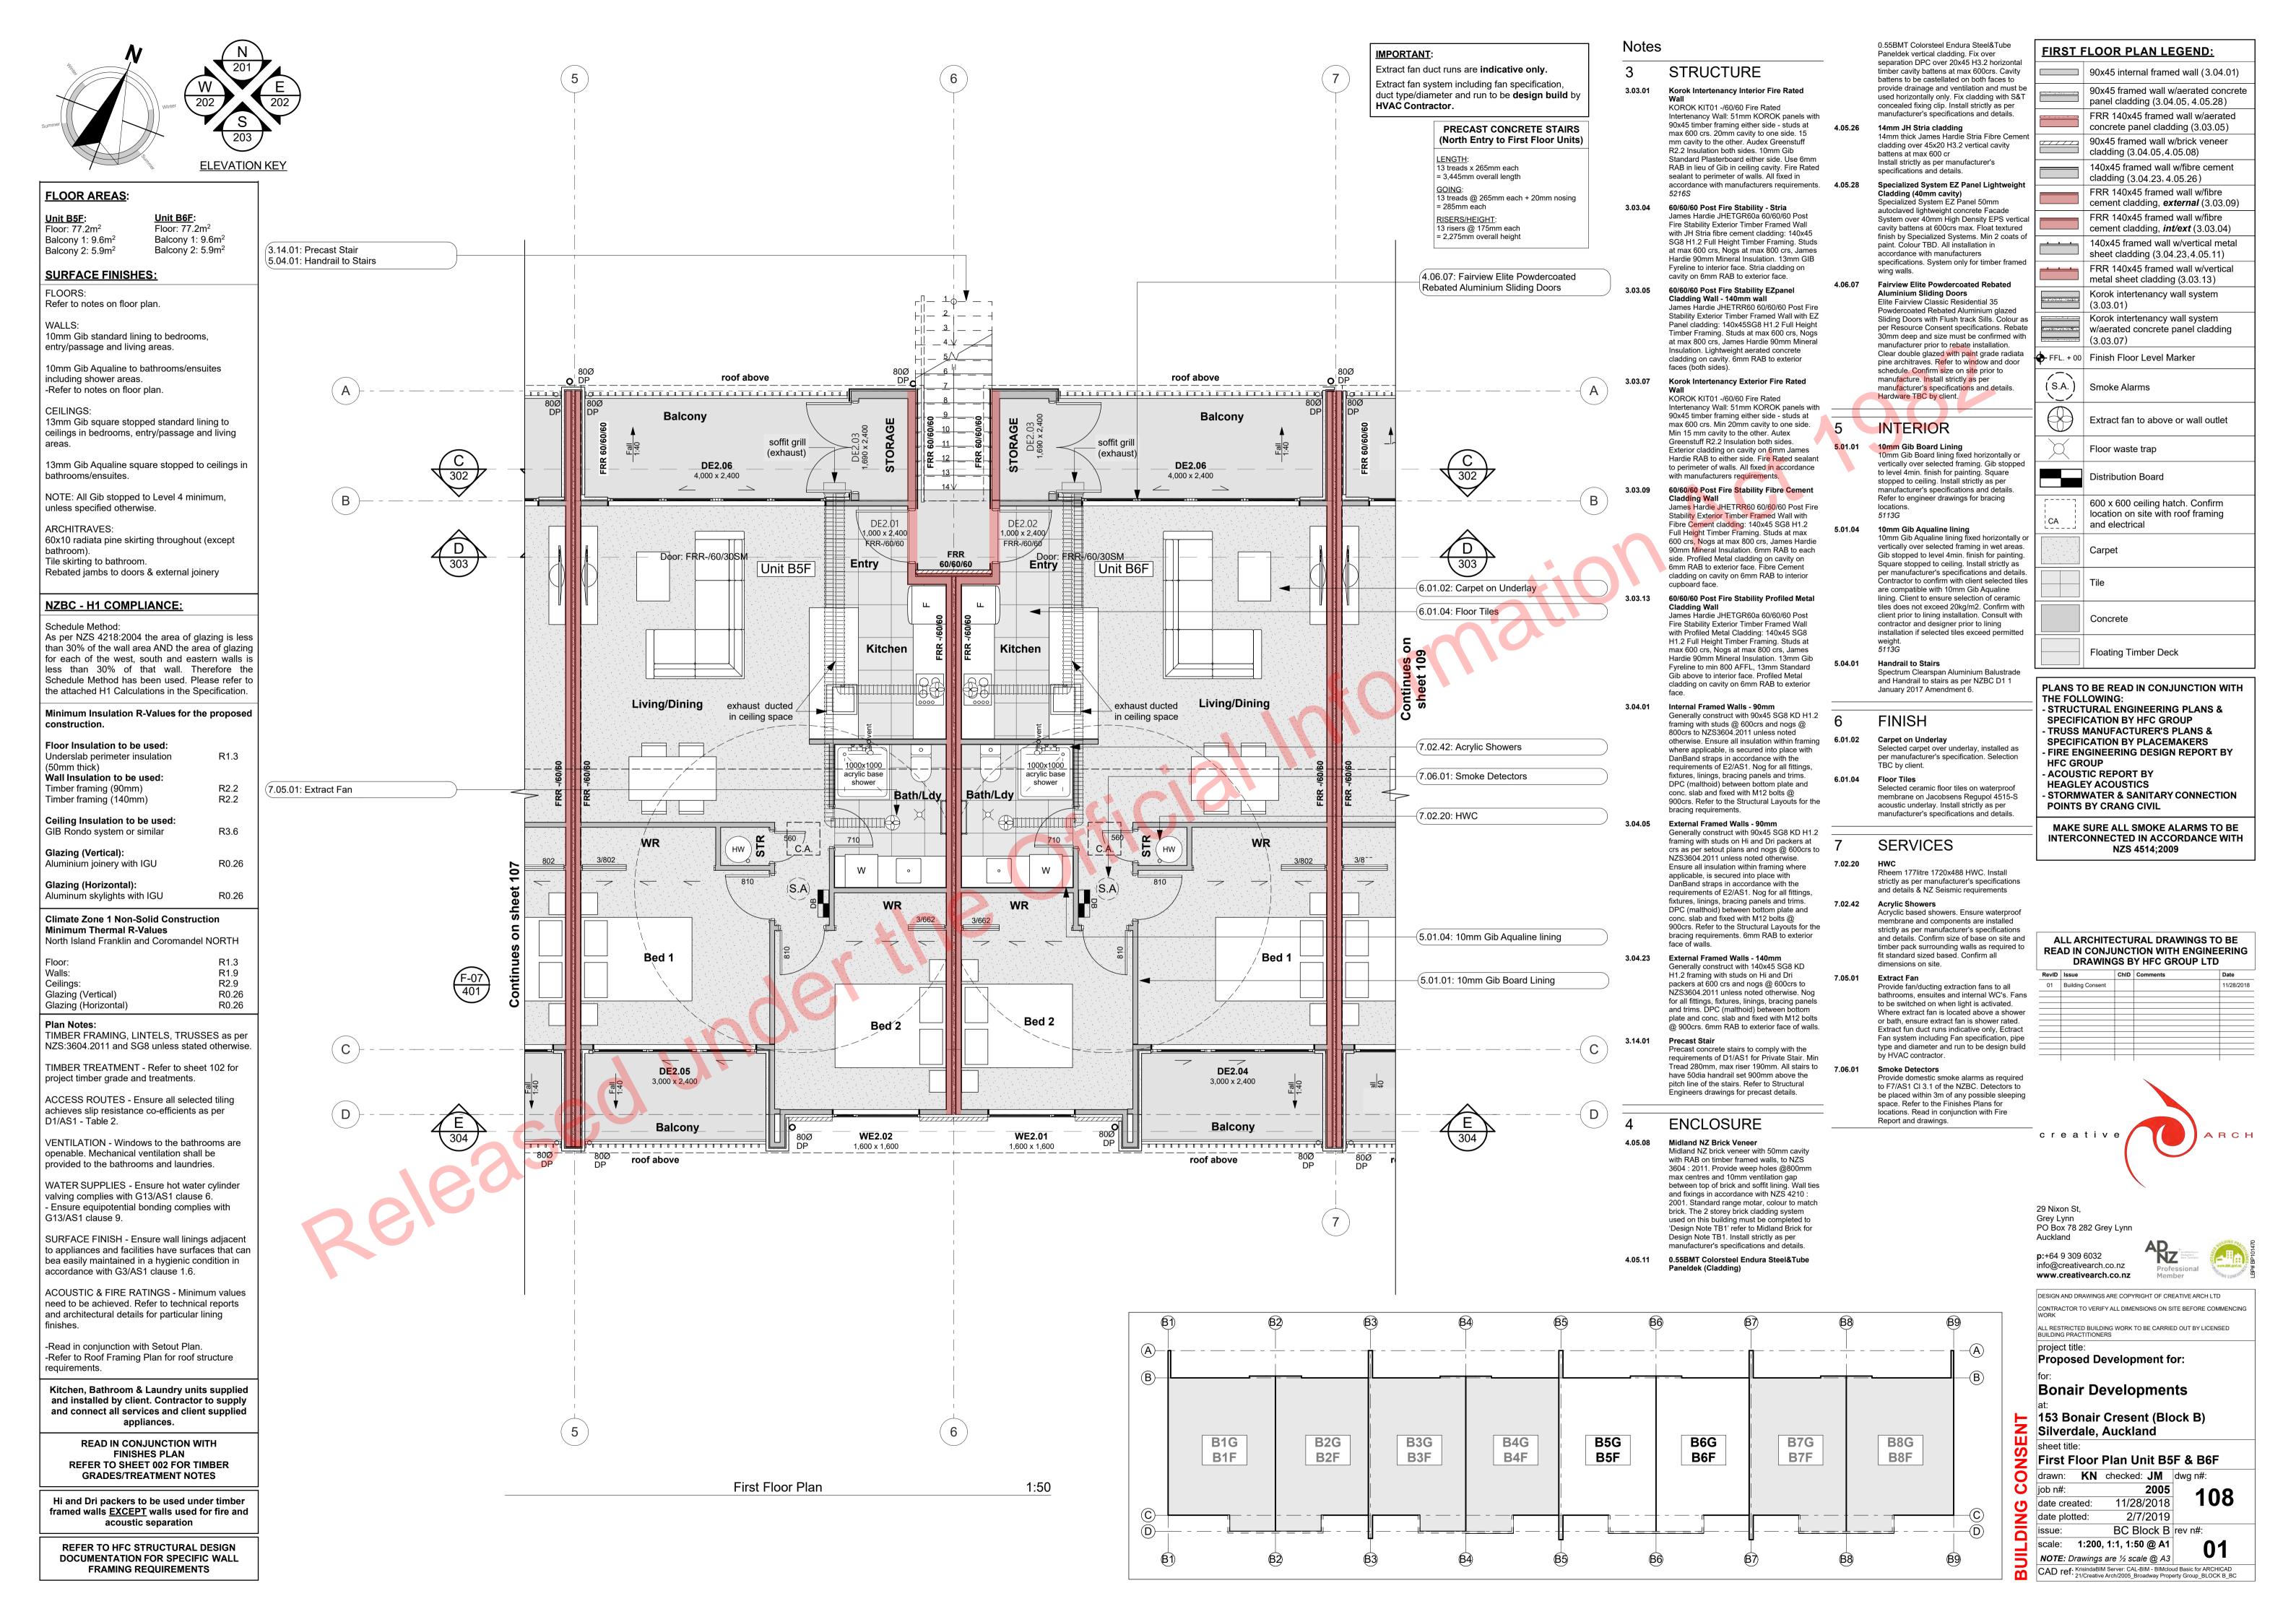

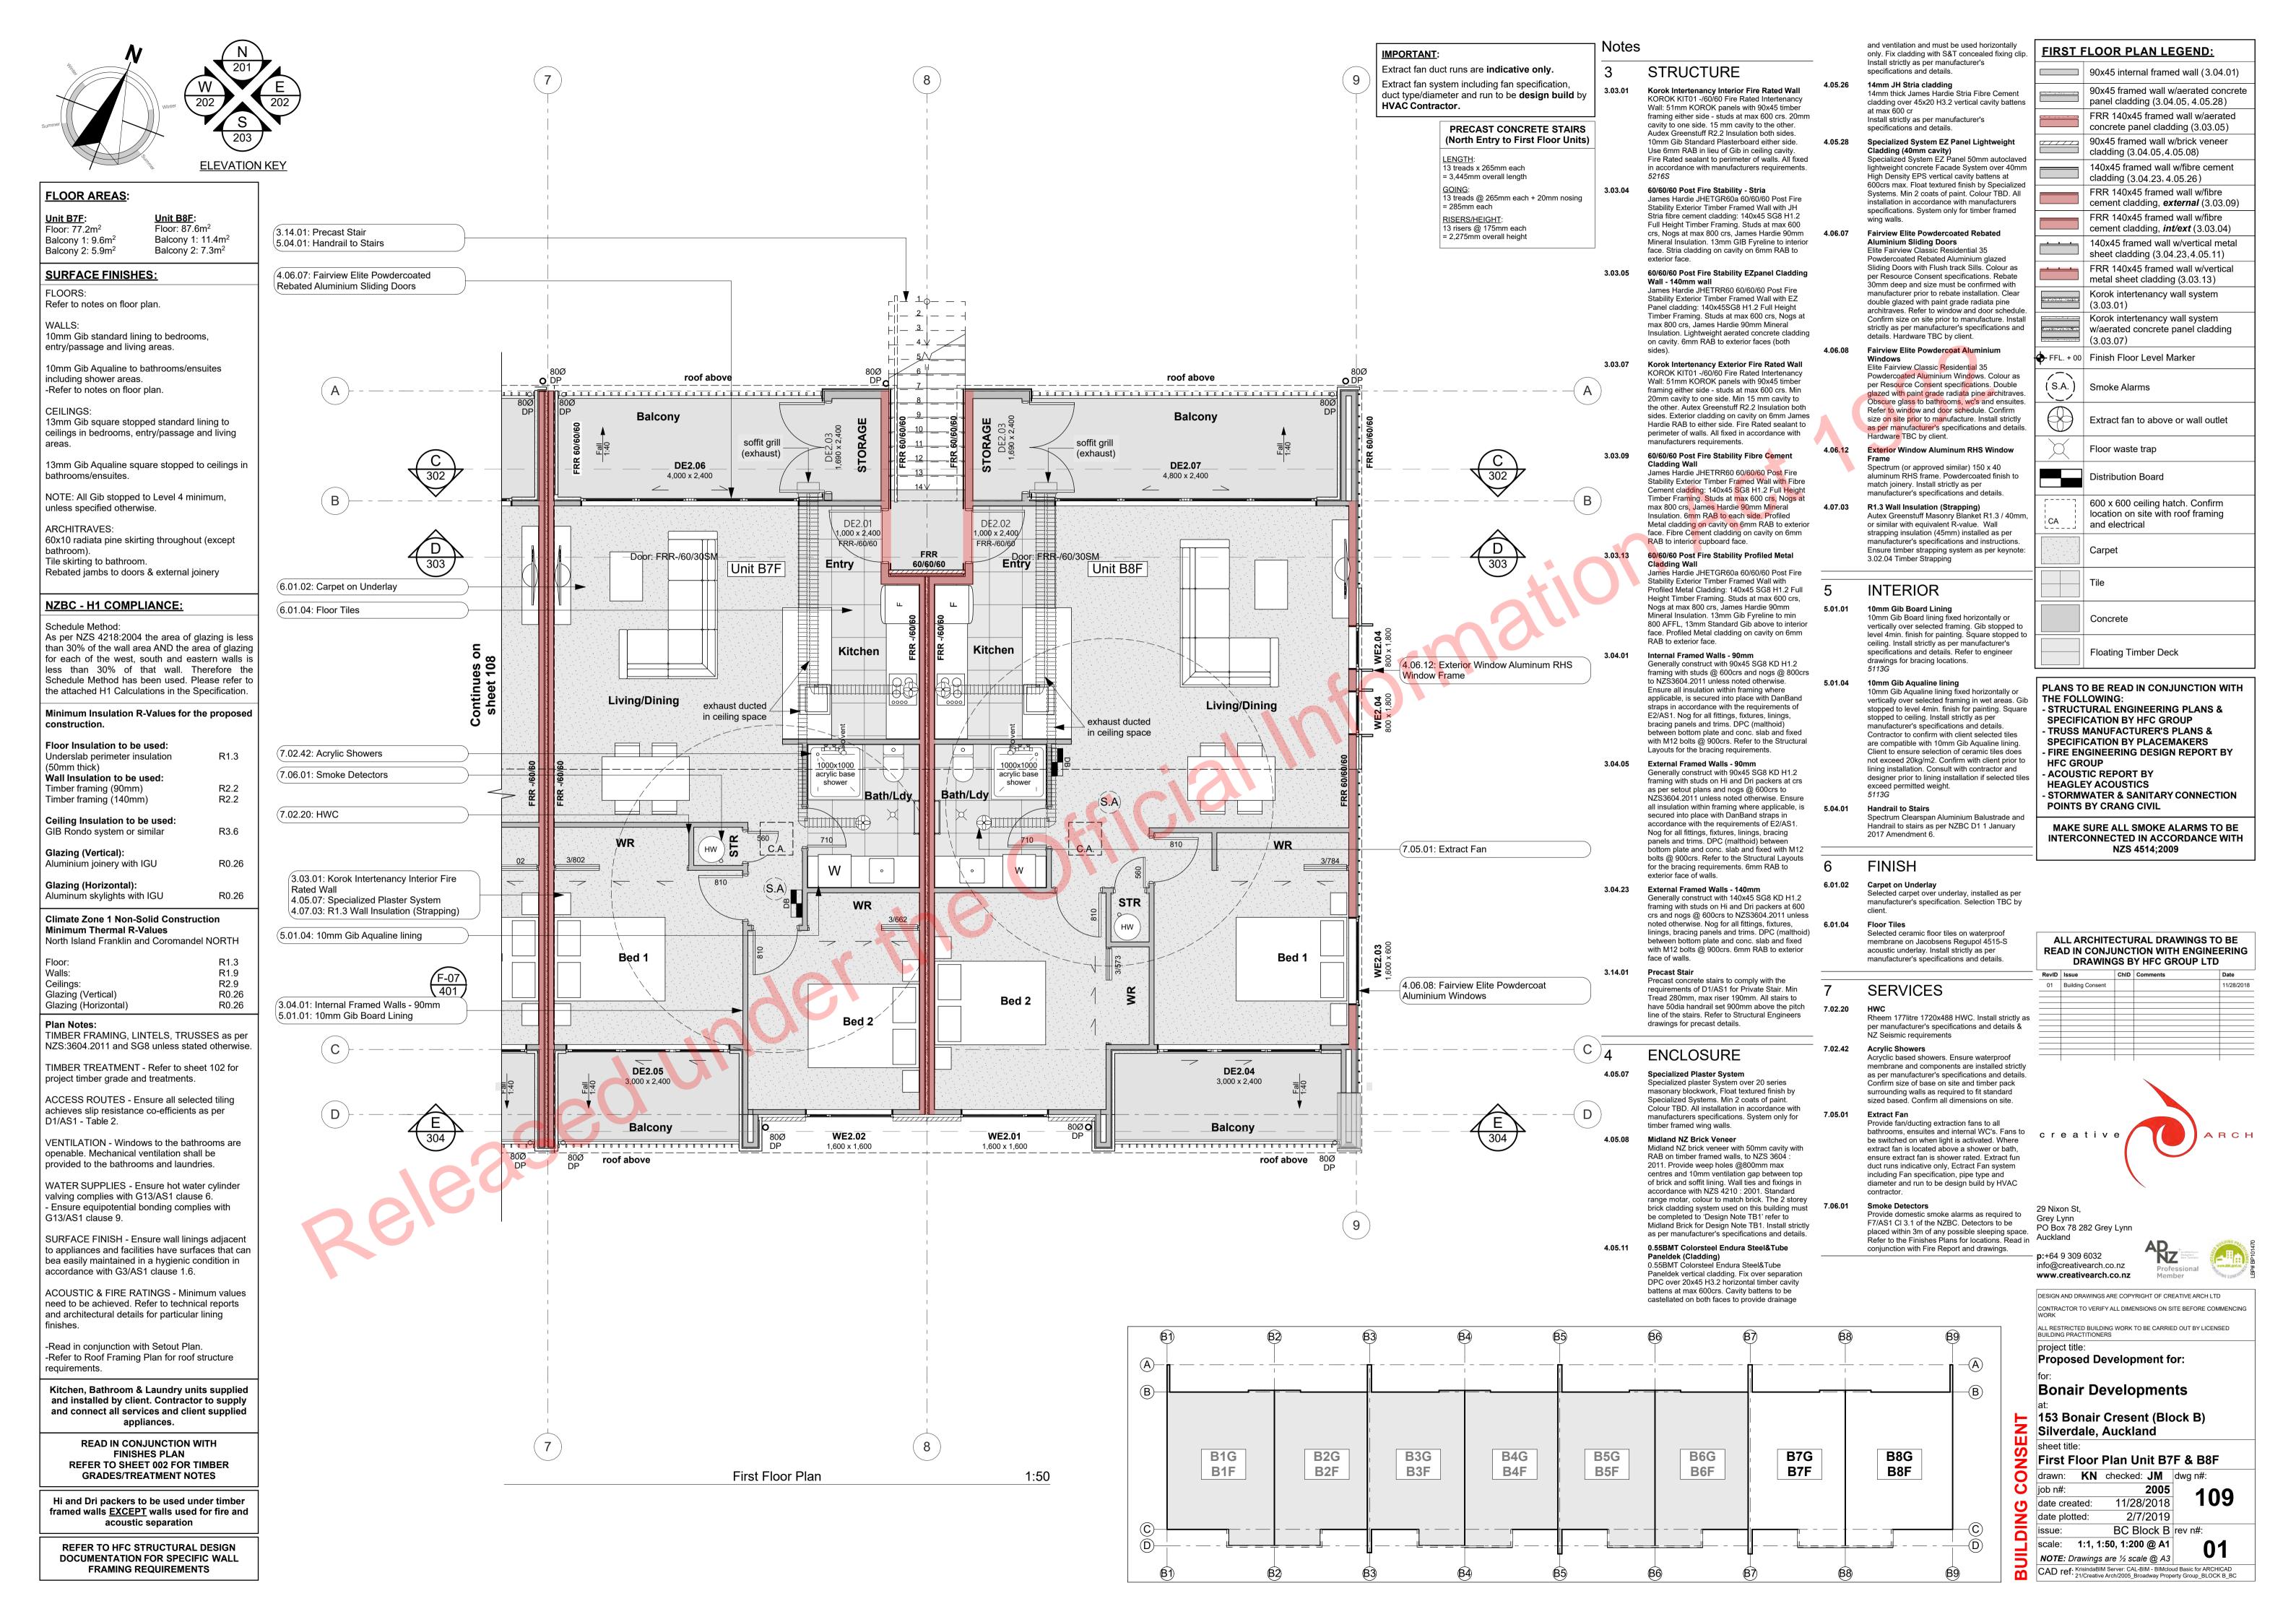

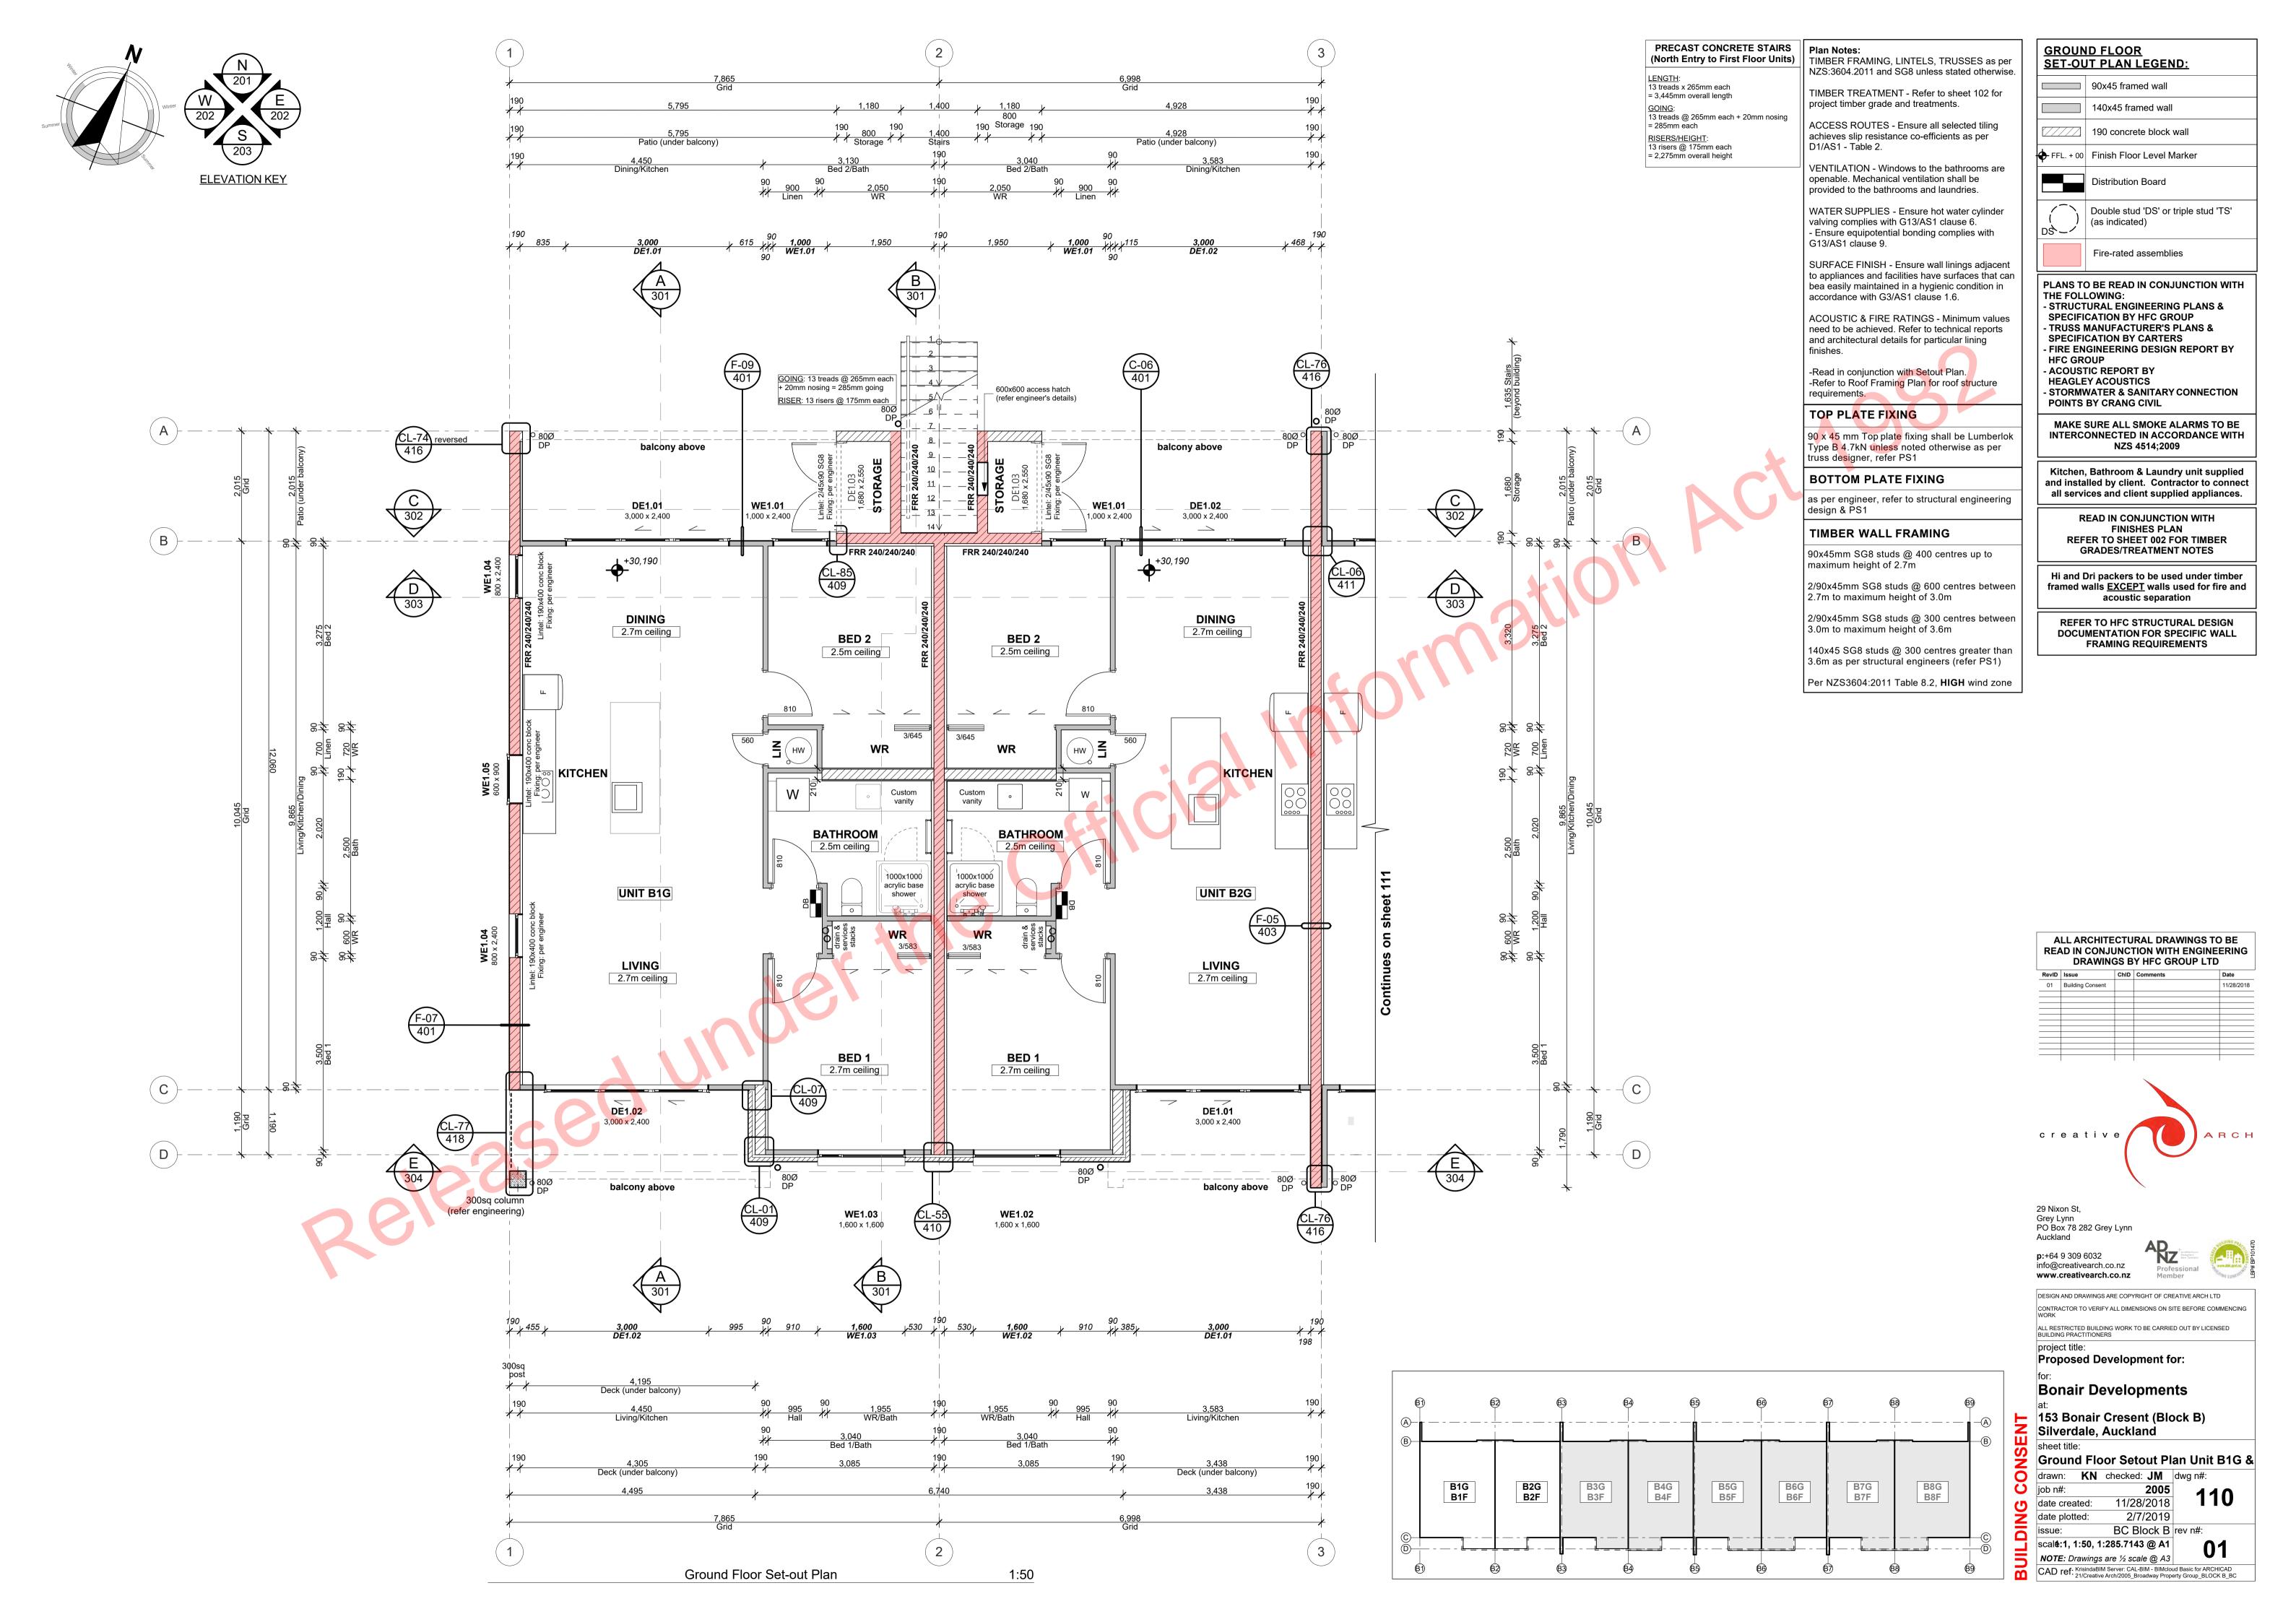

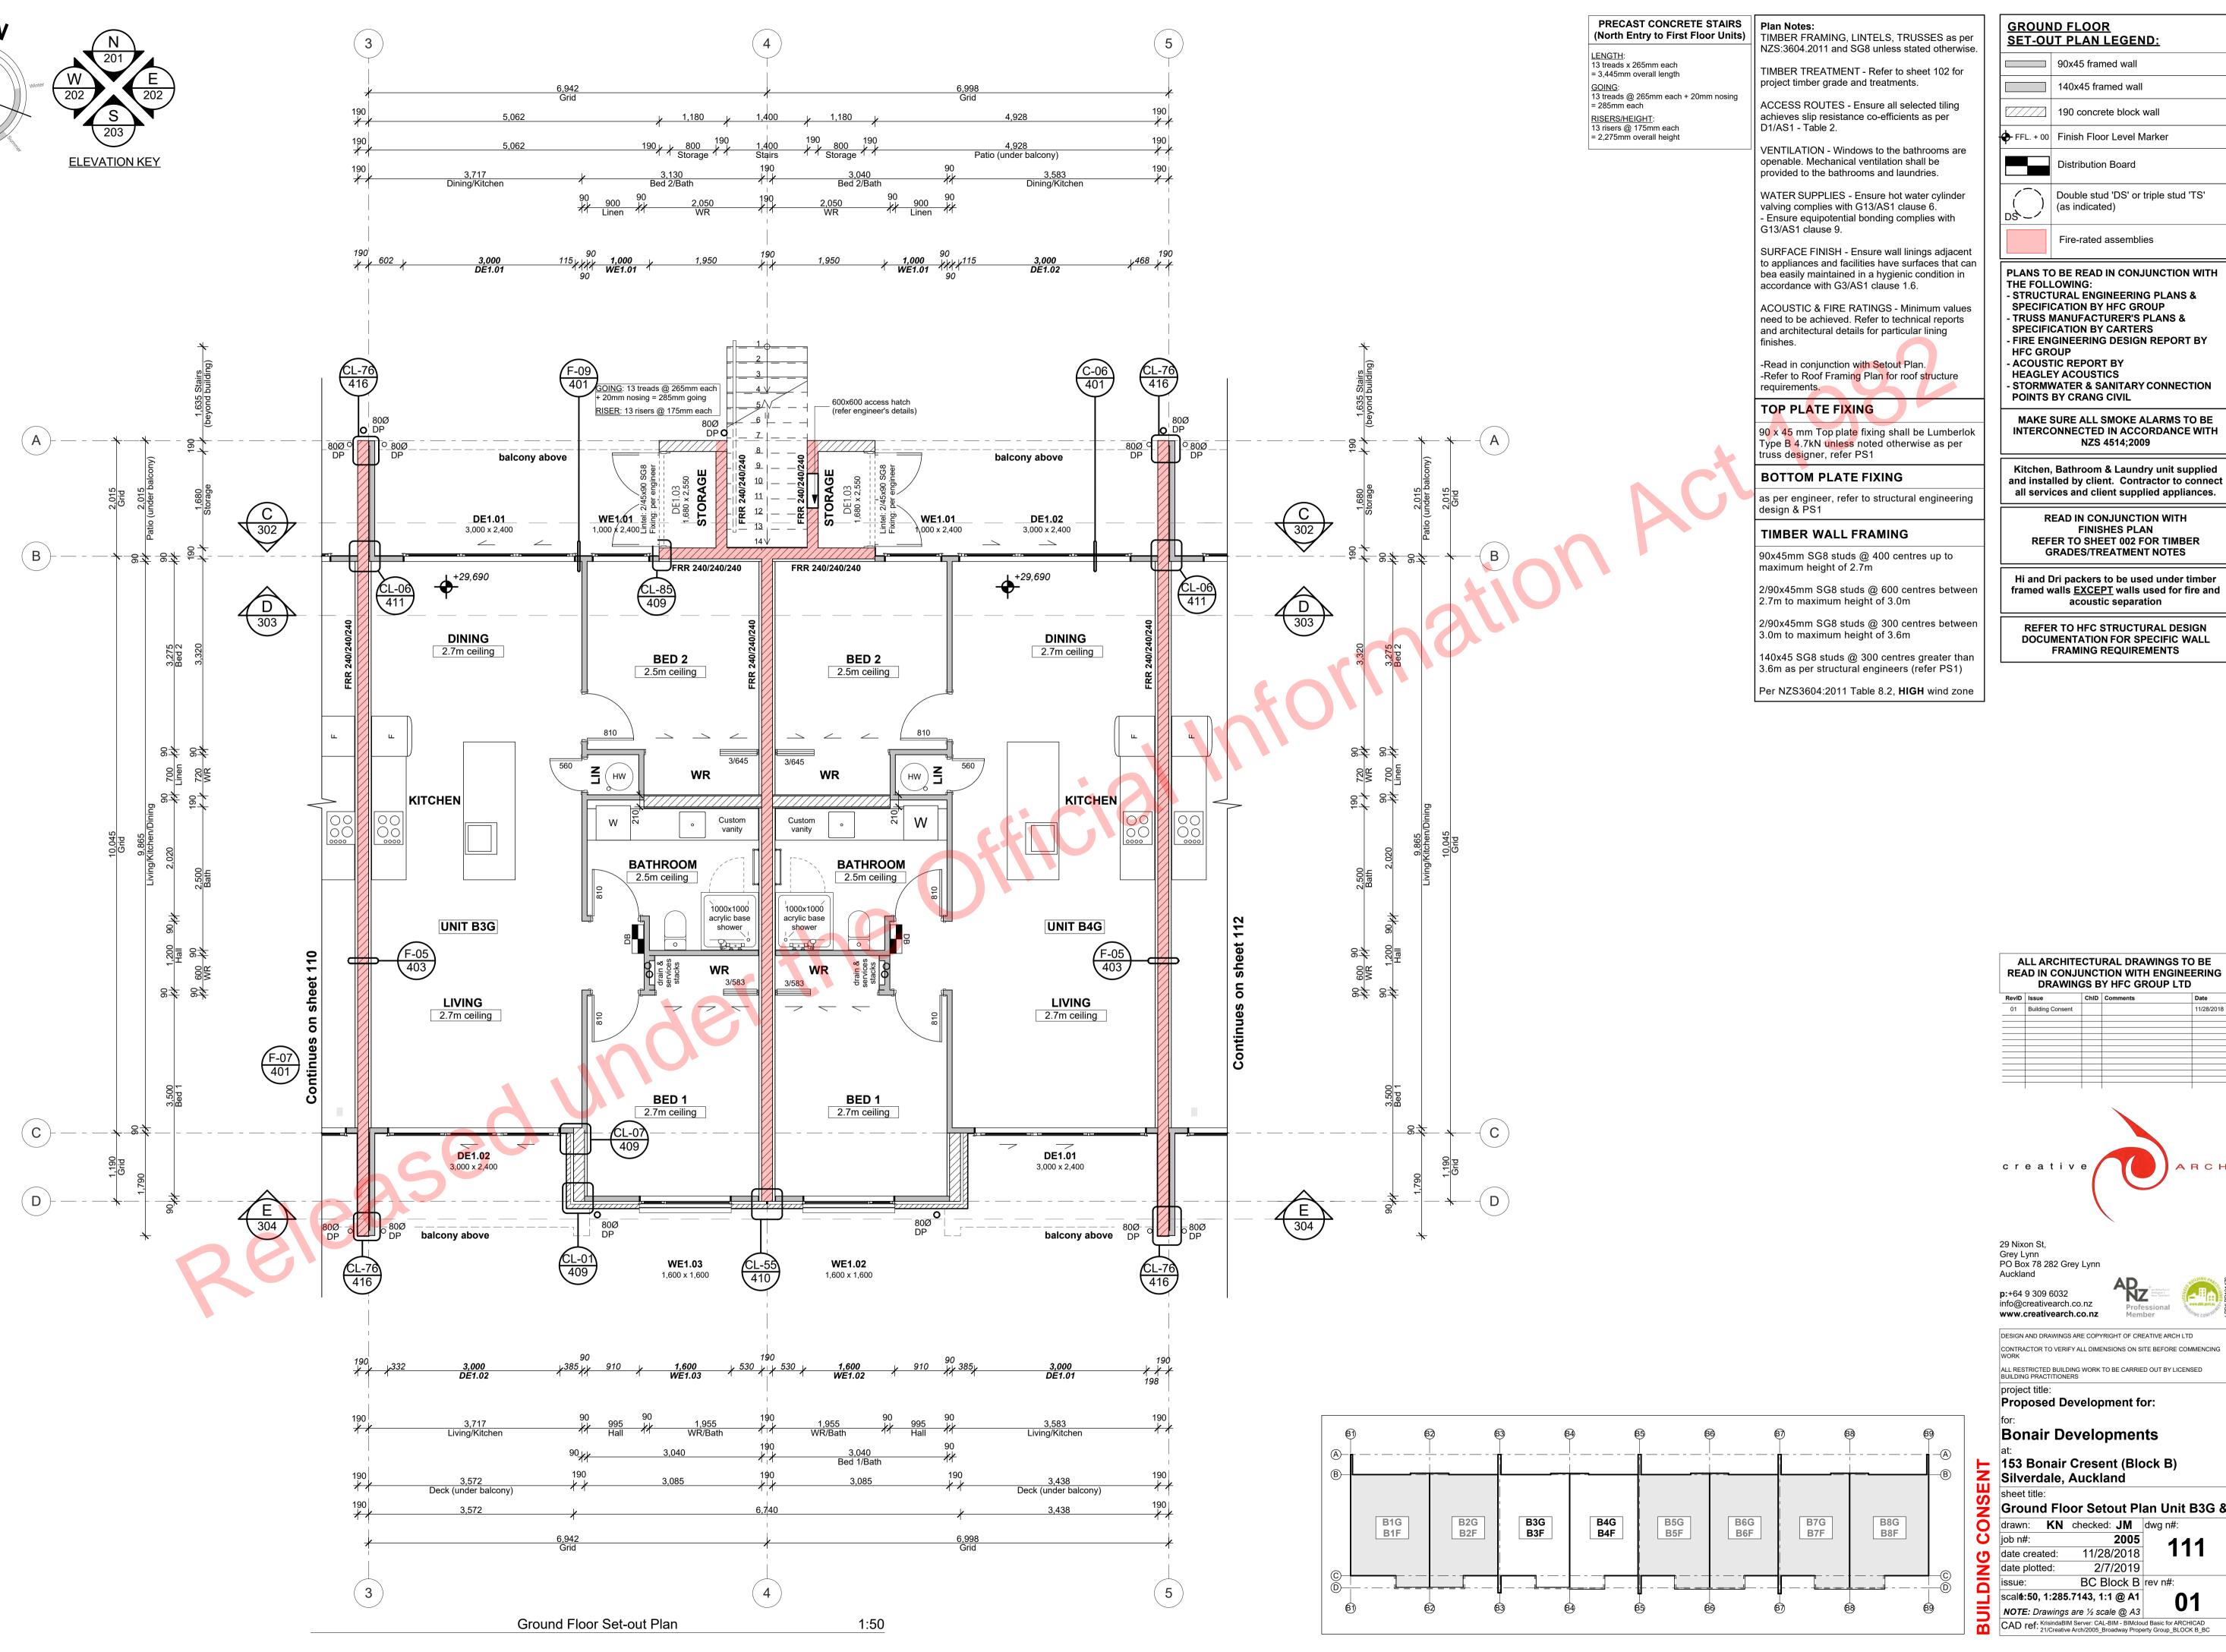

GROUND FLOOR SET-OUT PLAN LEGEND:

90x45 framed wall 140x45 framed wall 190 concrete block wall FFL. + 00 Finish Floor Level Marker Distribution Board Double stud 'DS' or triple stud 'TS' (as indicated)

Fire-rated assemblies PLANS TO BE READ IN CONJUNCTION WITH

- STRUCTURAL ENGINEERING PLANS & SPECIFICATION BY HFC GROUP - TRUSS MANUFACTURER'S PLANS & **SPECIFICATION BY CARTERS** FIRE ENGINEERING DESIGN REPORT BY **HFC GROUP** - ACOUSTIC REPORT BY **HEAGLEY ACOUSTICS**

POINTS BY CRANG CIVIL MAKE SURE ALL SMOKE ALARMS TO BE INTERCONNECTED IN ACCORDANCE WITH

Kitchen, Bathroom & Laundry unit supplied and installed by client. Contractor to connect

NZS 4514;2009

all services and client supplied appliances. READ IN CONJUNCTION WITH FINISHES PLAN

GRADES/TREATMENT NOTES Hi and Dri packers to be used under timber

acoustic separation

FRAMING REQUIREMENTS


REFER TO HFC STRUCTURAL DESIGN DOCUMENTATION FOR SPECIFIC WALL

ALL ARCHITECTURAL DRAWINGS TO BE **READ IN CONJUNCTION WITH ENGINEERING** DRAWINGS BY HFC GROUP LTD



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Proposed Development for:


Bonair Developments

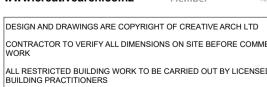
153 Bonair Cresent (Block B)


Silverdale, Auckland


Ground Floor Setout Plan Unit B3G & drawn: KN checked: JM dwg n#: 11/28/2018 2/7/2019

BC Block B rev n#: scal**e**:50, 1:285.7143, 1:1 @ A1

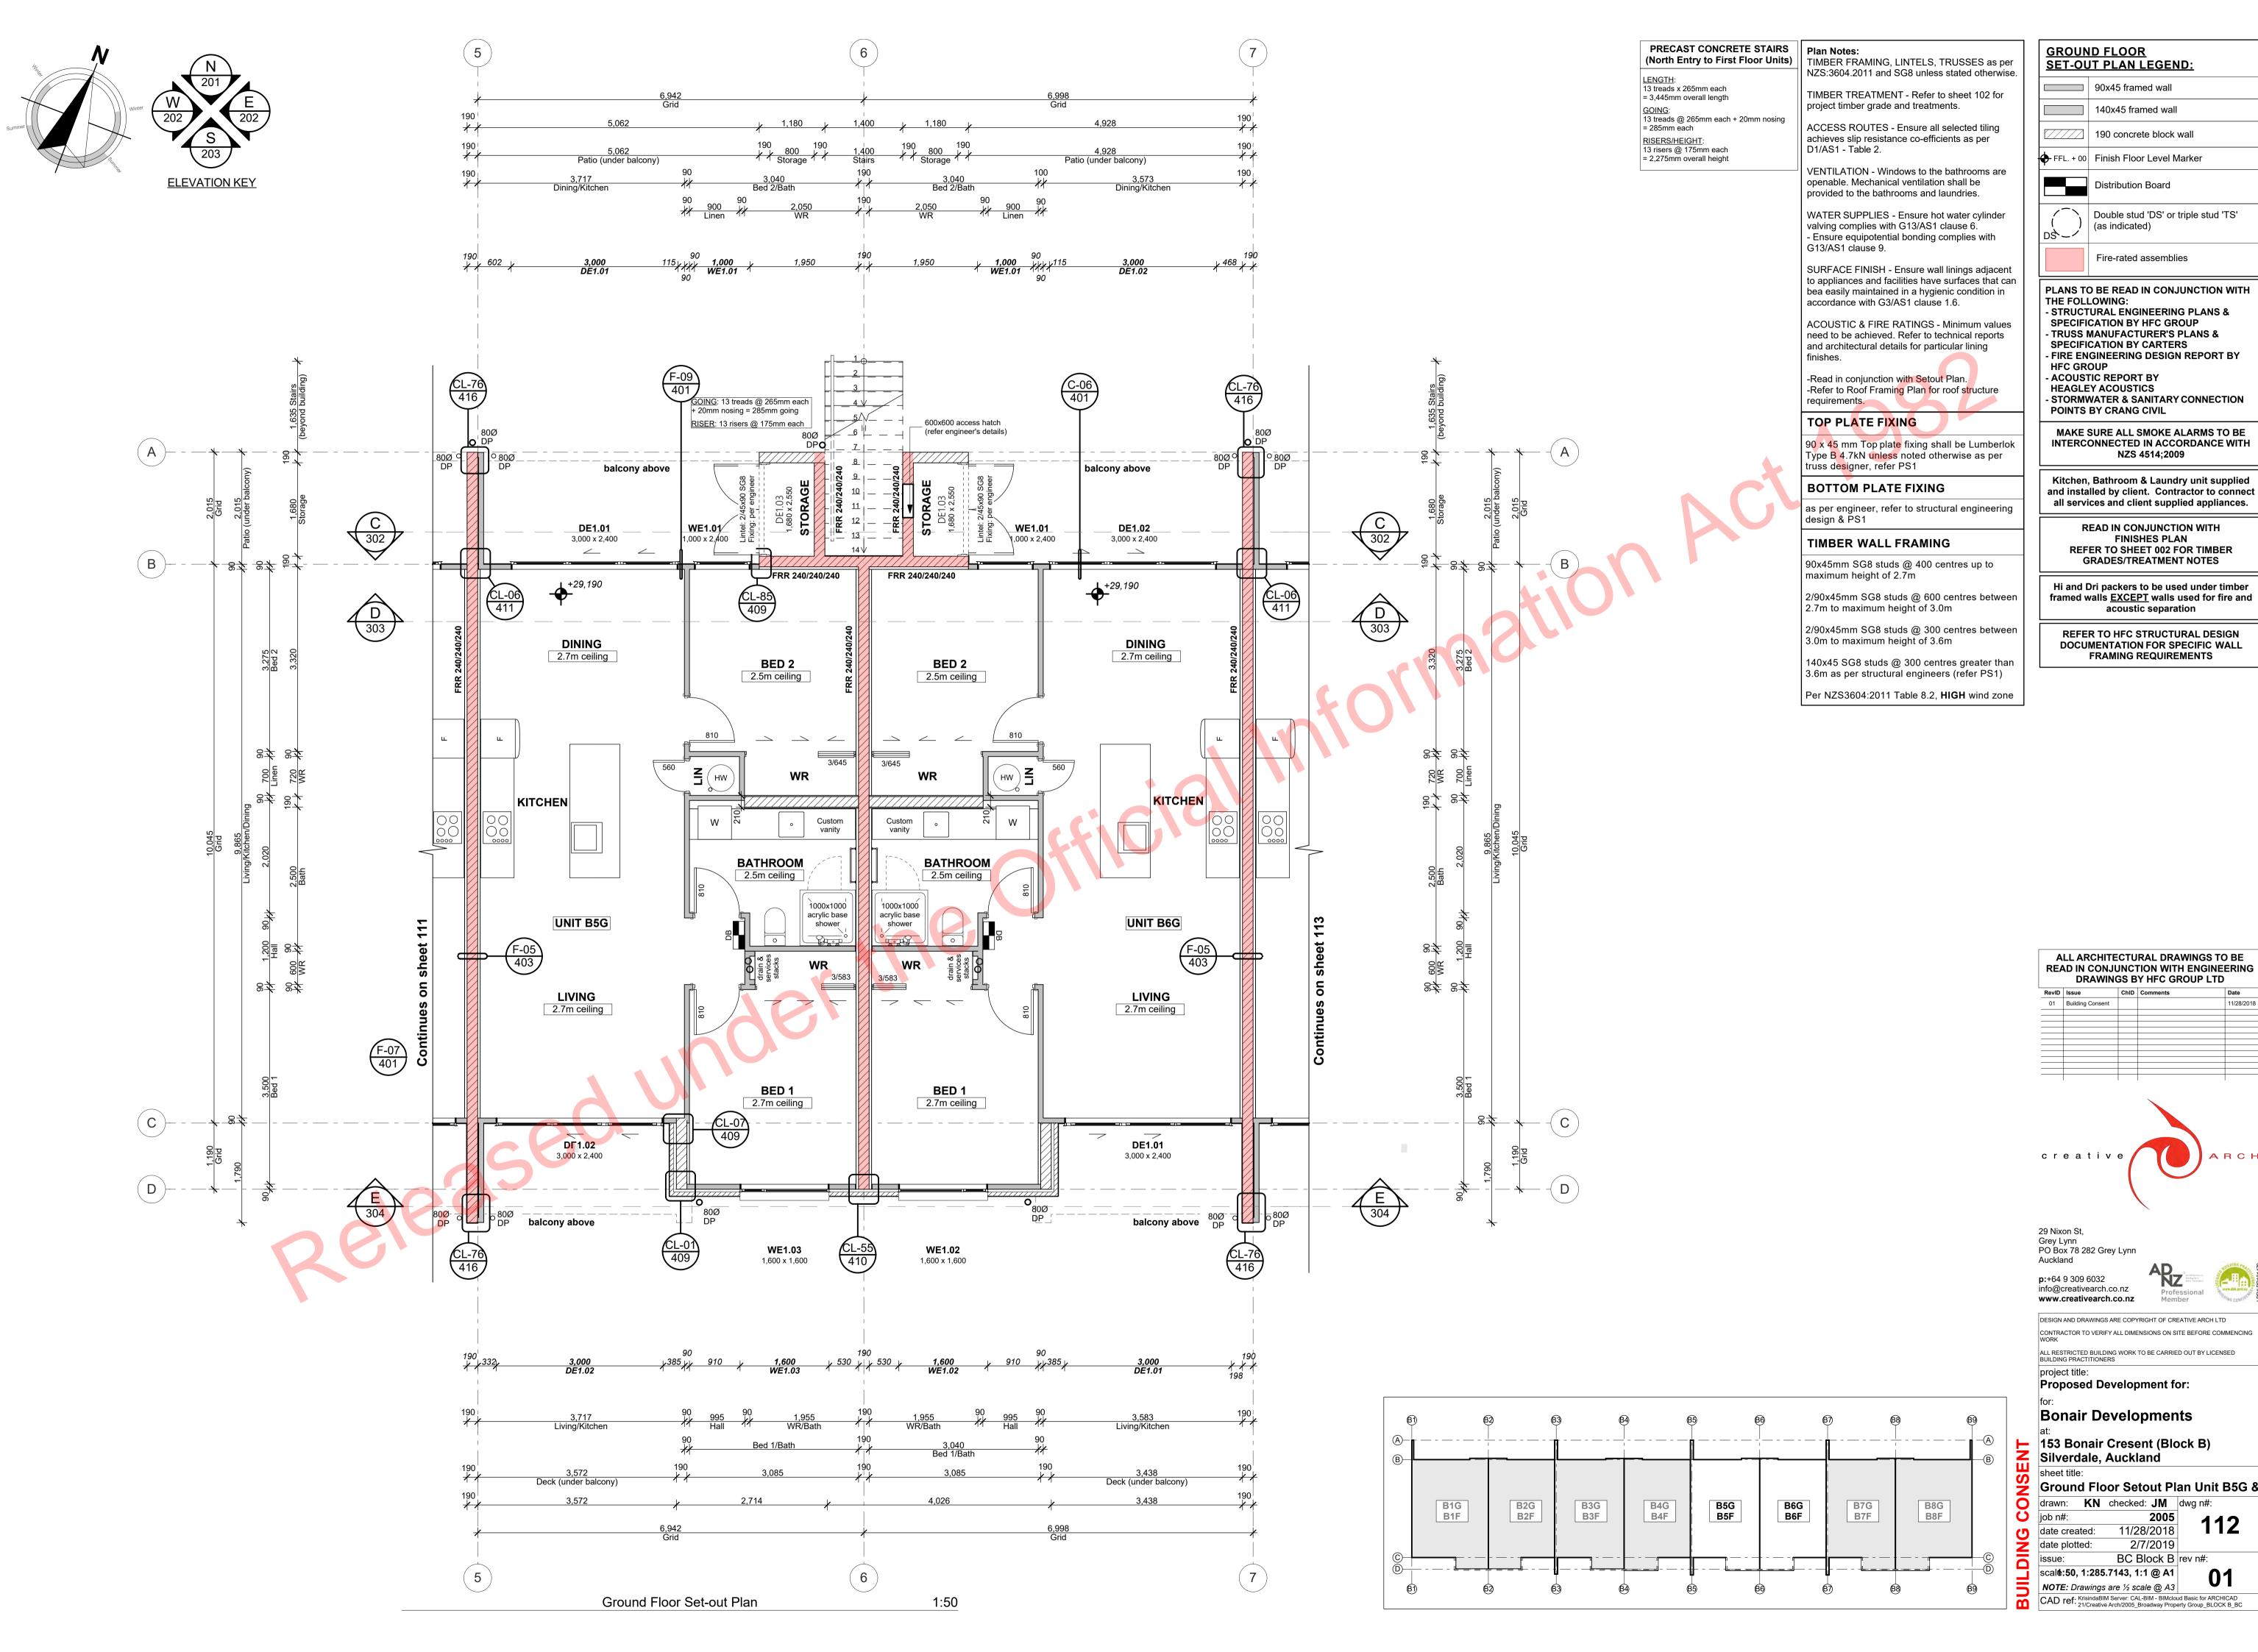

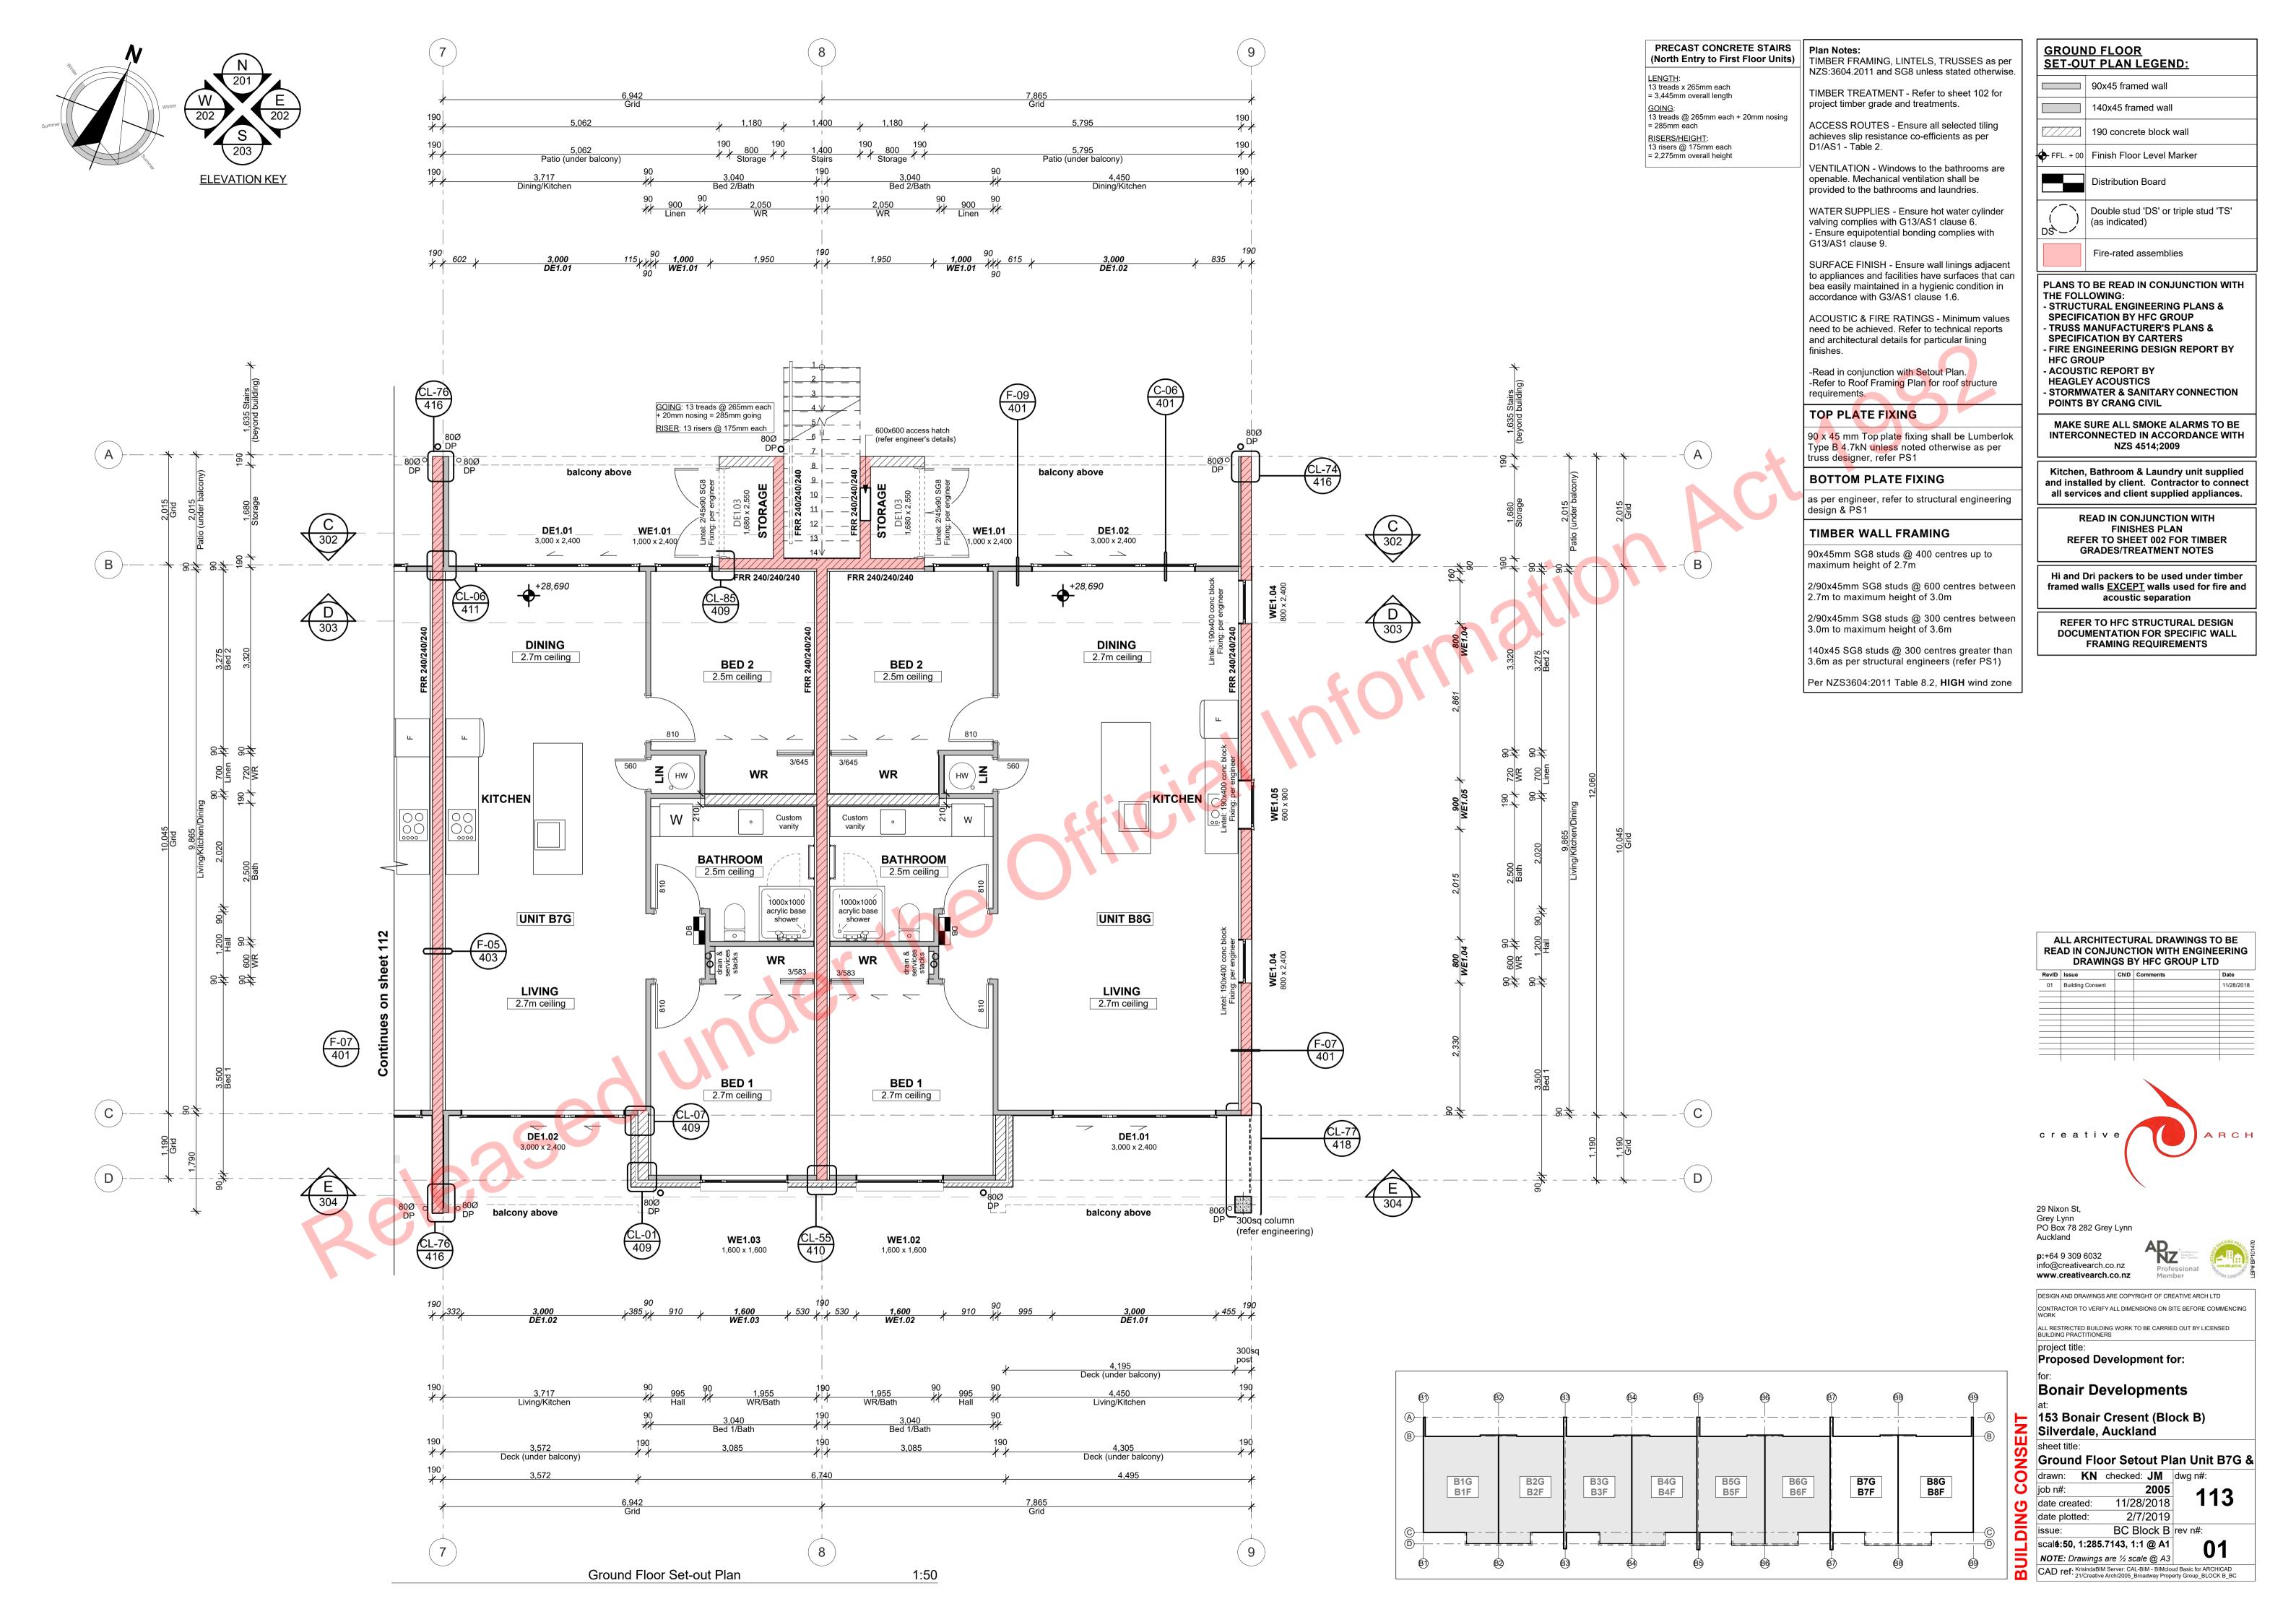

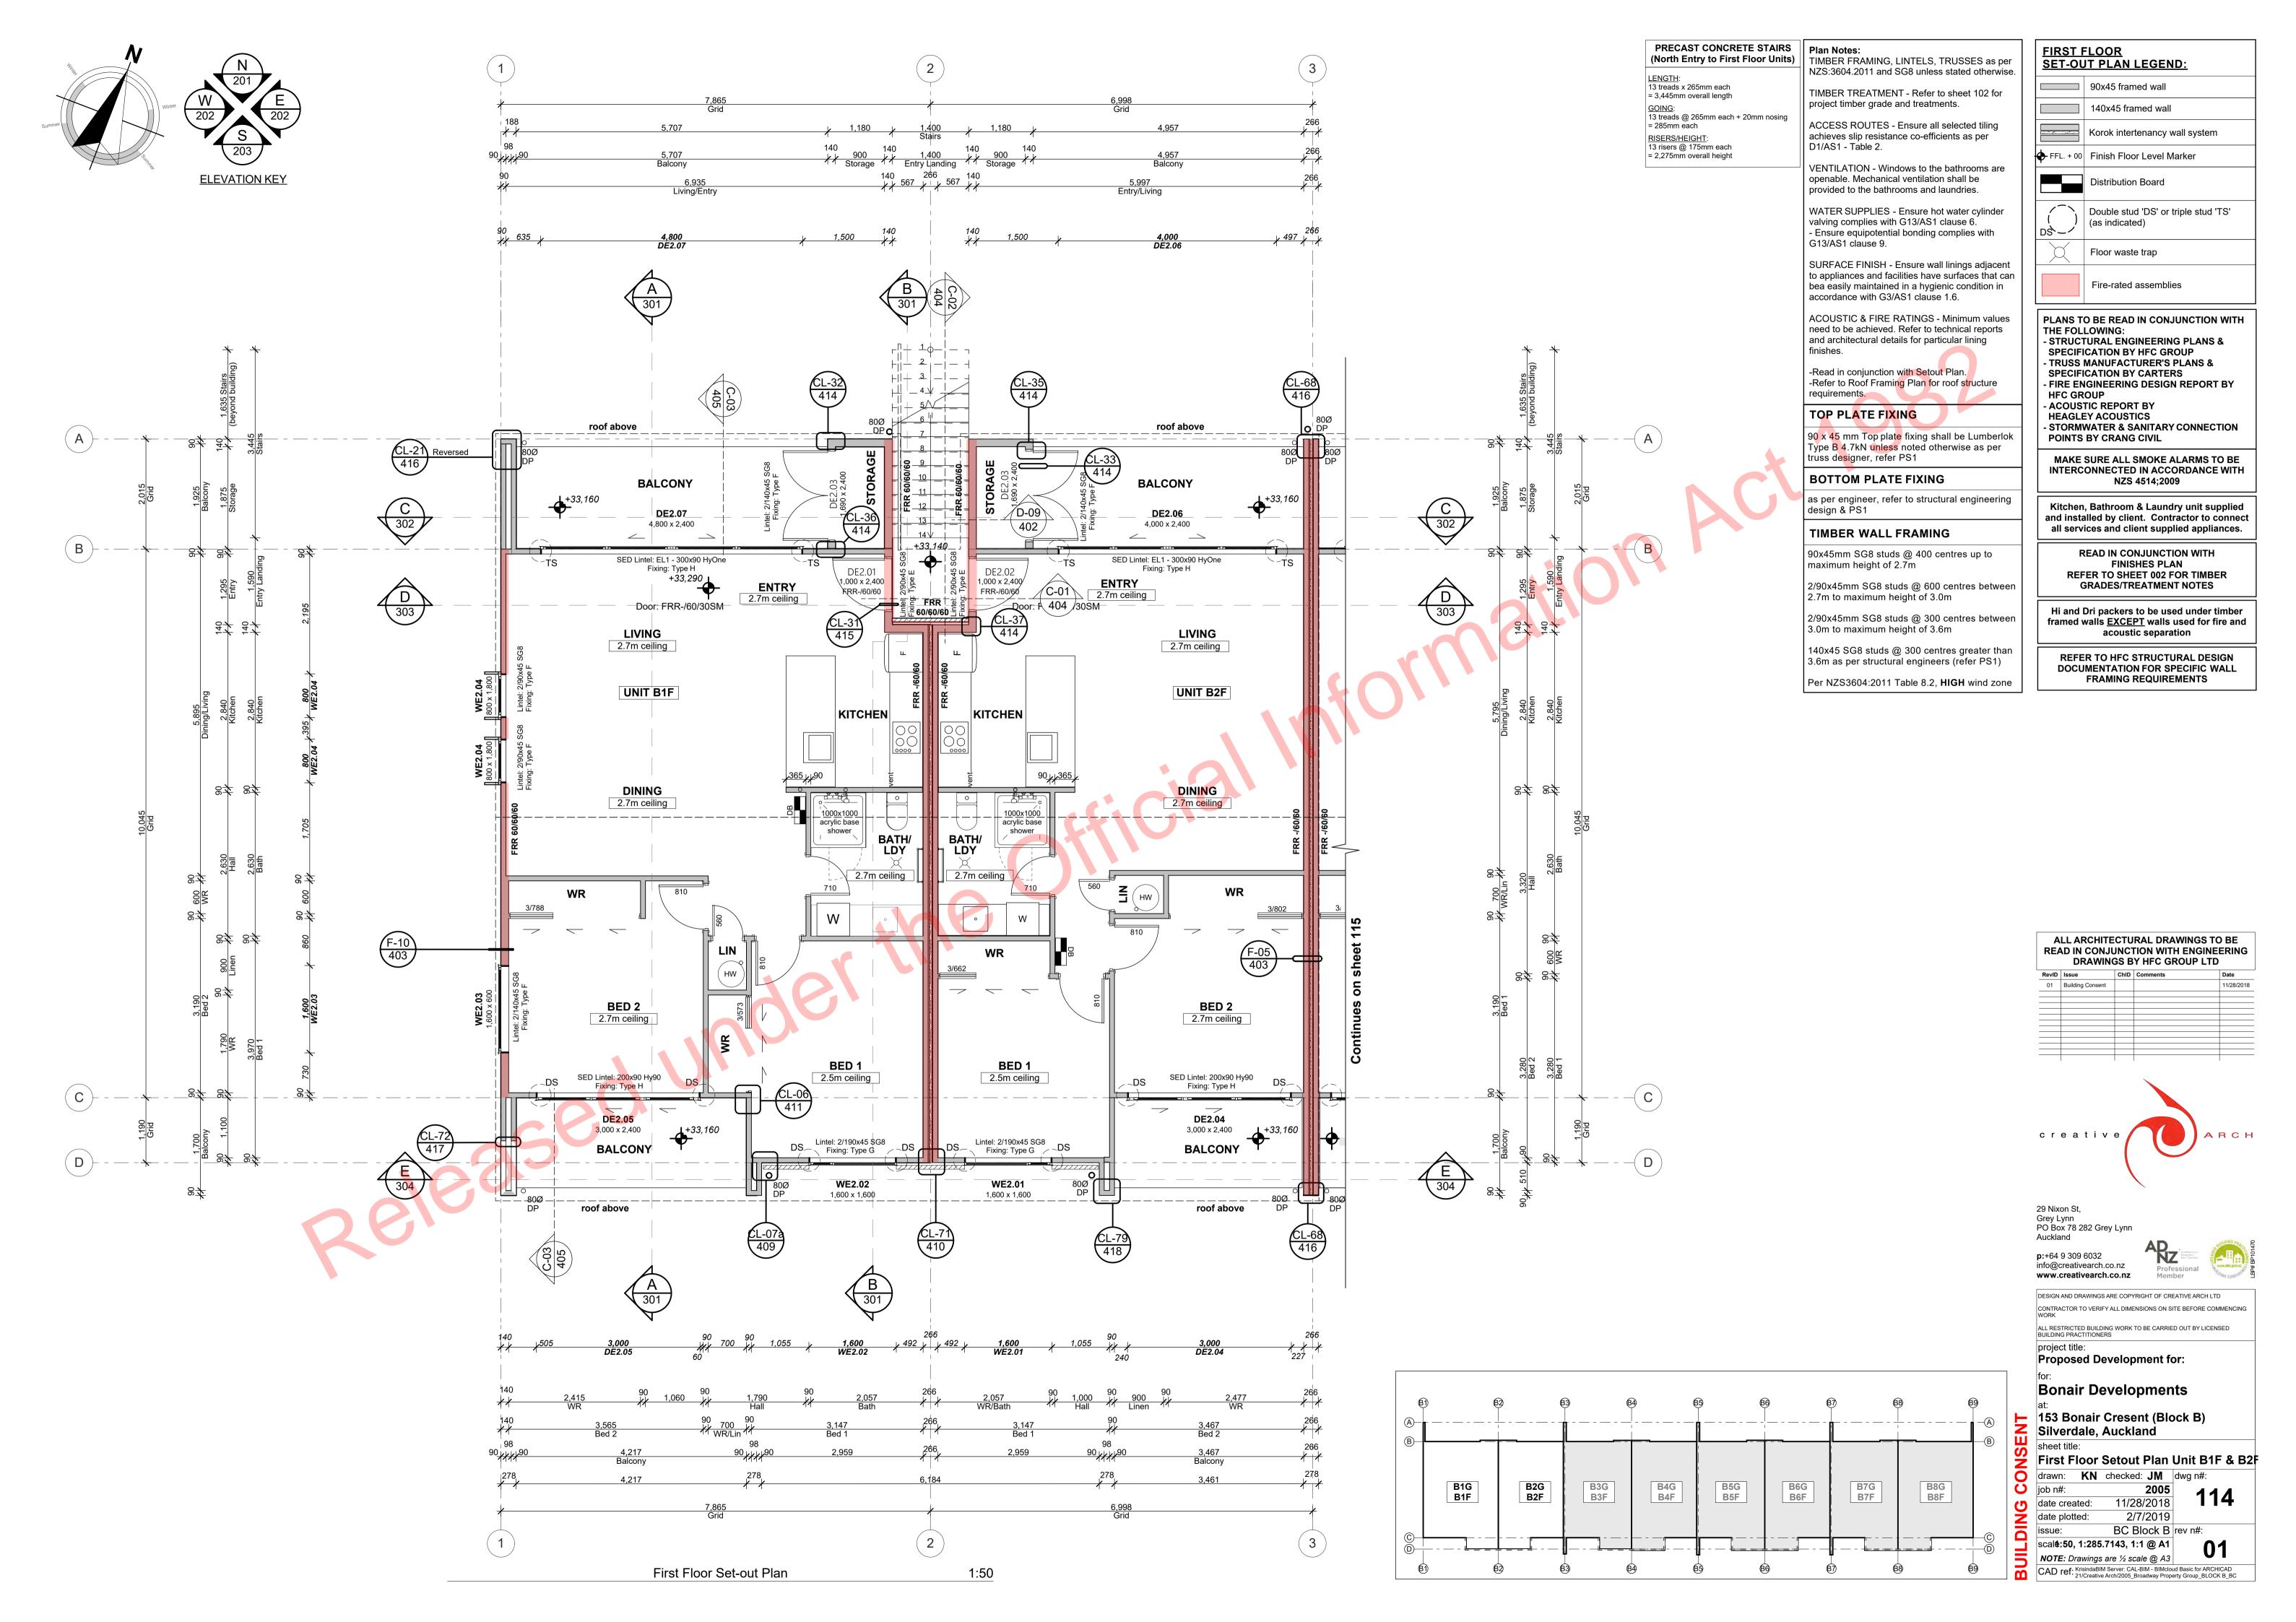

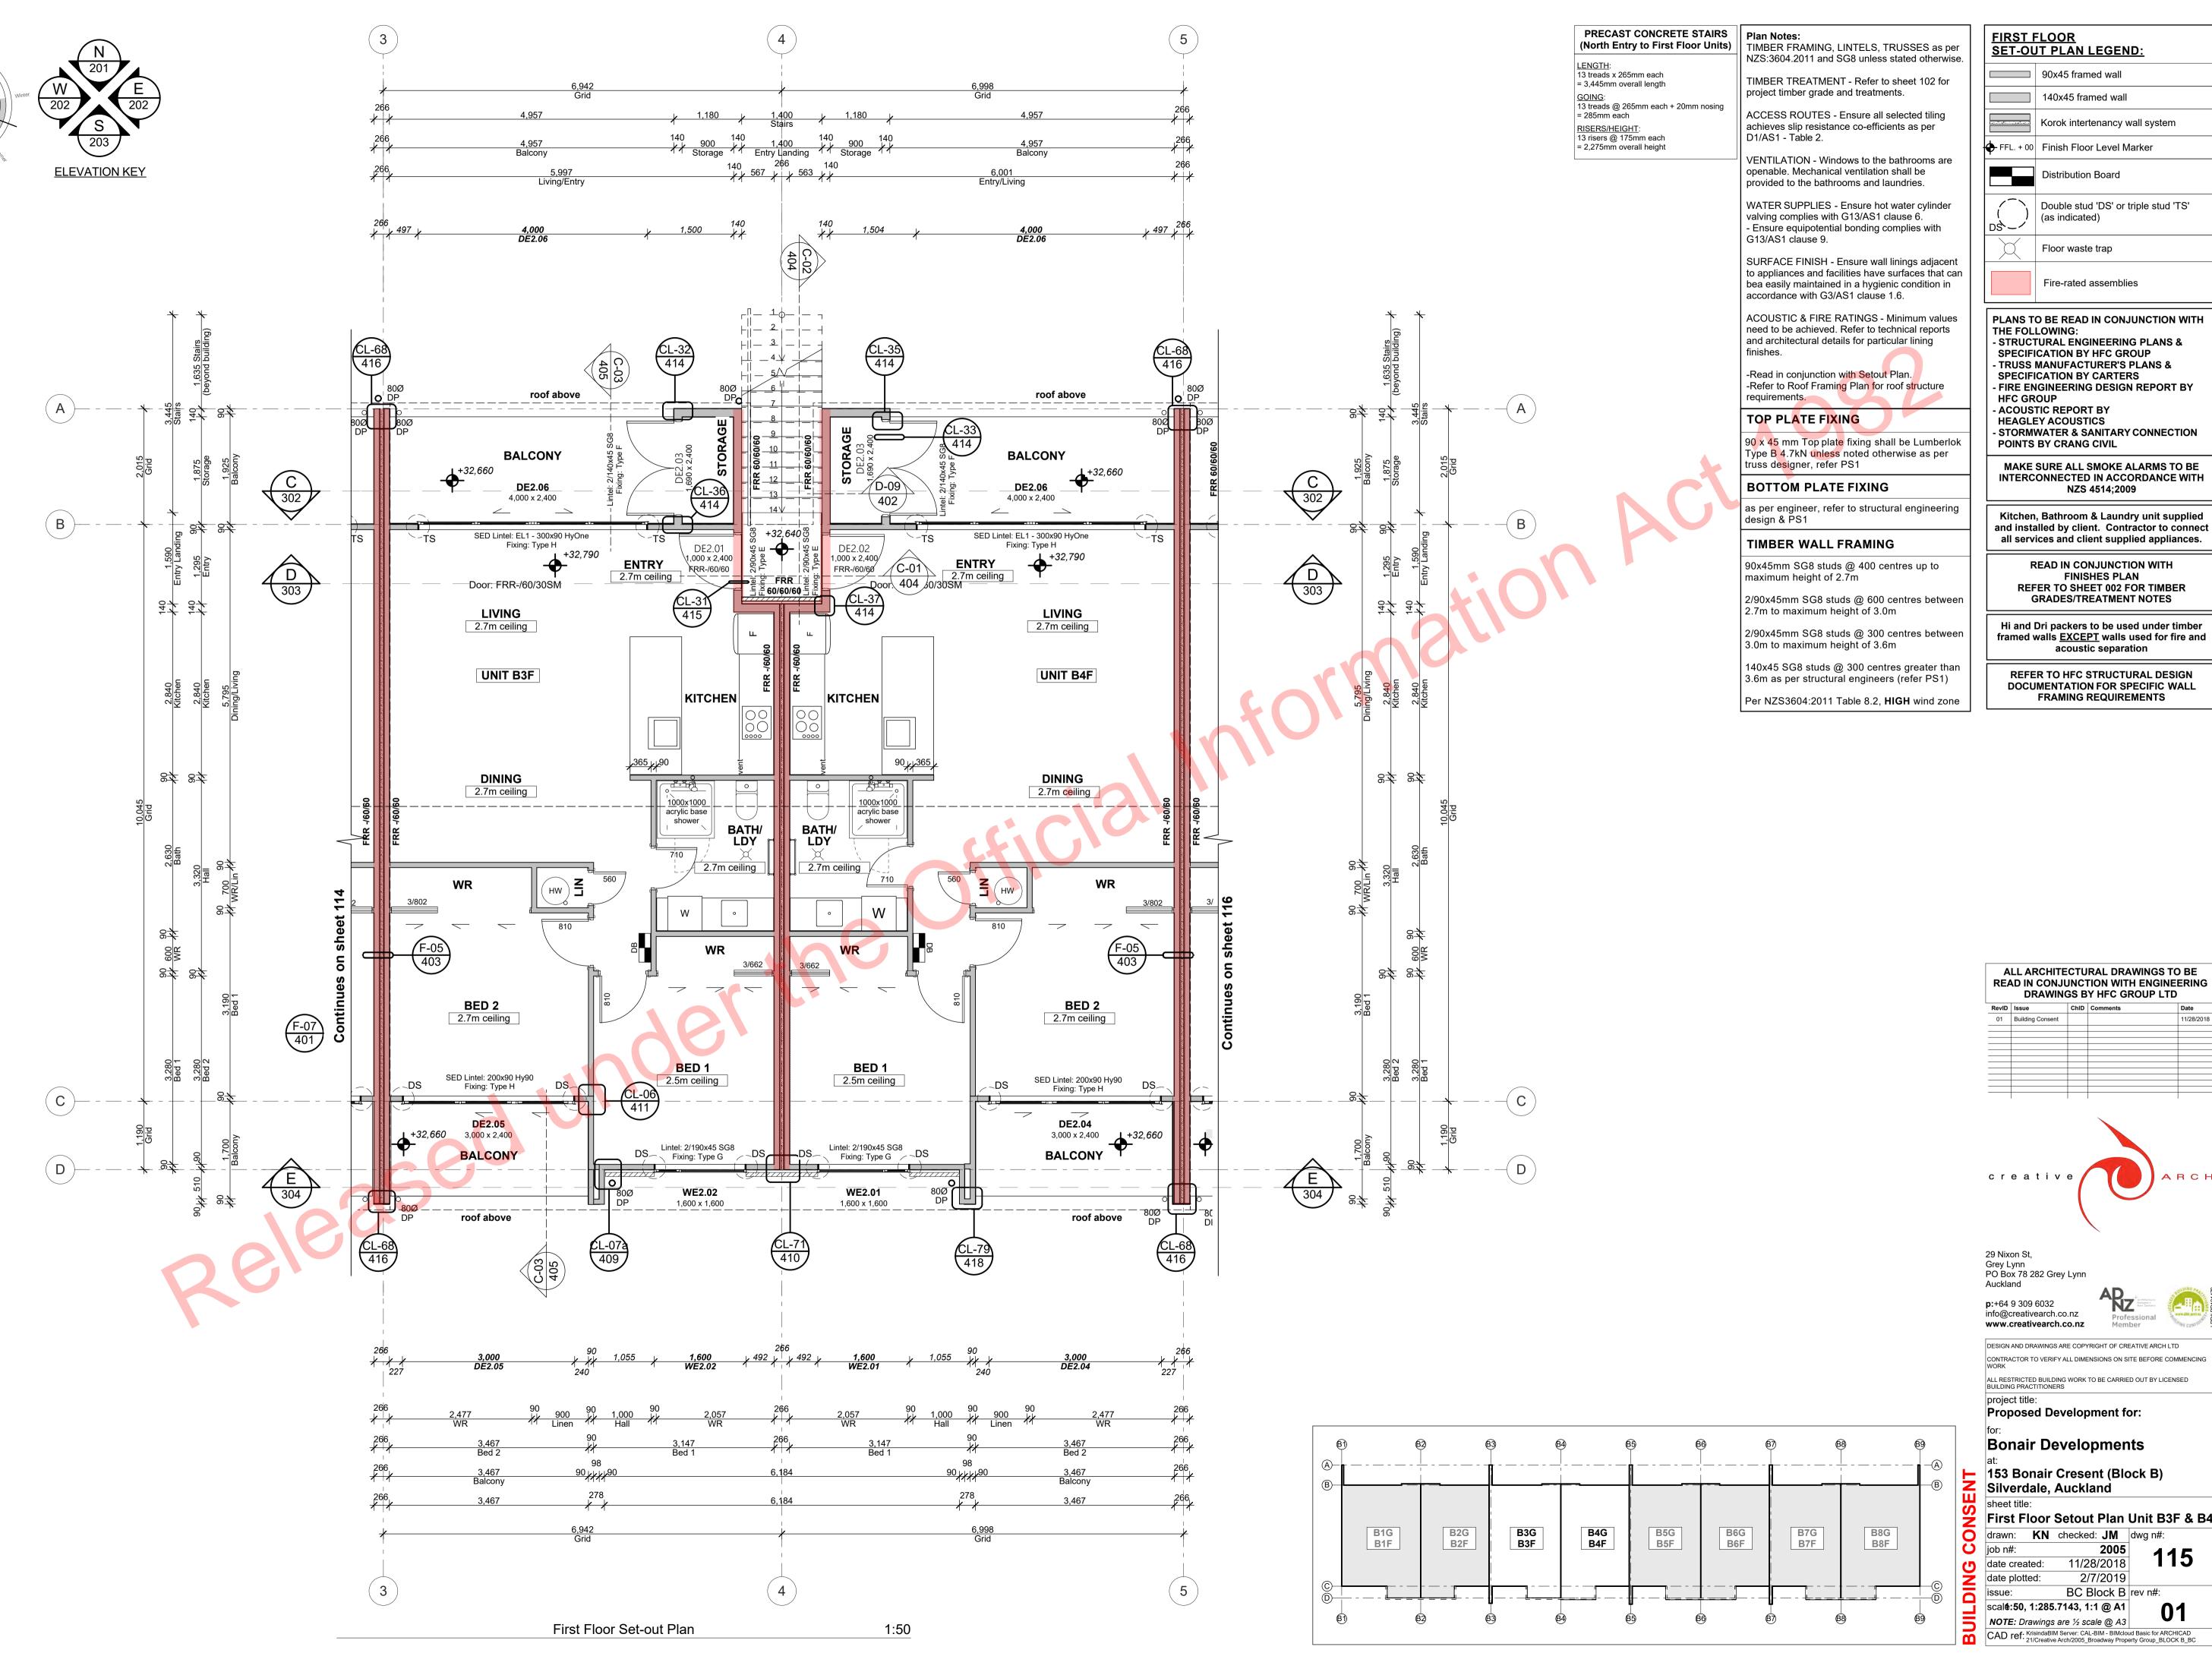

FIRST FLOOR SET-OUT PLAN LEGEND:

> framed walls **EXCEPT** walls used for fire and acoustic separation

REFER TO HFC STRUCTURAL DESIGN **DOCUMENTATION FOR SPECIFIC WALL**

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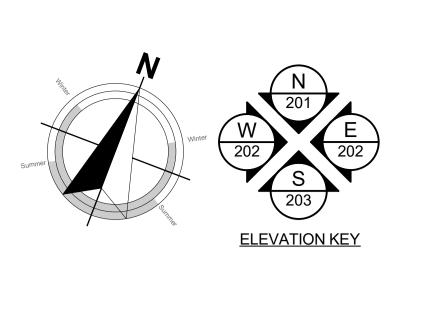
Bonair Developments


153 Bonair Cresent (Block B) Silverdale, Auckland

First Floor Setout Plan Unit B3F & B4 drawn: KN checked: JM dwg n#:

2005 11/28/2018 2/7/2019 BC Block B rev n#:

scal**é:50, 1:285.7143, 1:1 @ A1** NOTE: Drawings are ½ scale @ A3



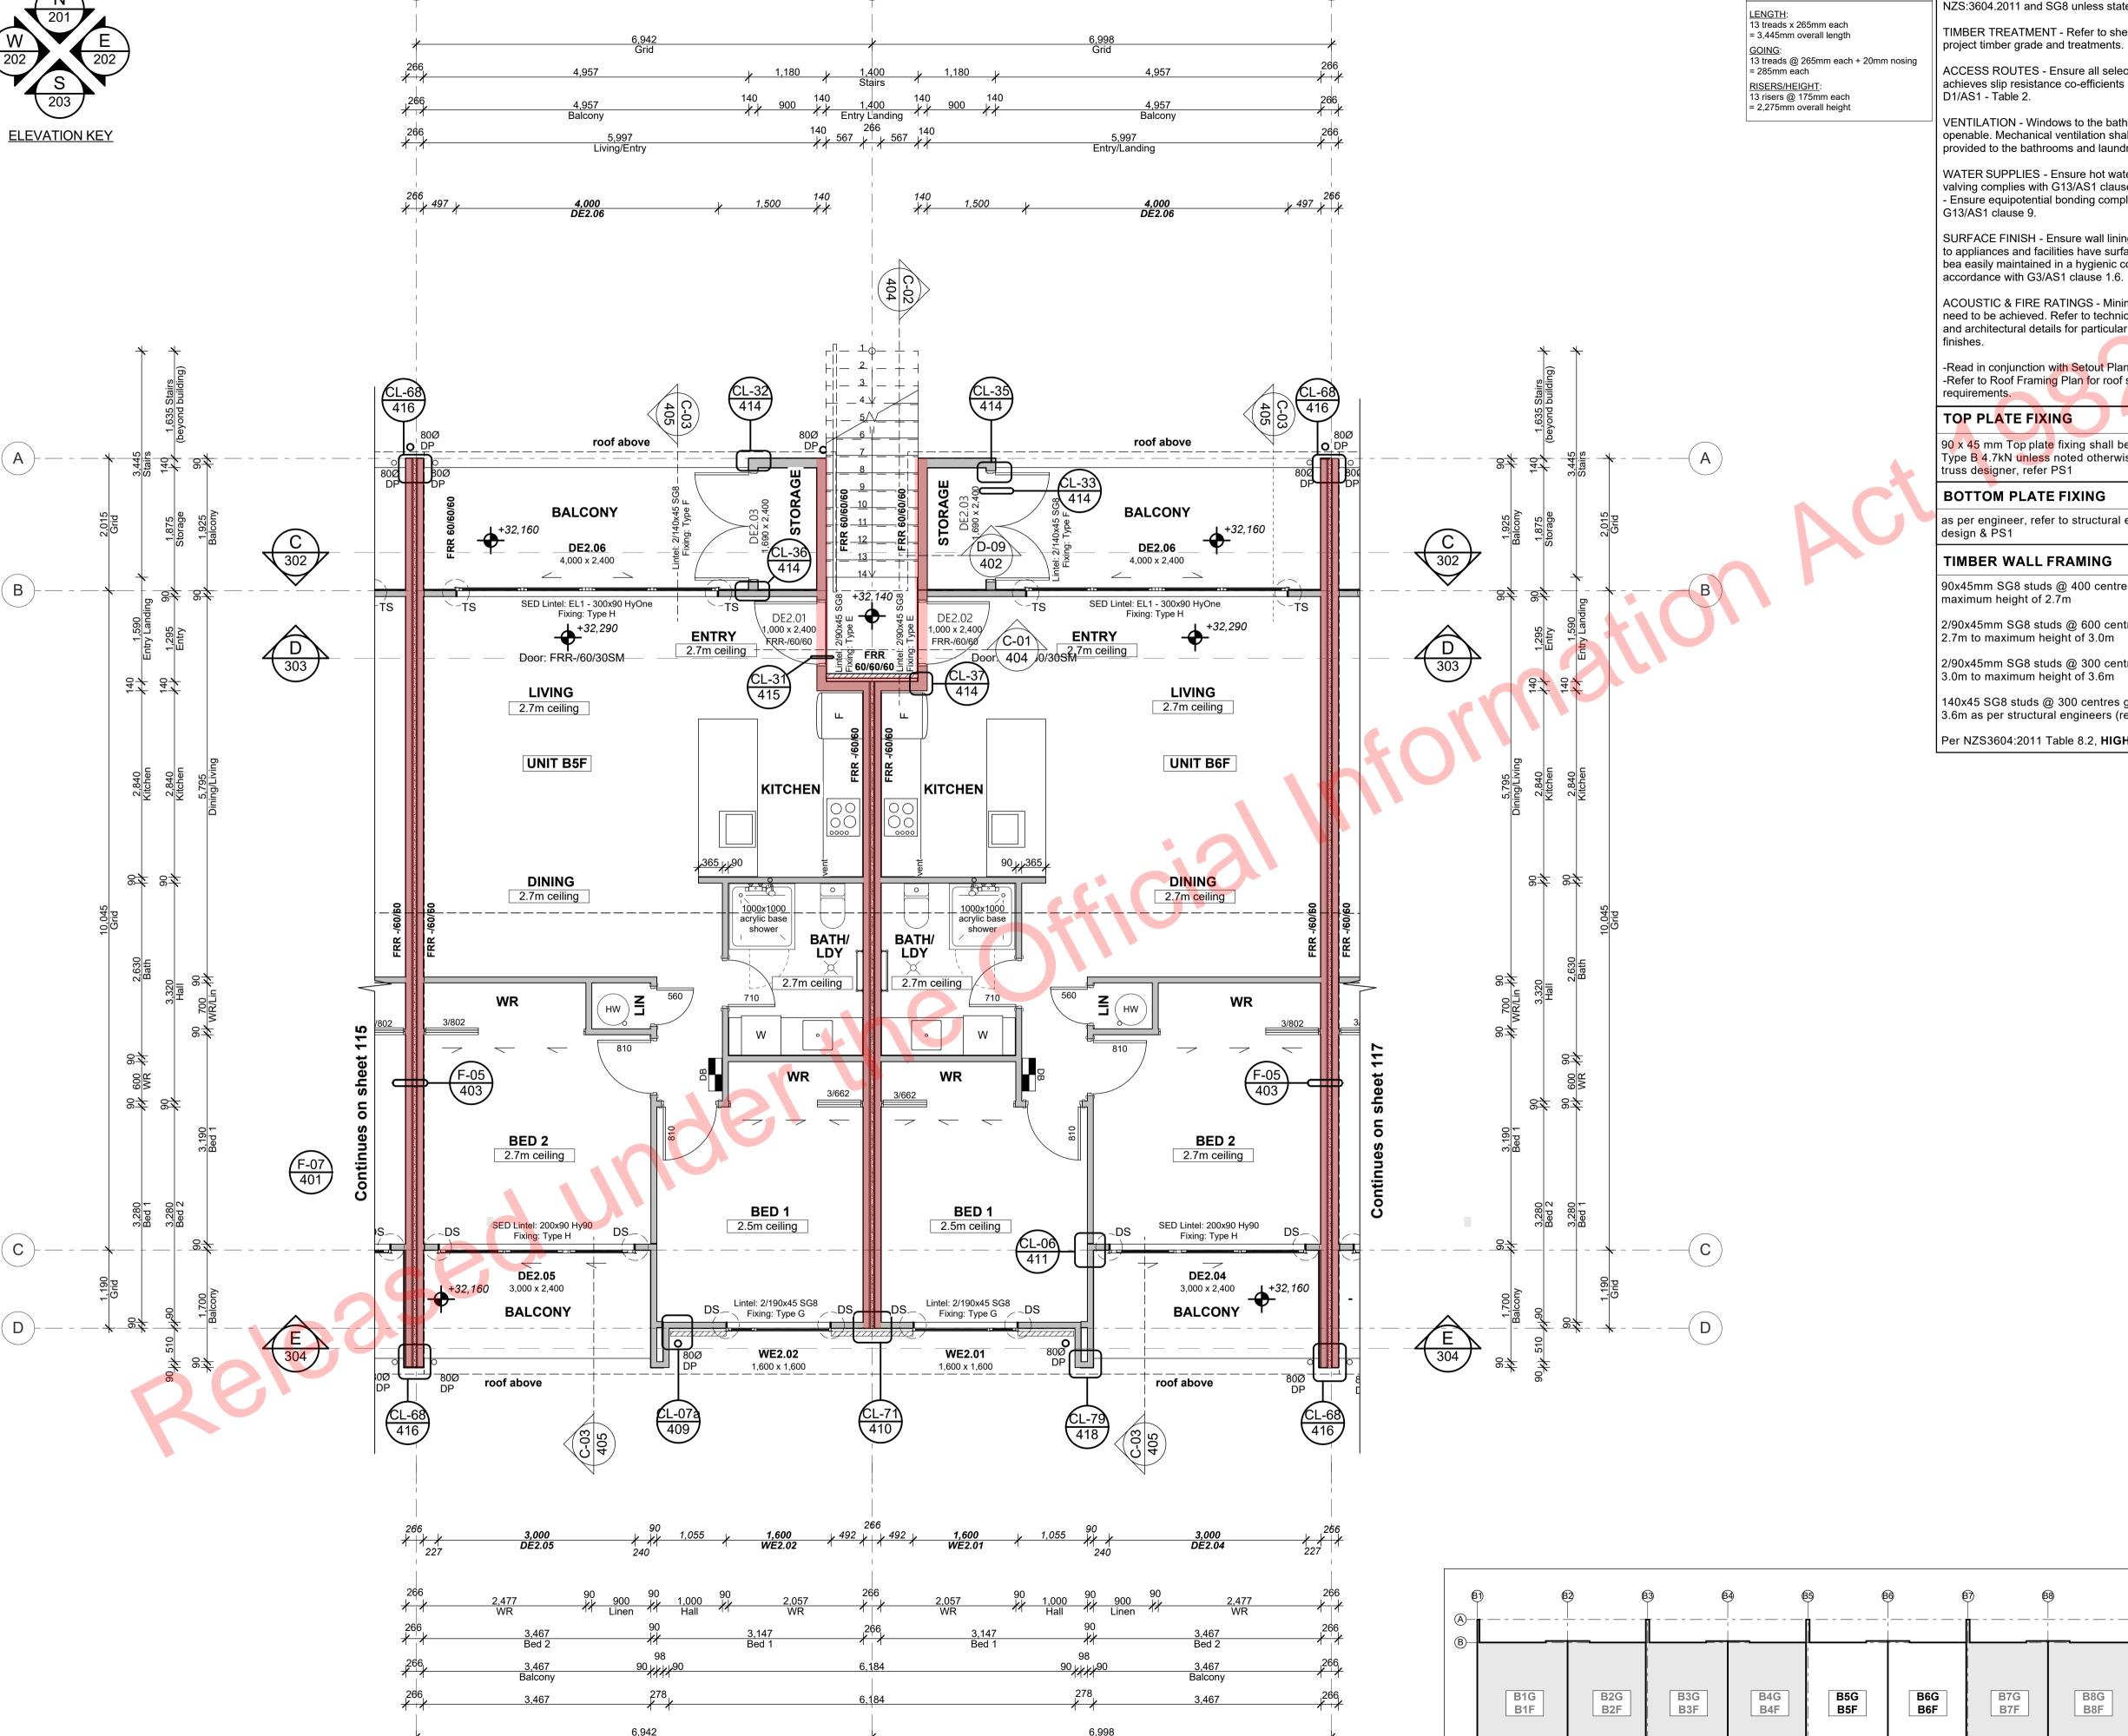

1:50

First Floor Set-out Plan

7

PRECAST CONCRETE STAIRS | Plan Notes: (North Entry to First Floor Units)

> openable. Mechanical ventilation shall be provided to the bathrooms and laundries.

valving complies with G13/AS1 clause 6. - Ensure equipotential bonding complies with G13/AS1 clause 9.

to appliances and facilities have surfaces that can bea easily maintained in a hygienic condition in

need to be achieved. Refer to technical reports and architectural details for particular lining

TOP PLATE FIXING

Type B 4.7kN unless noted otherwise as per truss designer, refer PS1

design & PS1

90x45mm SG8 studs @ 400 centres up to

2/90x45mm SG8 studs @ 600 centres between

2/90x45mm SG8 studs @ 300 centres between

140x45 SG8 studs @ 300 centres greater than

Per NZS3604:2011 Table 8.2, **HIGH** wind zone

TIMBER FRAMING, LINTELS, TRUSSES as per

NZS:3604.2011 and SG8 unless stated otherwise. TIMBER TREATMENT - Refer to sheet 102 for

ACCESS ROUTES - Ensure all selected tiling achieves slip resistance co-efficients as per D1/AS1 - Table 2.

VENTILATION - Windows to the bathrooms are

WATER SUPPLIES - Ensure hot water cylinder

SURFACE FINISH - Ensure wall linings adjacent accordance with G3/AS1 clause 1.6.

ACOUSTIC & FIRE RATINGS - Minimum values

-Read in conjunction with Setout Plan. -Refer to Roof Framing Plan for roof structure

90 x 45 mm Top plate fixing shall be Lumberlok

BOTTOM PLATE FIXING

as per engineer, refer to structural engineering

maximum height of 2.7m

2.7m to maximum height of 3.0m

3.0m to maximum height of 3.6m

3.6m as per structural engineers (refer PS1)

FIRST FLOOR SET-OUT PLAN LEGEND:

90x45 framed wall 140x45 framed wall

Korok intertenancy wall system FFL. + 00 Finish Floor Level Marker

Distribution Board Double stud 'DS' or triple stud 'TS' (as indicated)

Floor waste trap

Fire-rated assemblies PLANS TO BE READ IN CONJUNCTION WITH THE FOLLOWING:

SPECIFICATION BY HFC GROUP - TRUSS MANUFACTURER'S PLANS & SPECIFICATION BY CARTERS - FIRE ENGINEERING DESIGN REPORT BY **HFC GROUP** - ACOUSTIC REPORT BY

- STRUCTURAL ENGINEERING PLANS &

HEAGLEY ACOUSTICS - STORMWATER & SANITARY CONNECTION POINTS BY CRANG CIVIL


MAKE SURE ALL SMOKE ALARMS TO BE INTERCONNECTED IN ACCORDANCE WITH NZS 4514;2009

Kitchen, Bathroom & Laundry unit supplied and installed by client. Contractor to connect all services and client supplied appliances.

> READ IN CONJUNCTION WITH **FINISHES PLAN** REFER TO SHEET 002 FOR TIMBER **GRADES/TREATMENT NOTES**

Hi and Dri packers to be used under timber framed walls **EXCEPT** walls used for fire and acoustic separation

REFER TO HFC STRUCTURAL DESIGN **DOCUMENTATION FOR SPECIFIC WALL** FRAMING REQUIREMENTS

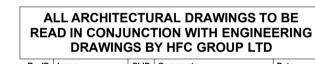



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project title: Proposed Development for:

Bonair Developments


Silverdale, Auckland


First Floor Setout Plan Unit B5F & B6 drawn: KN checked: JM dwg n#:


116 11/28/2018 date created: 2/7/2019 BC Block B rev n#: scal**é:50, 1:285.7143, 1:1 @ A1**


B8F


NOTE: Drawings are ½ scale @ A3 CAD ref: KrisindaBIM Server: CAL-BIM - BIMCloud Basic for ARCHICAD 21/Creative Arch/2005_Broadway Property Group_BLOCK B_BC

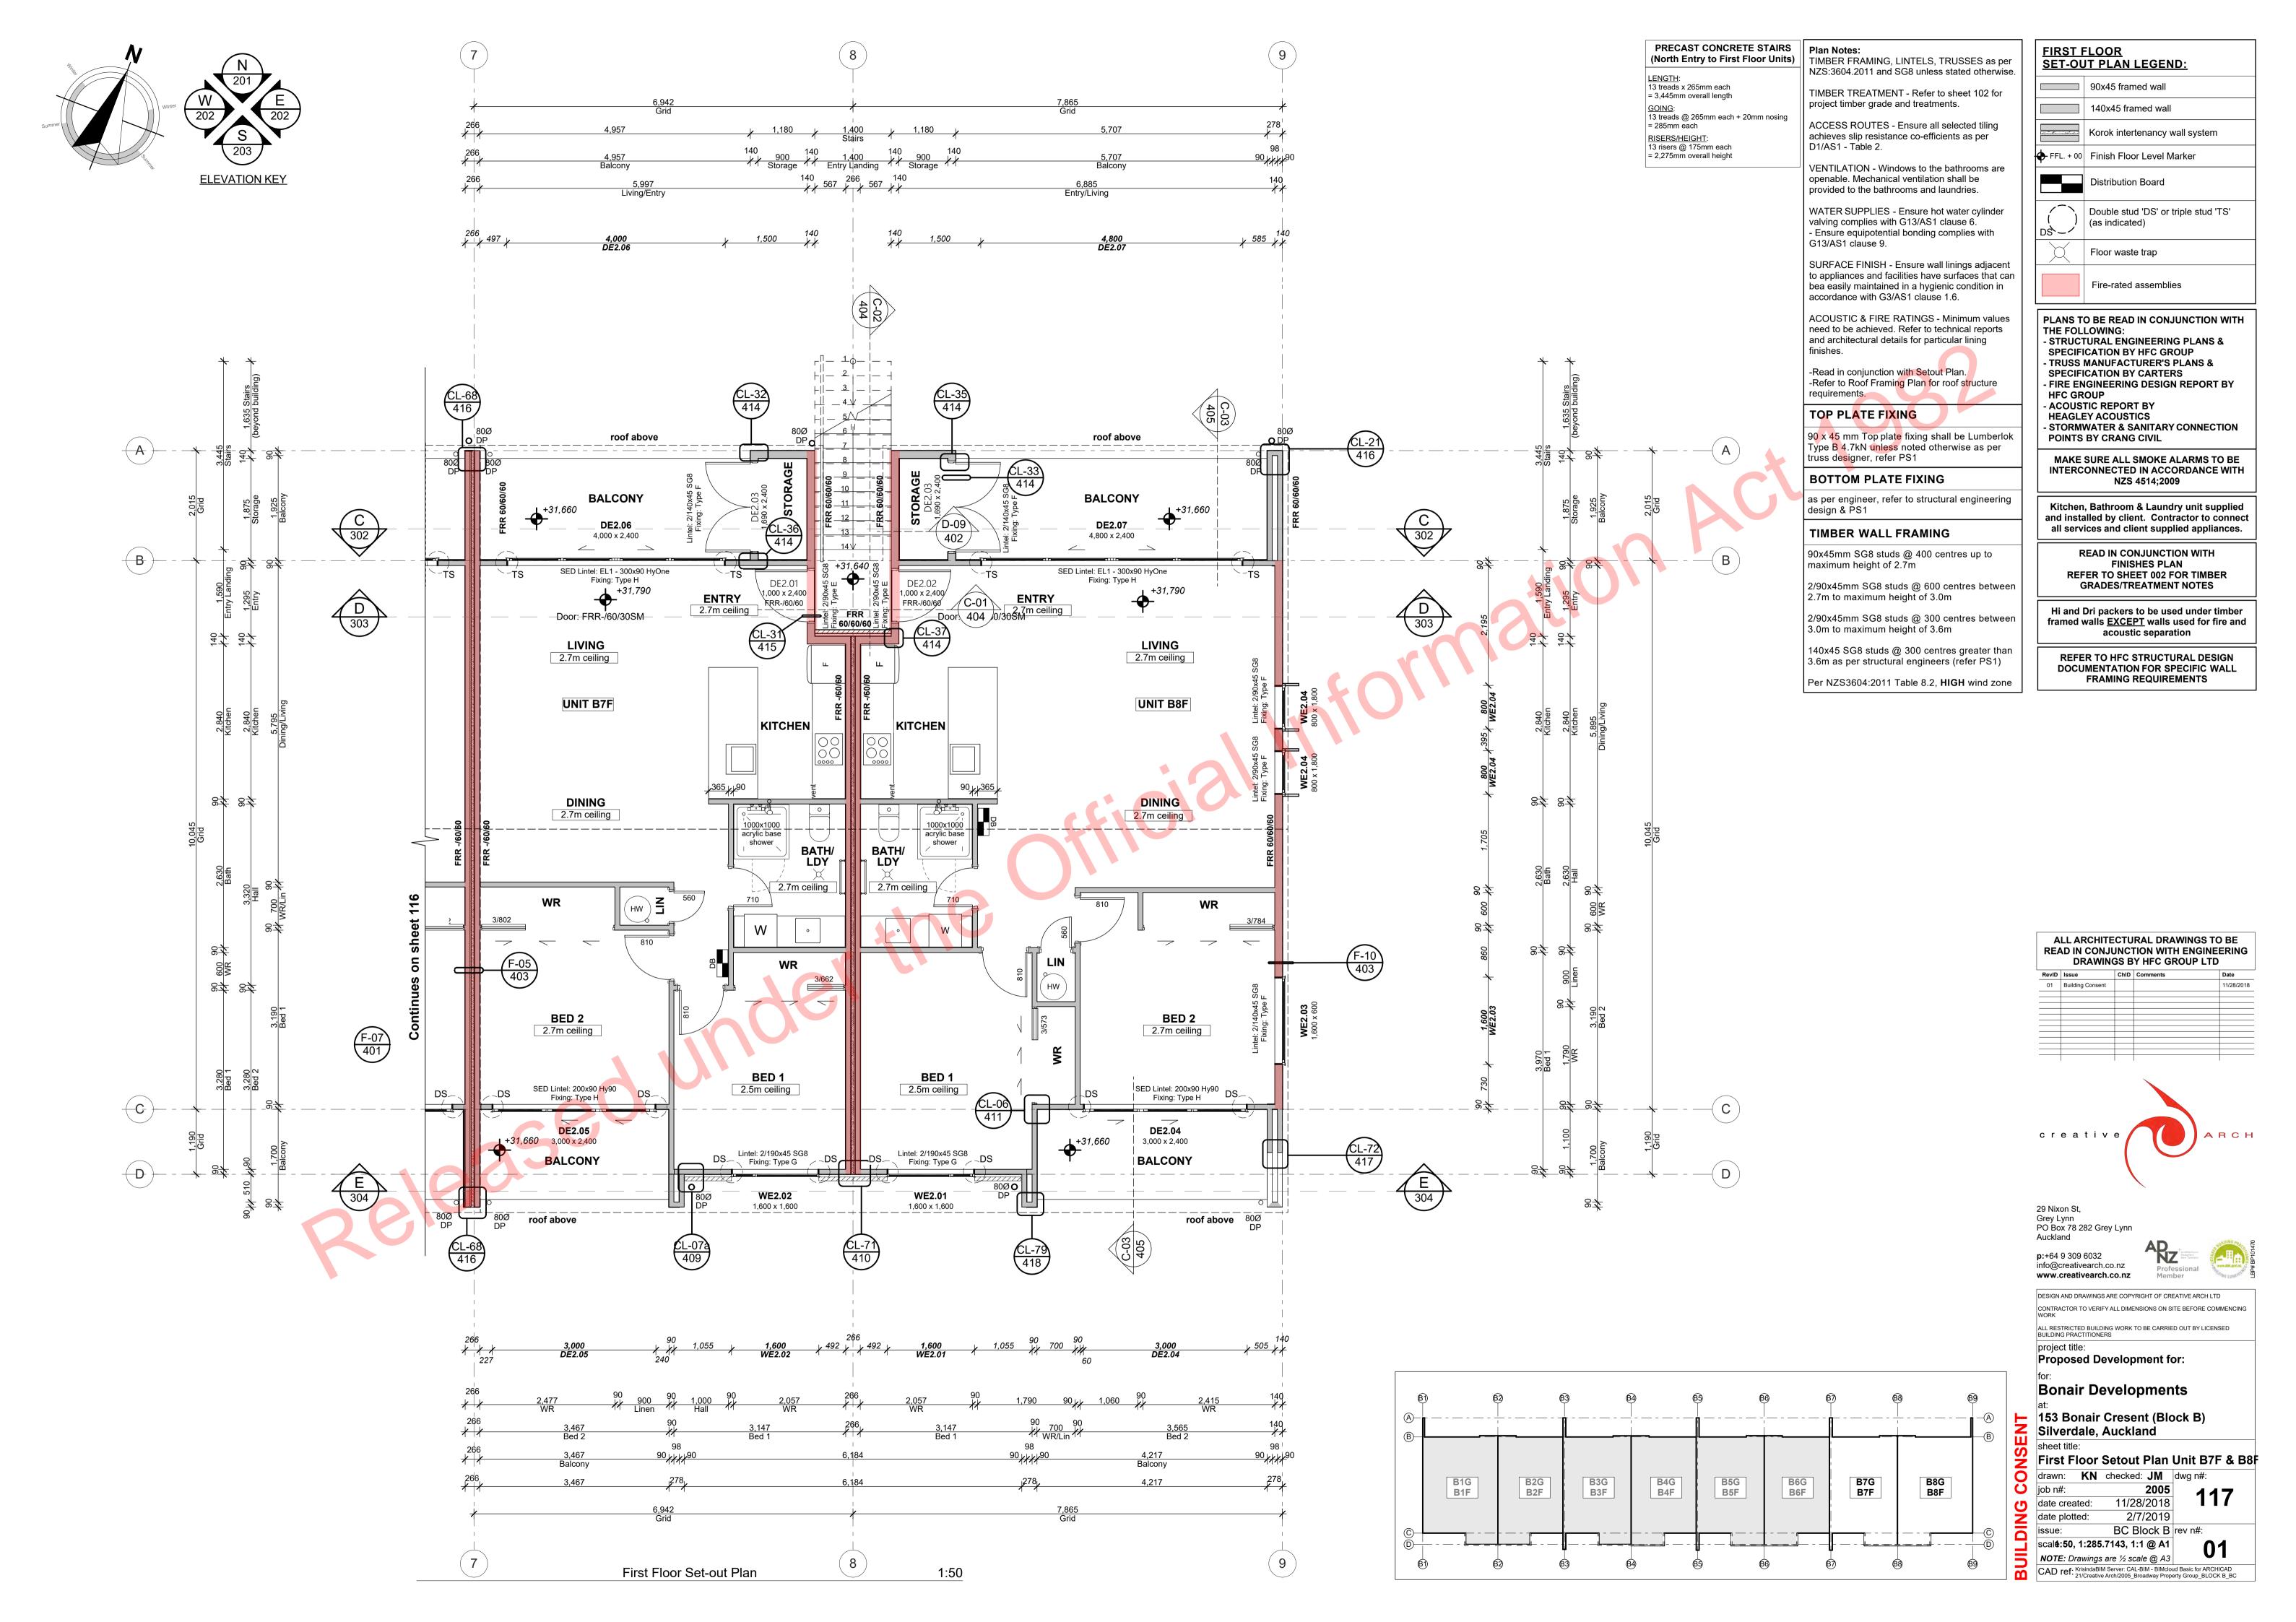


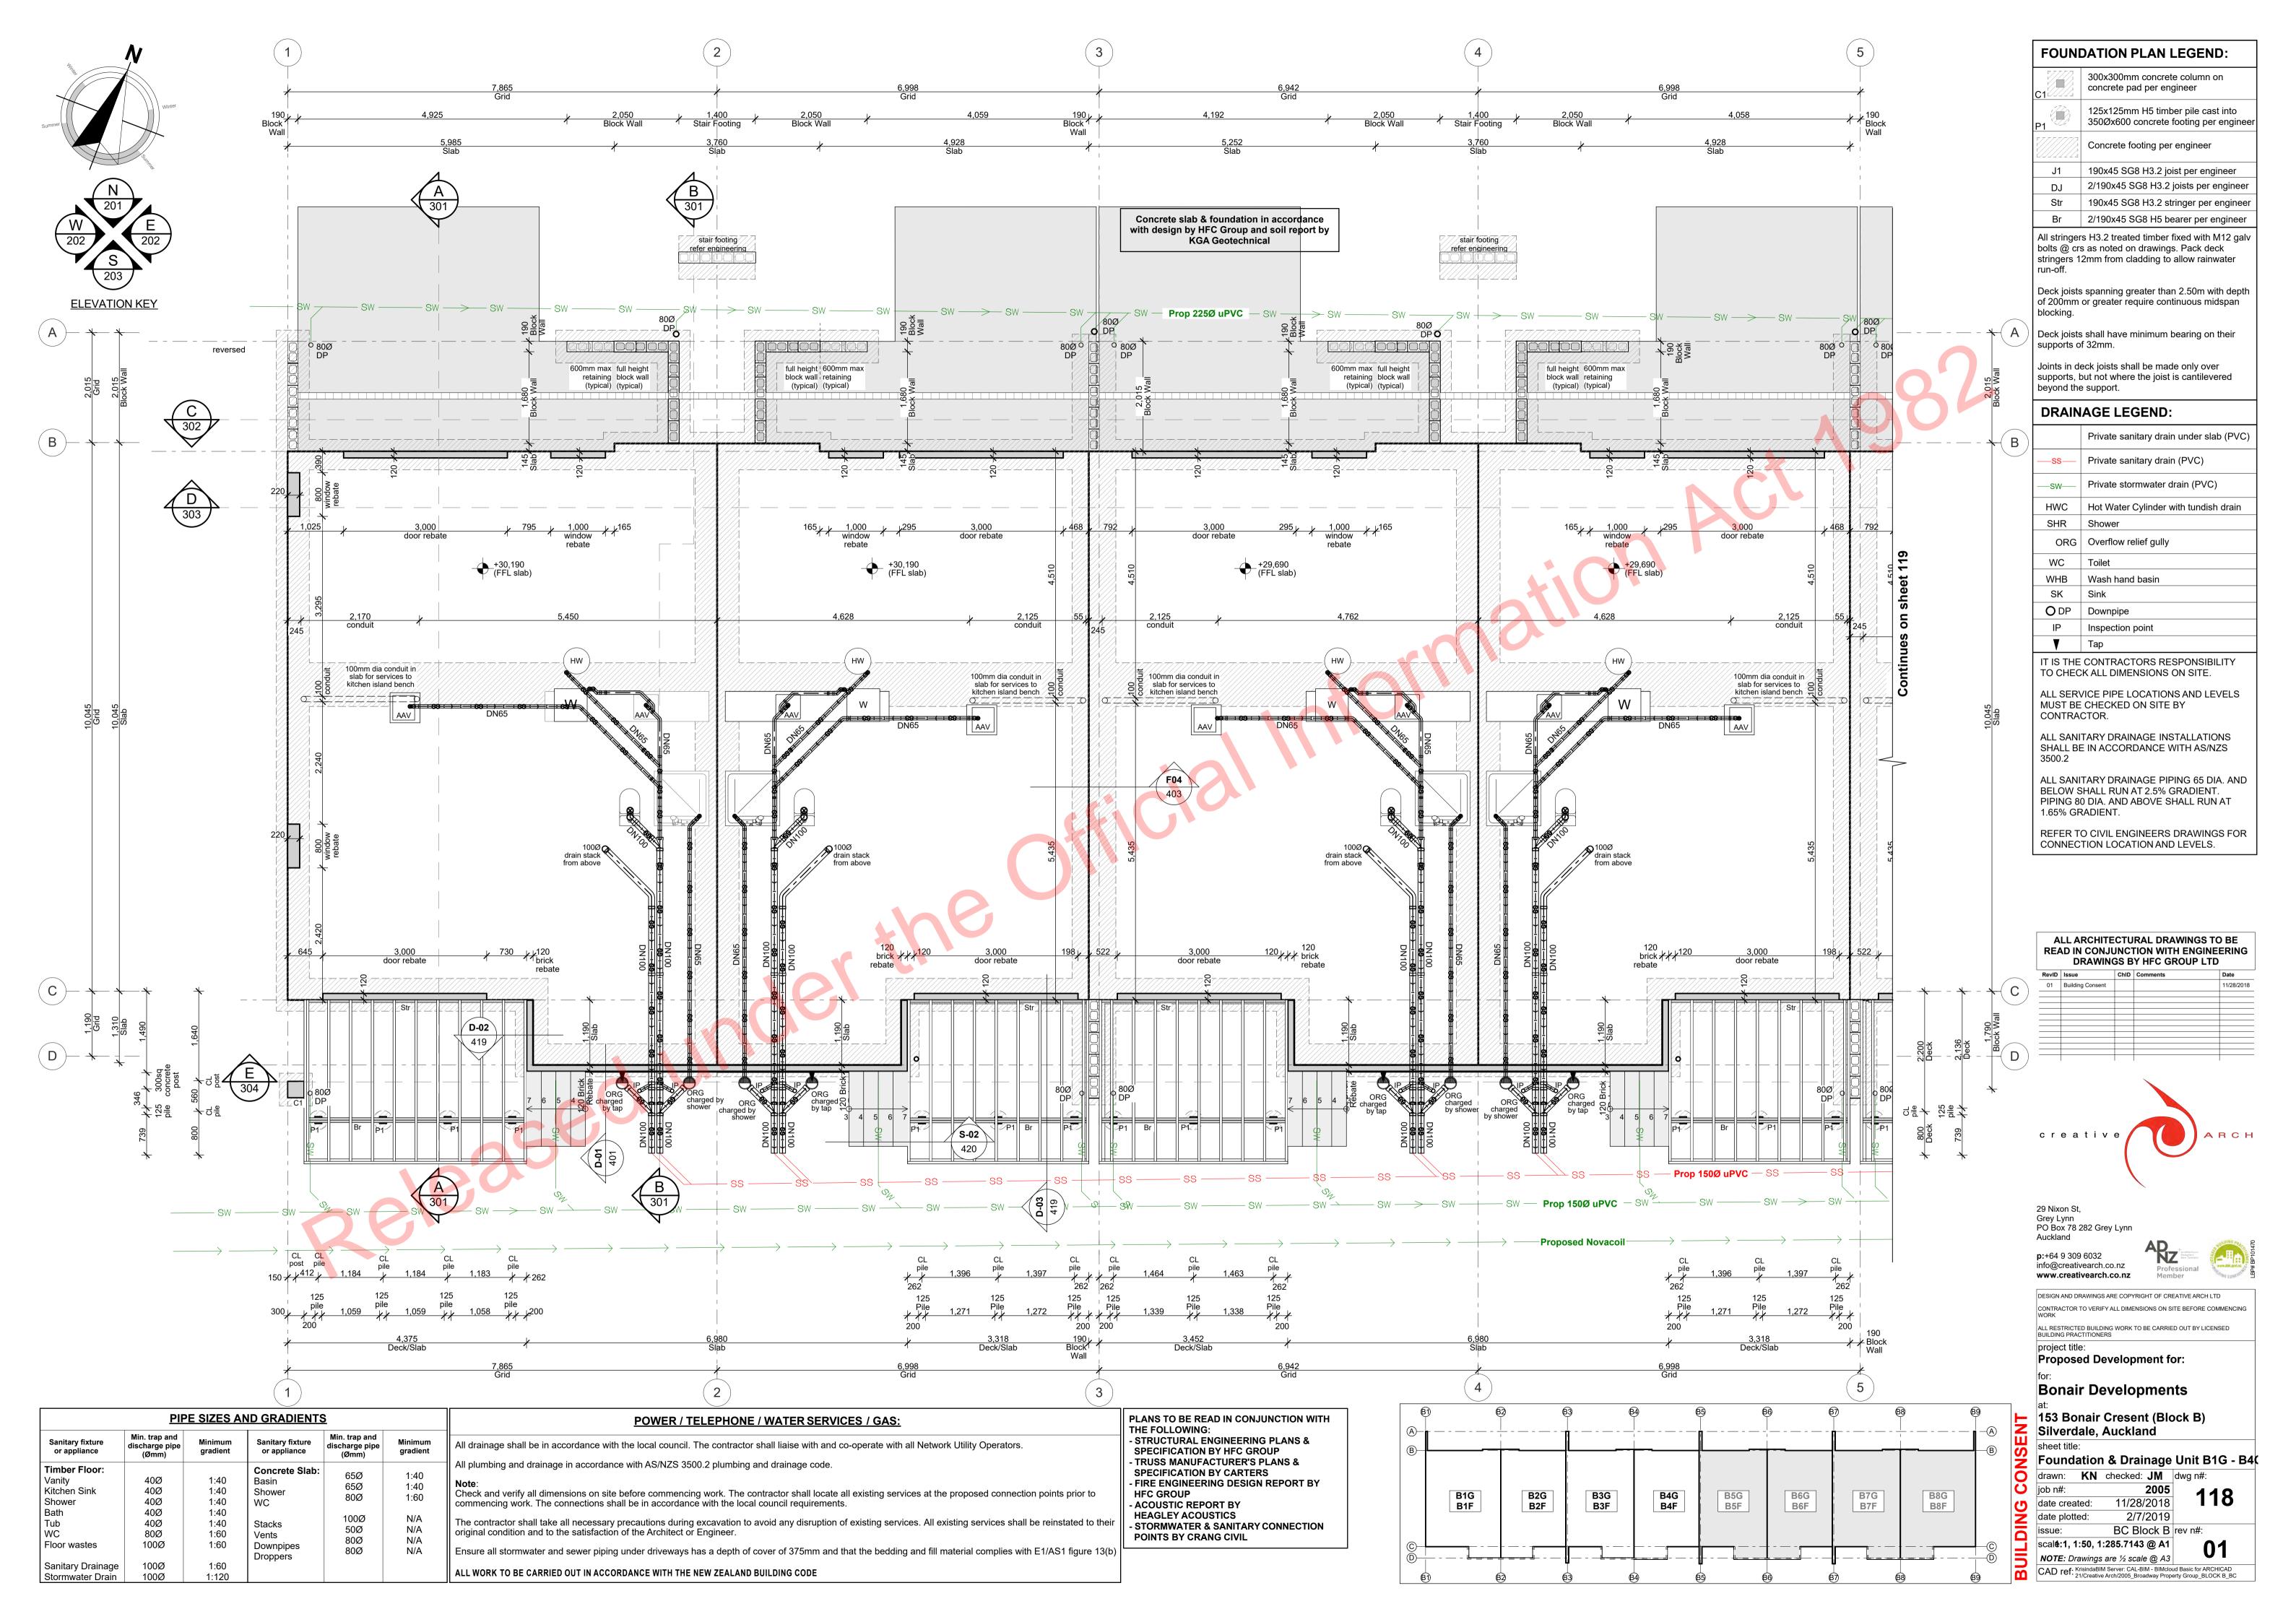


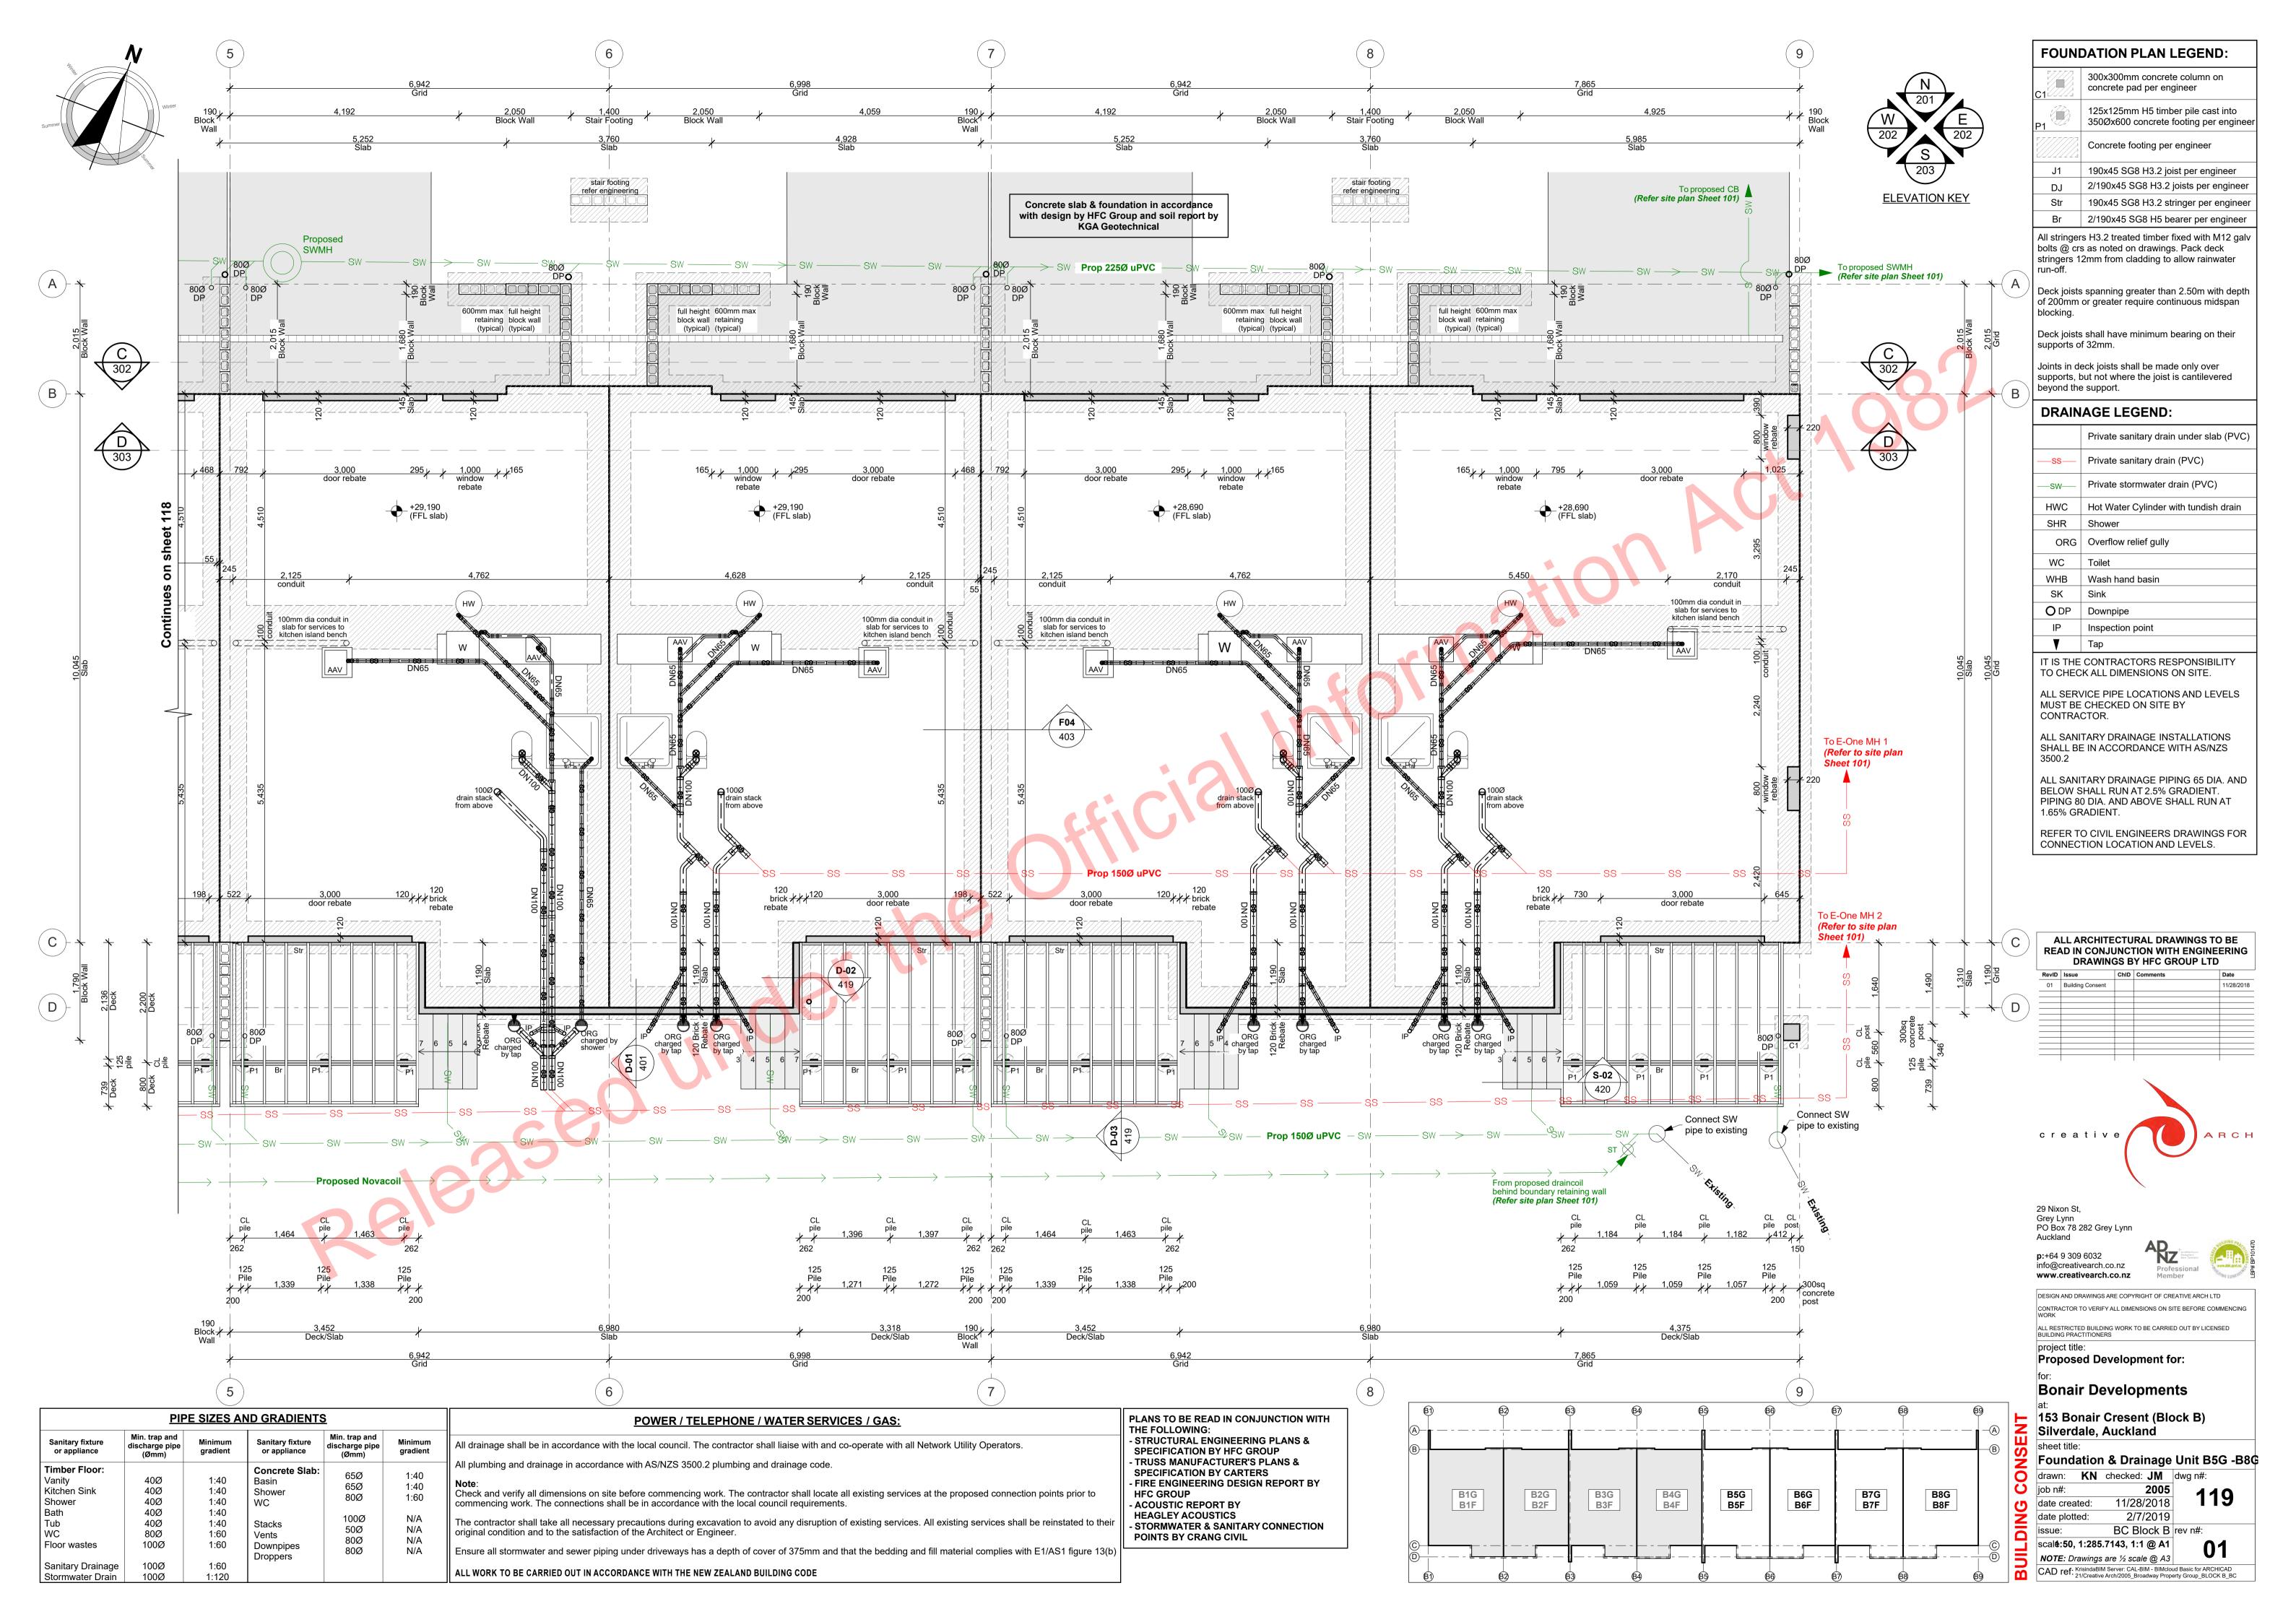


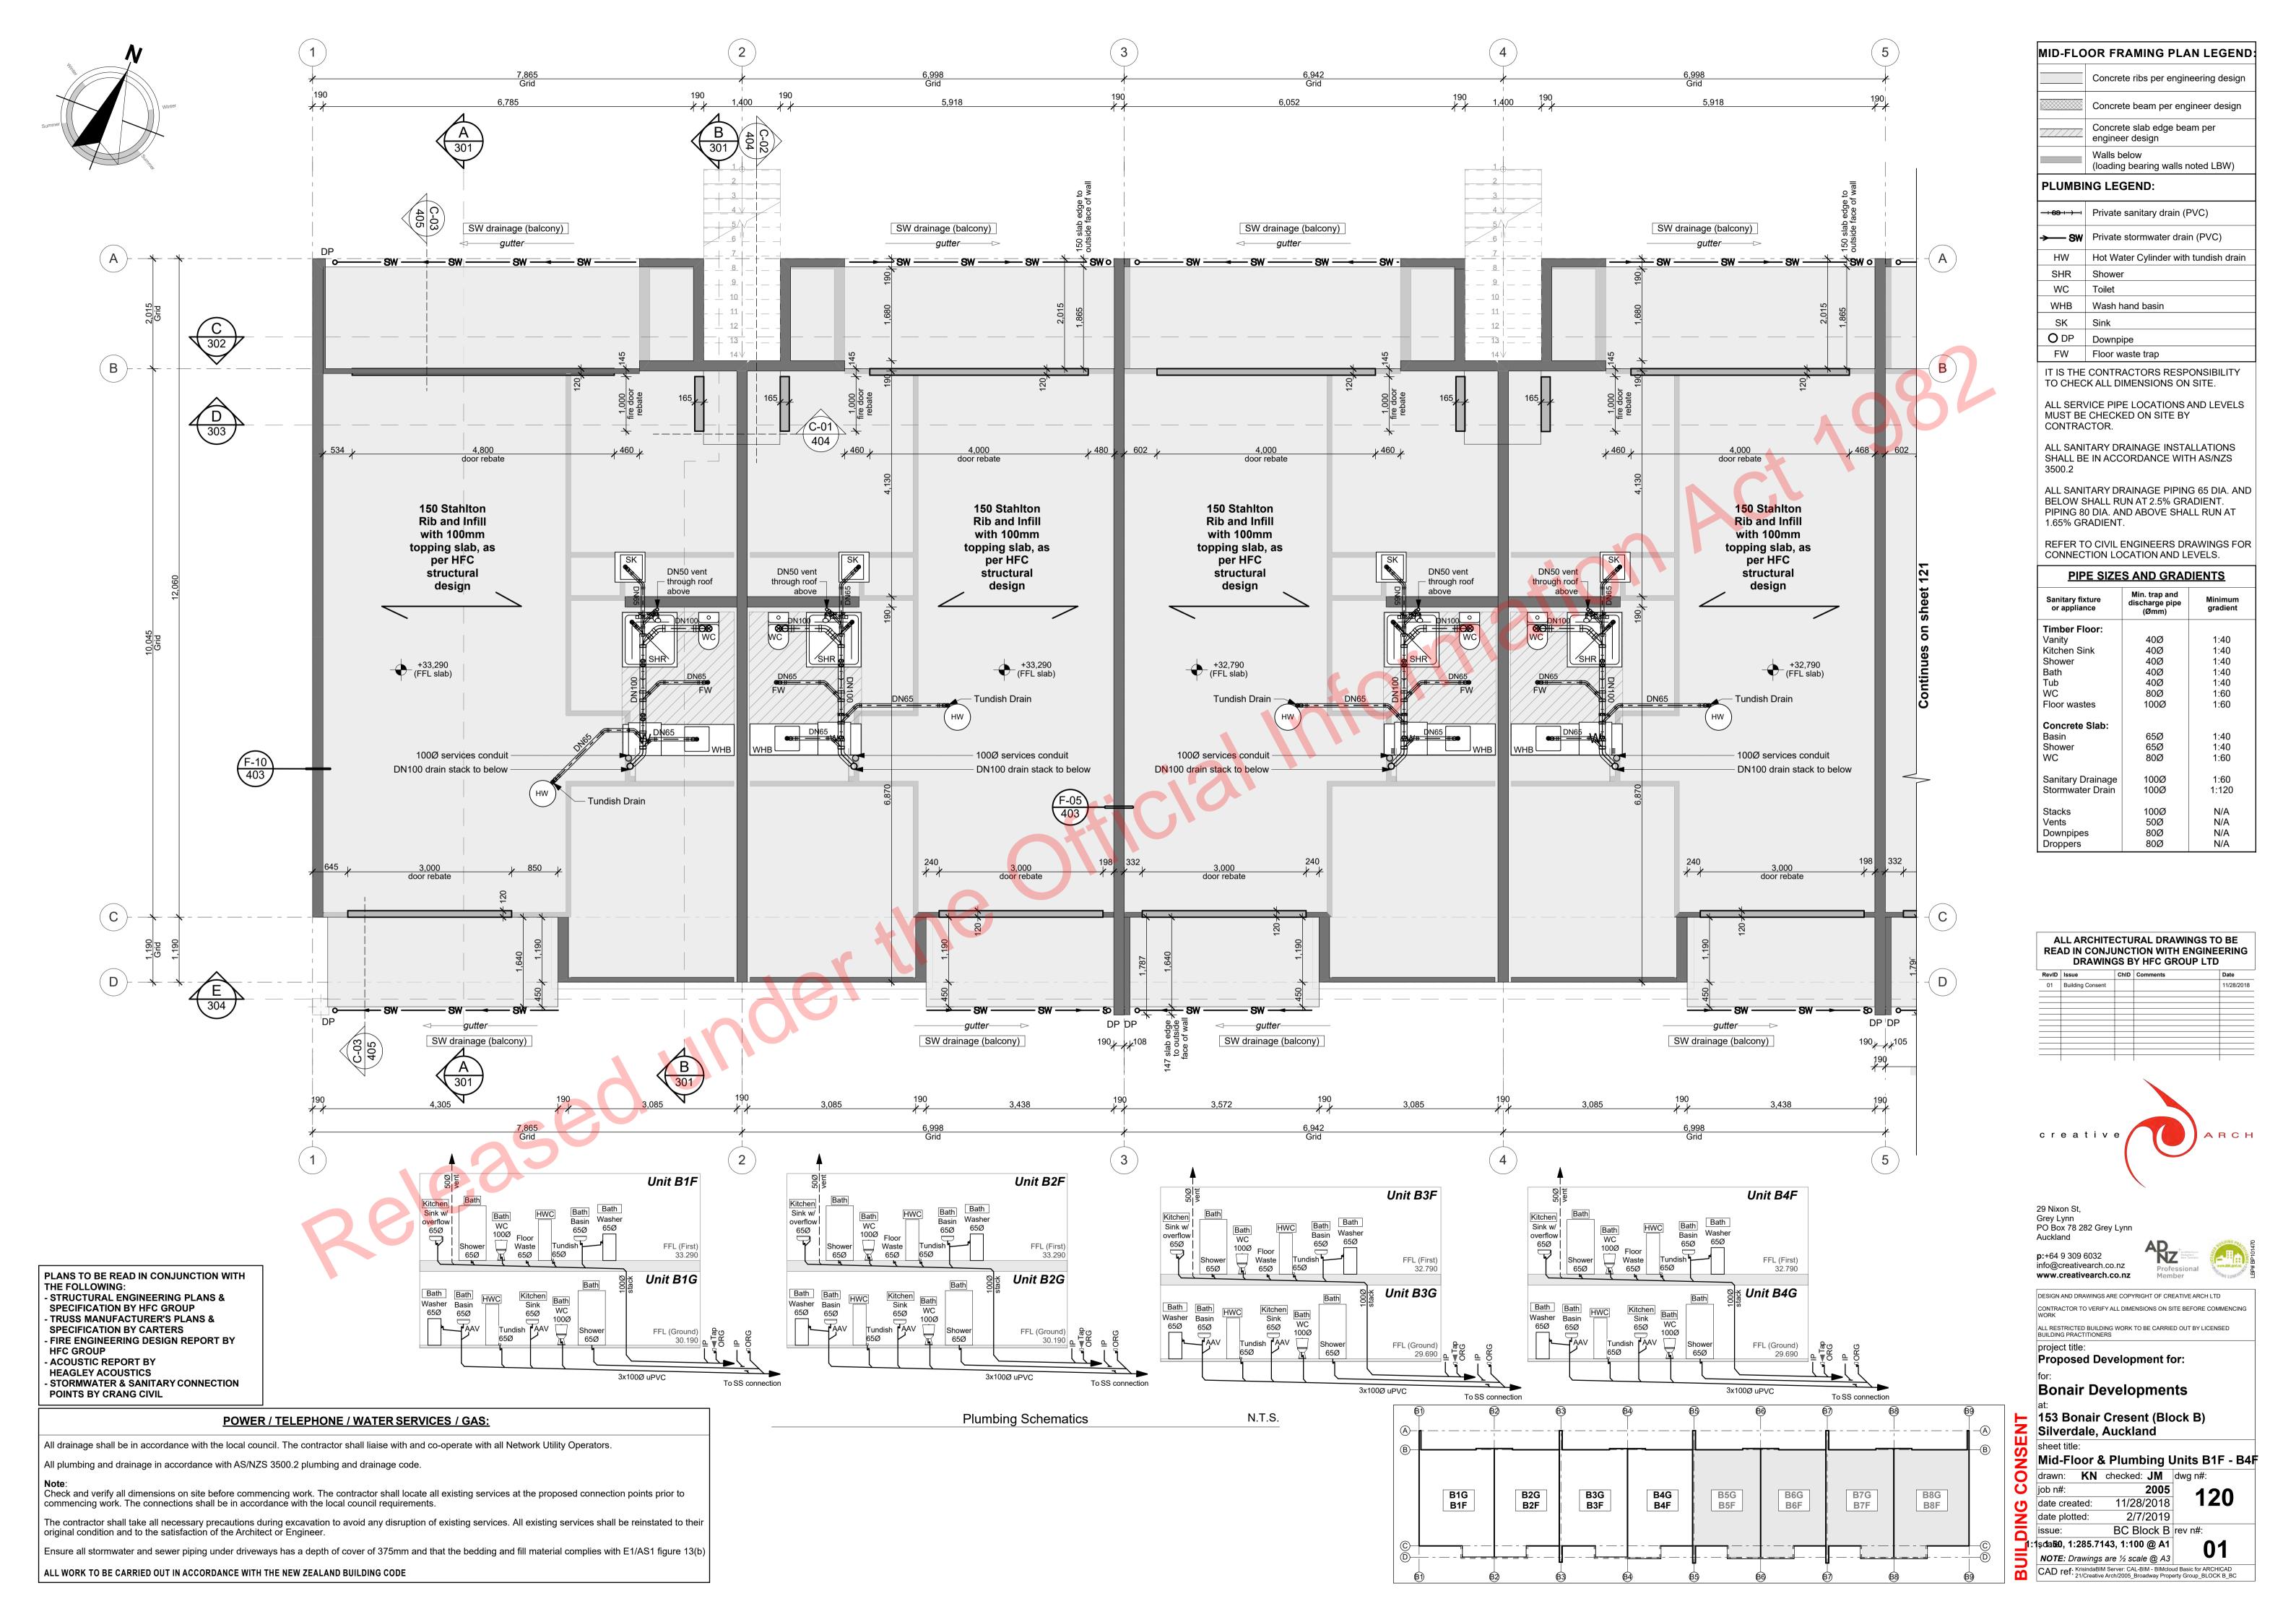


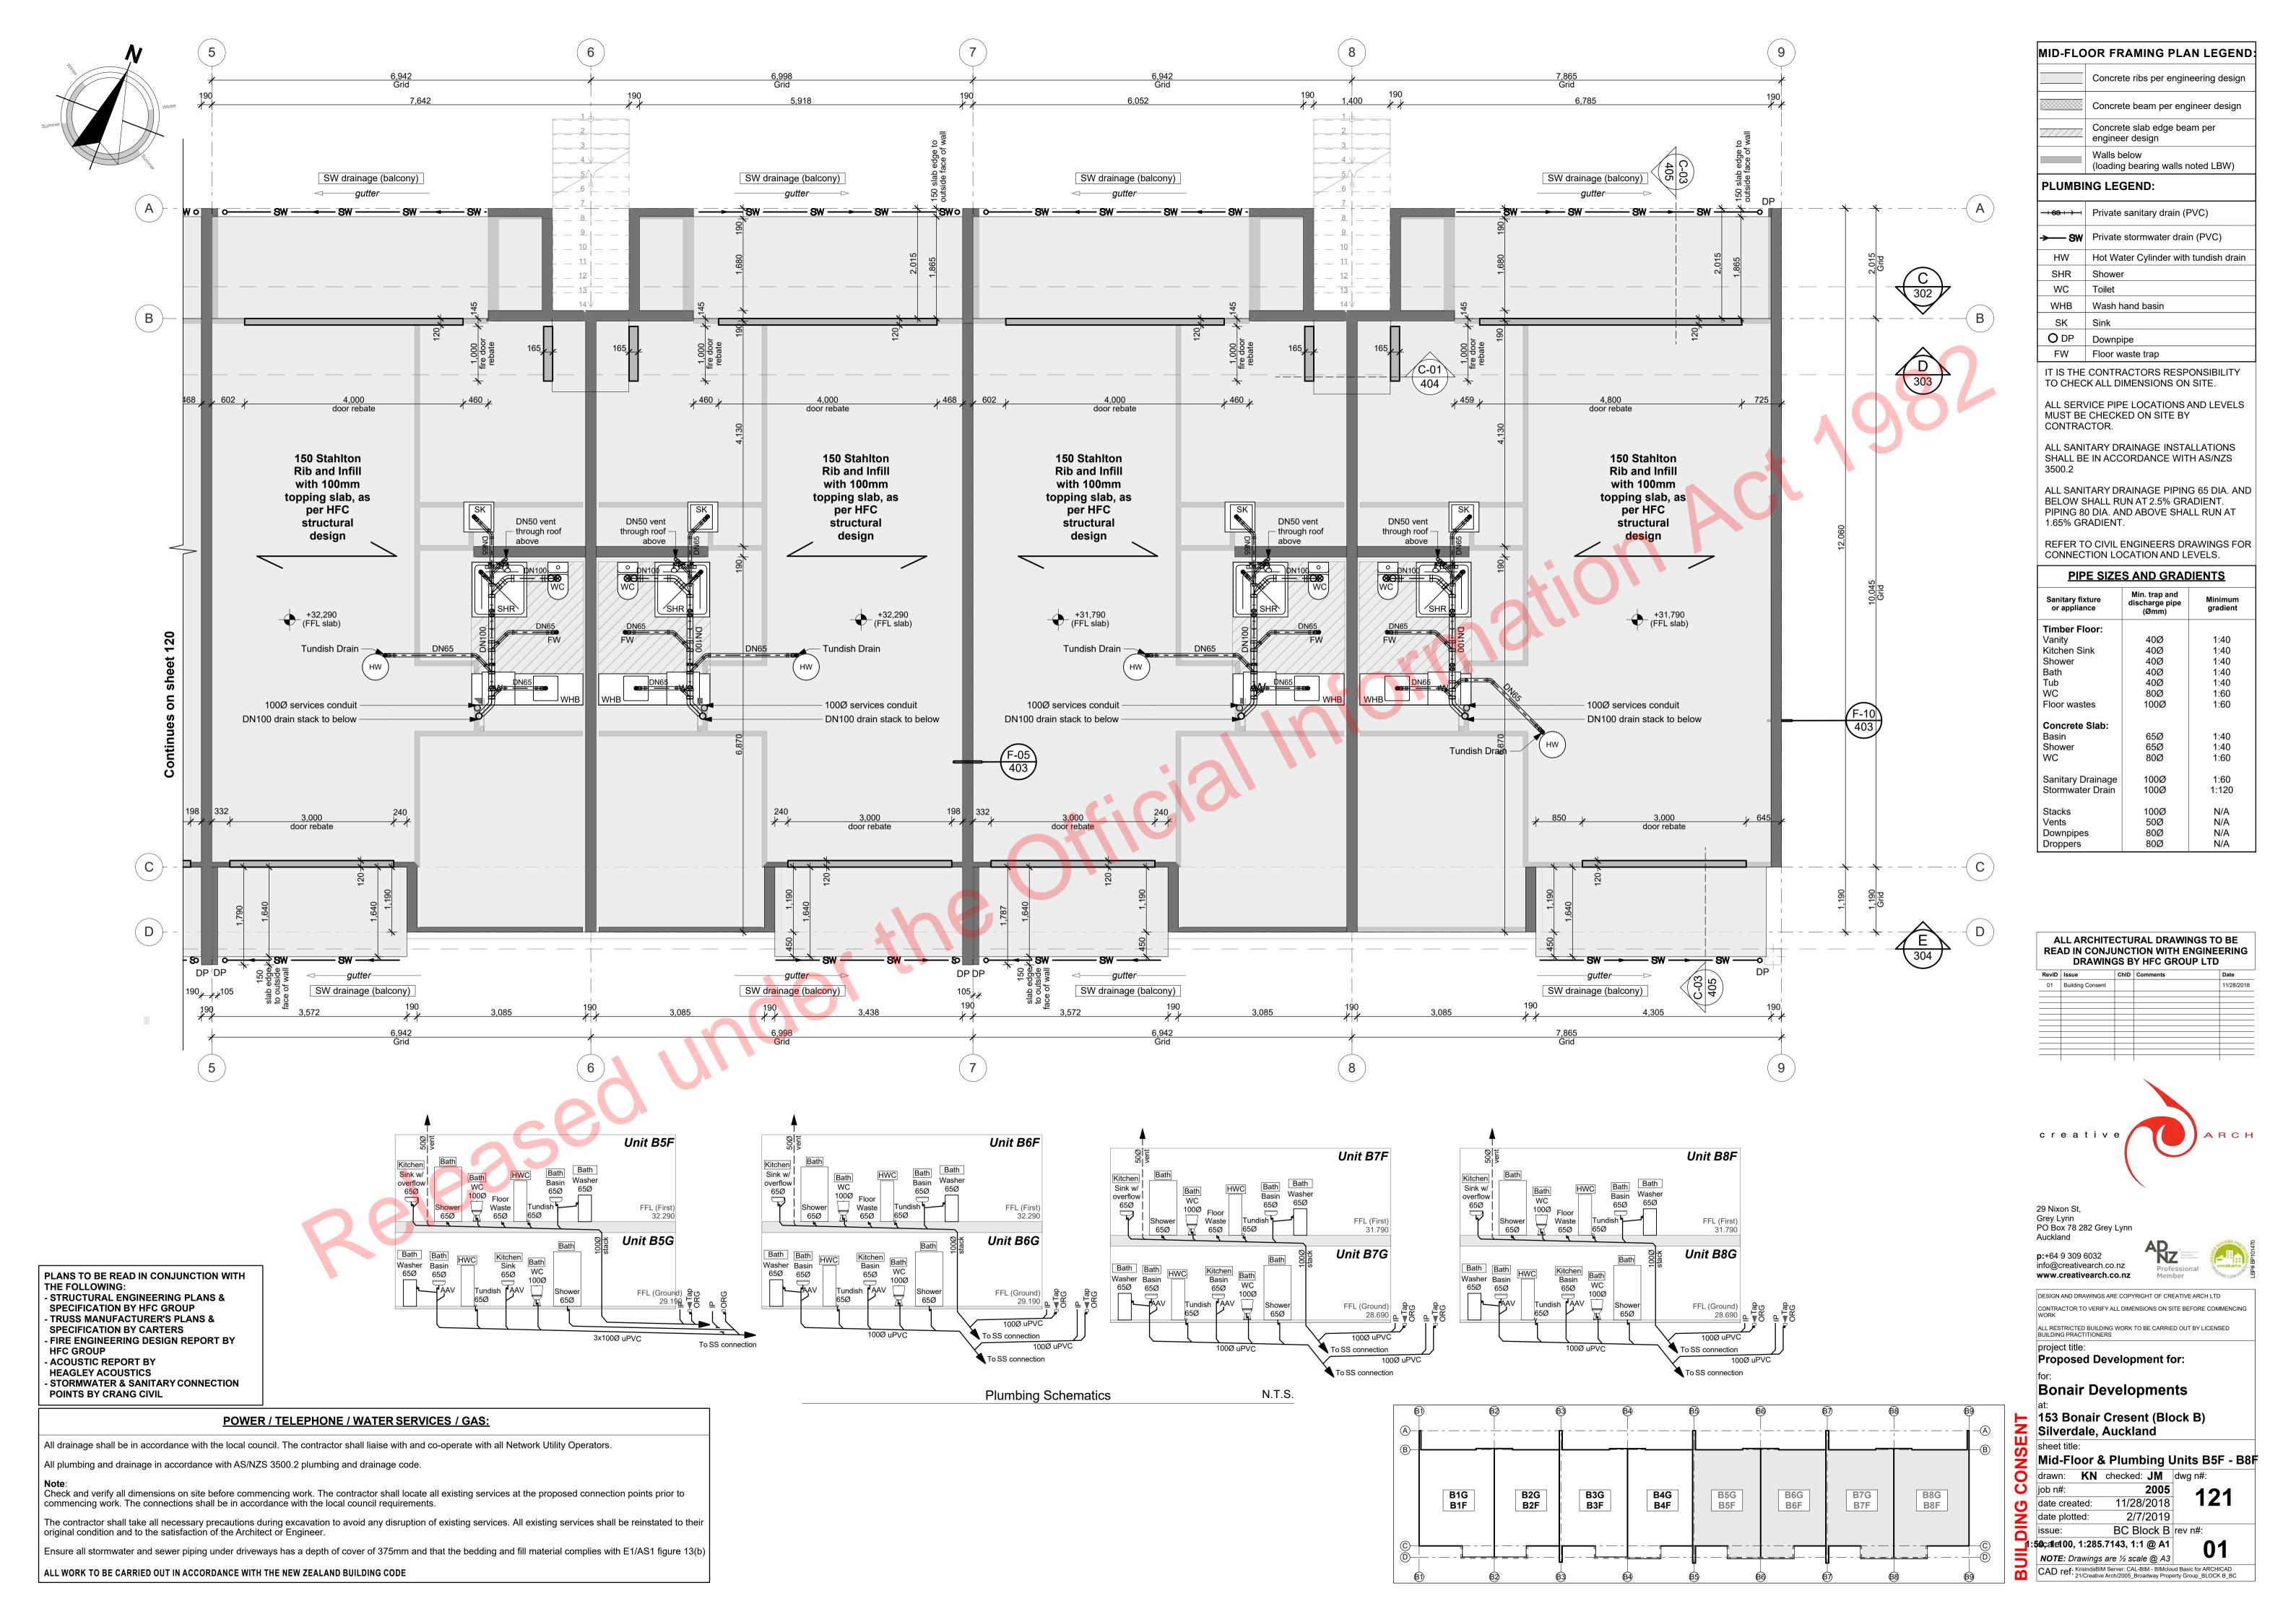


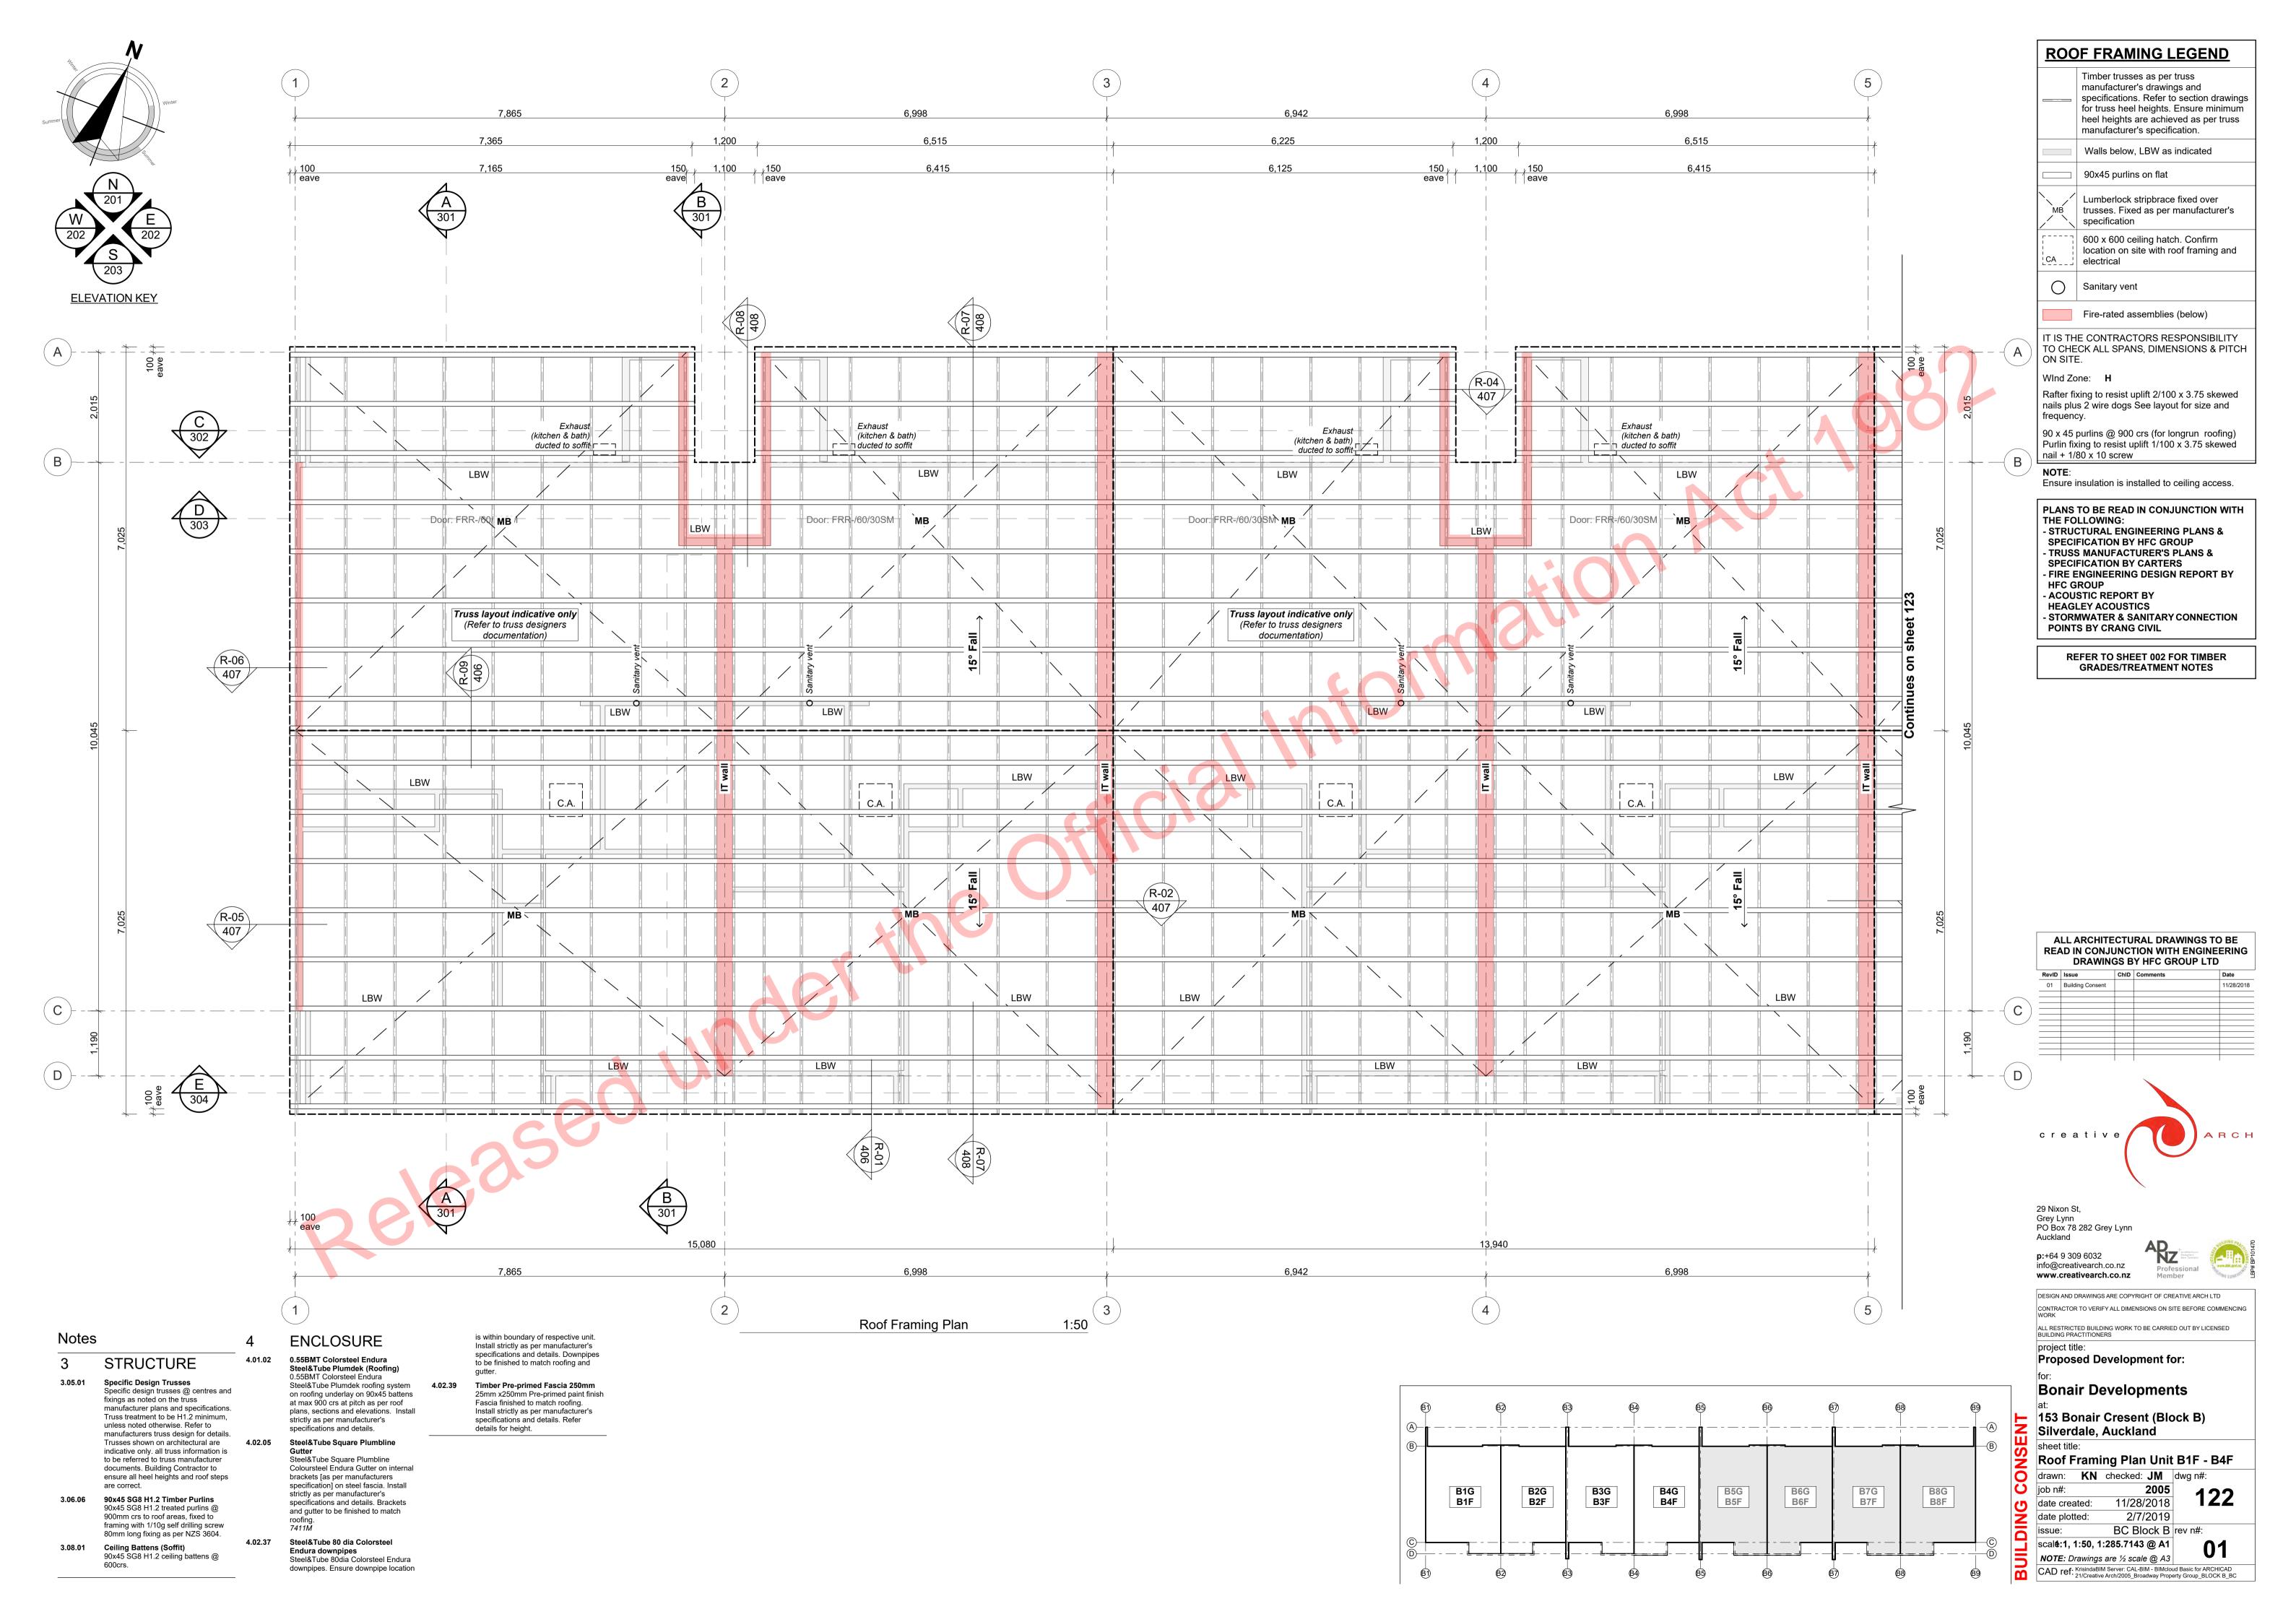

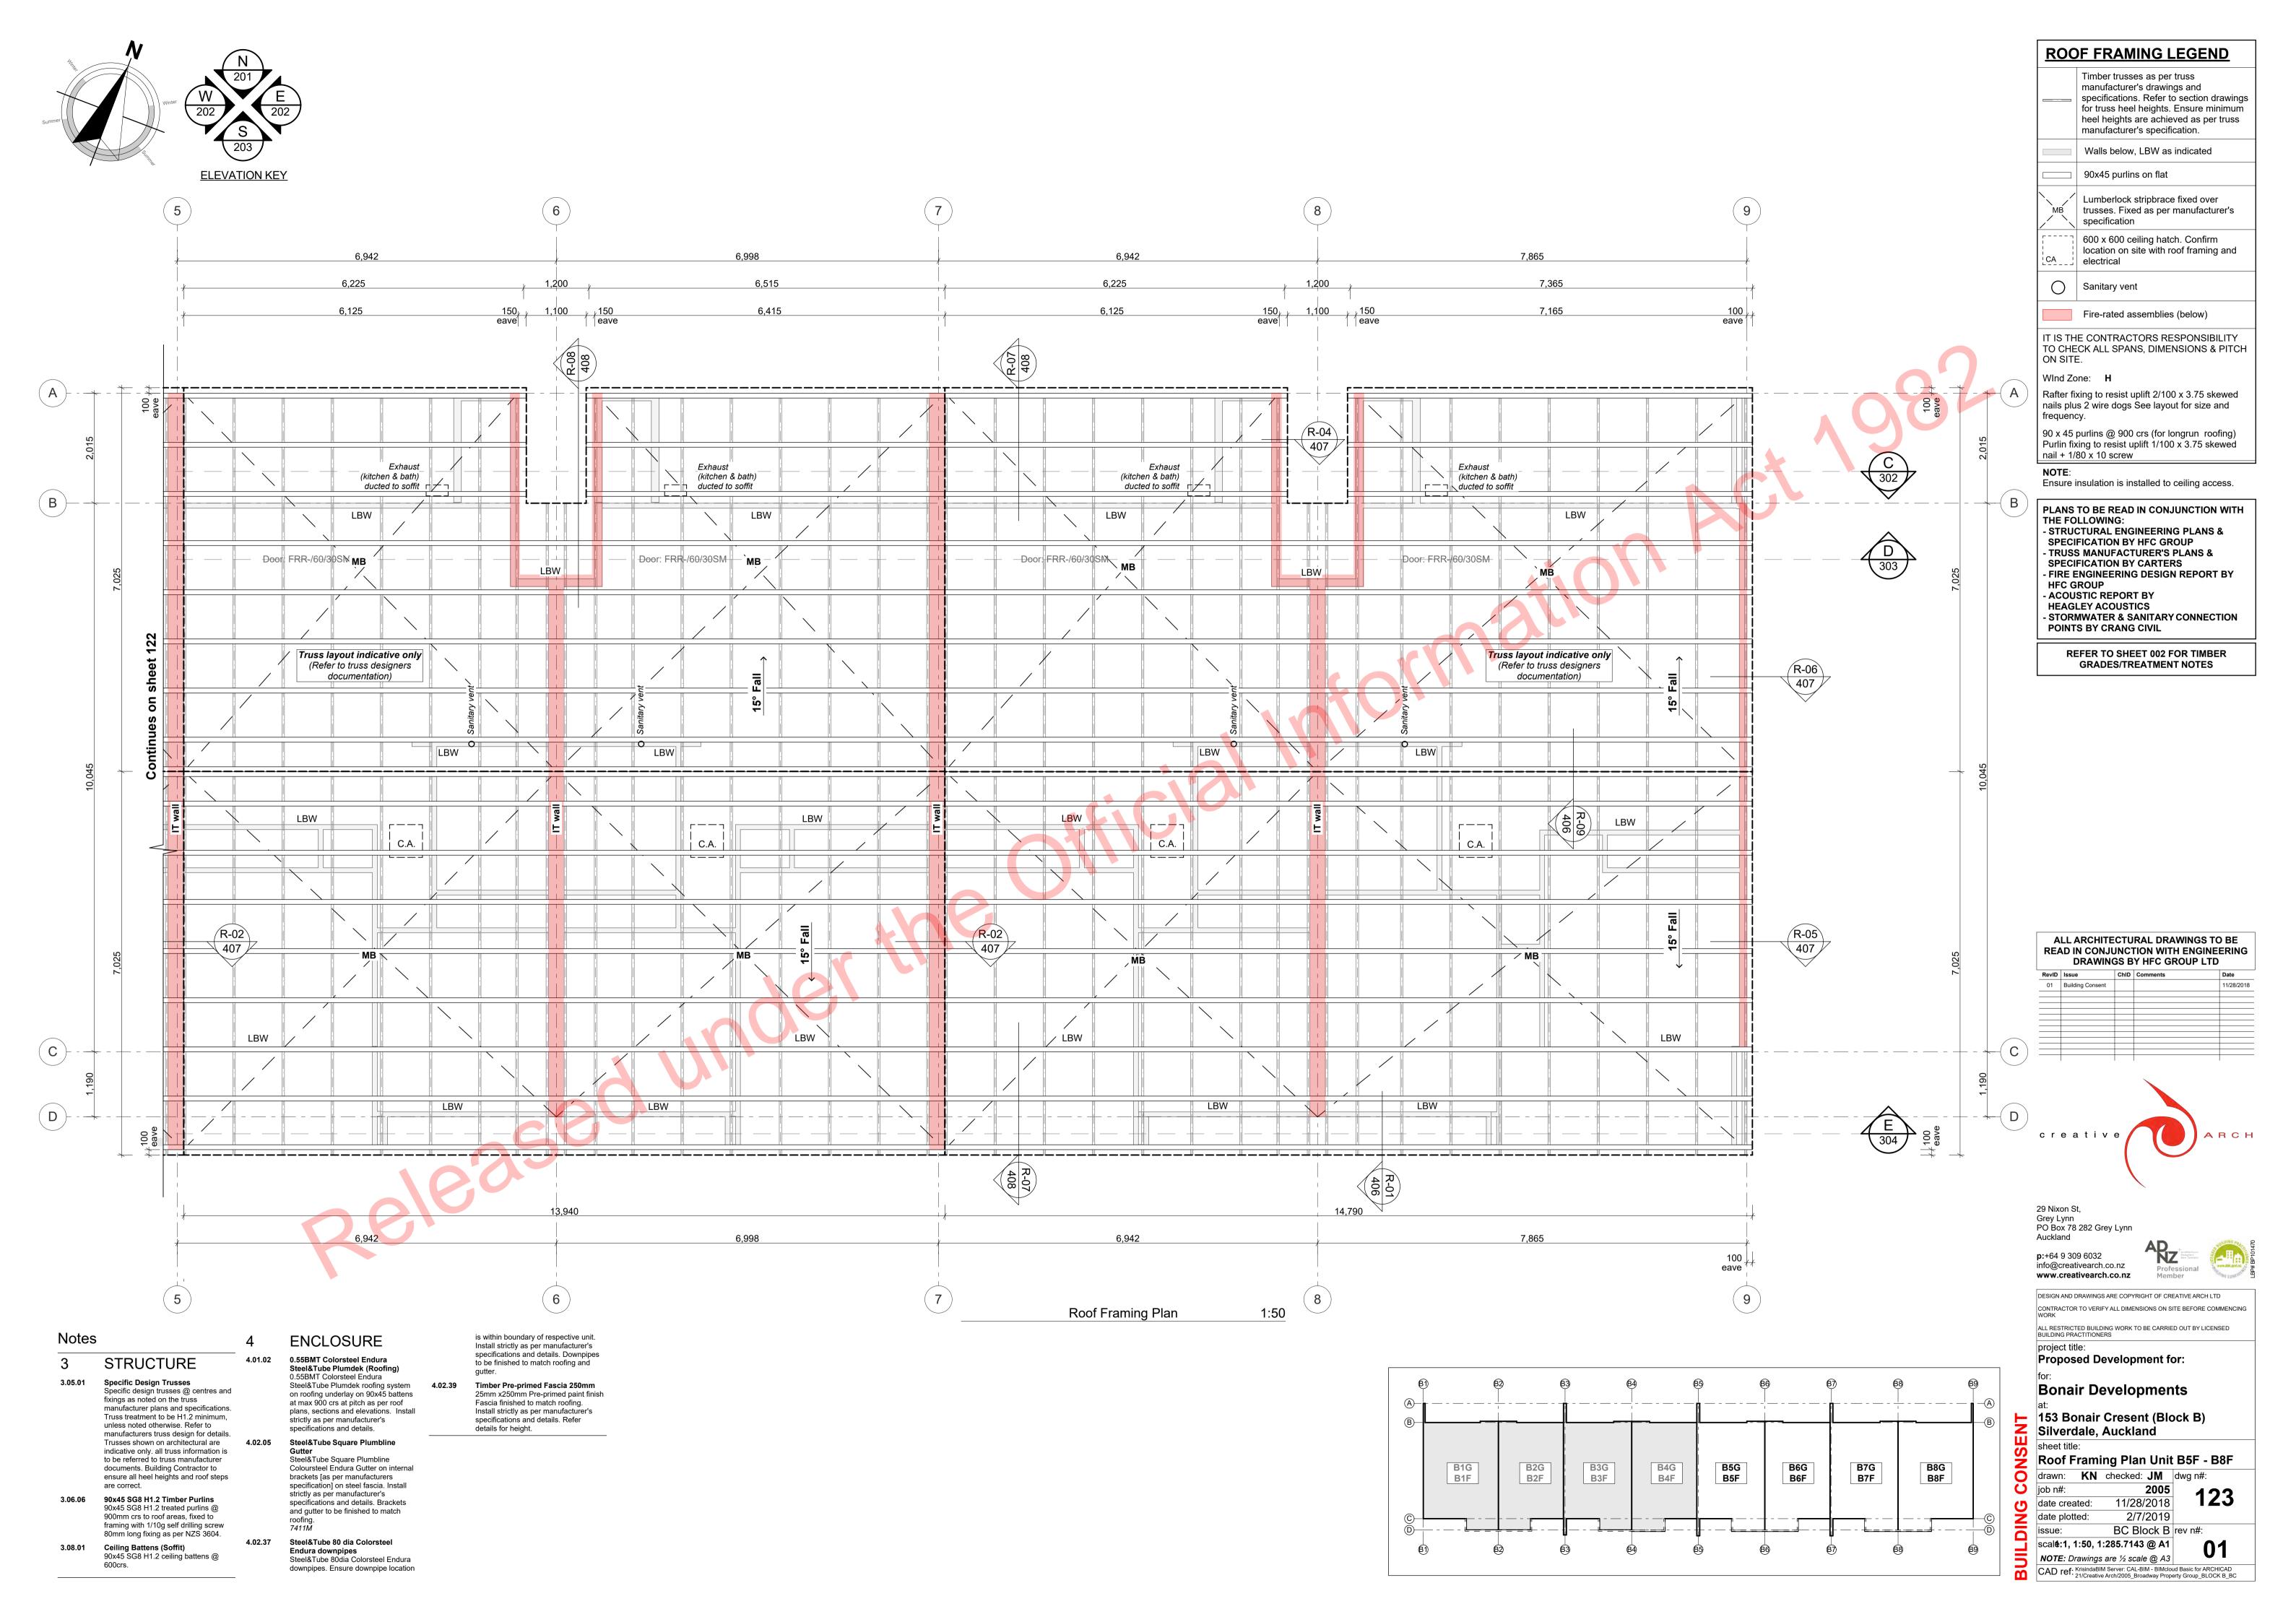

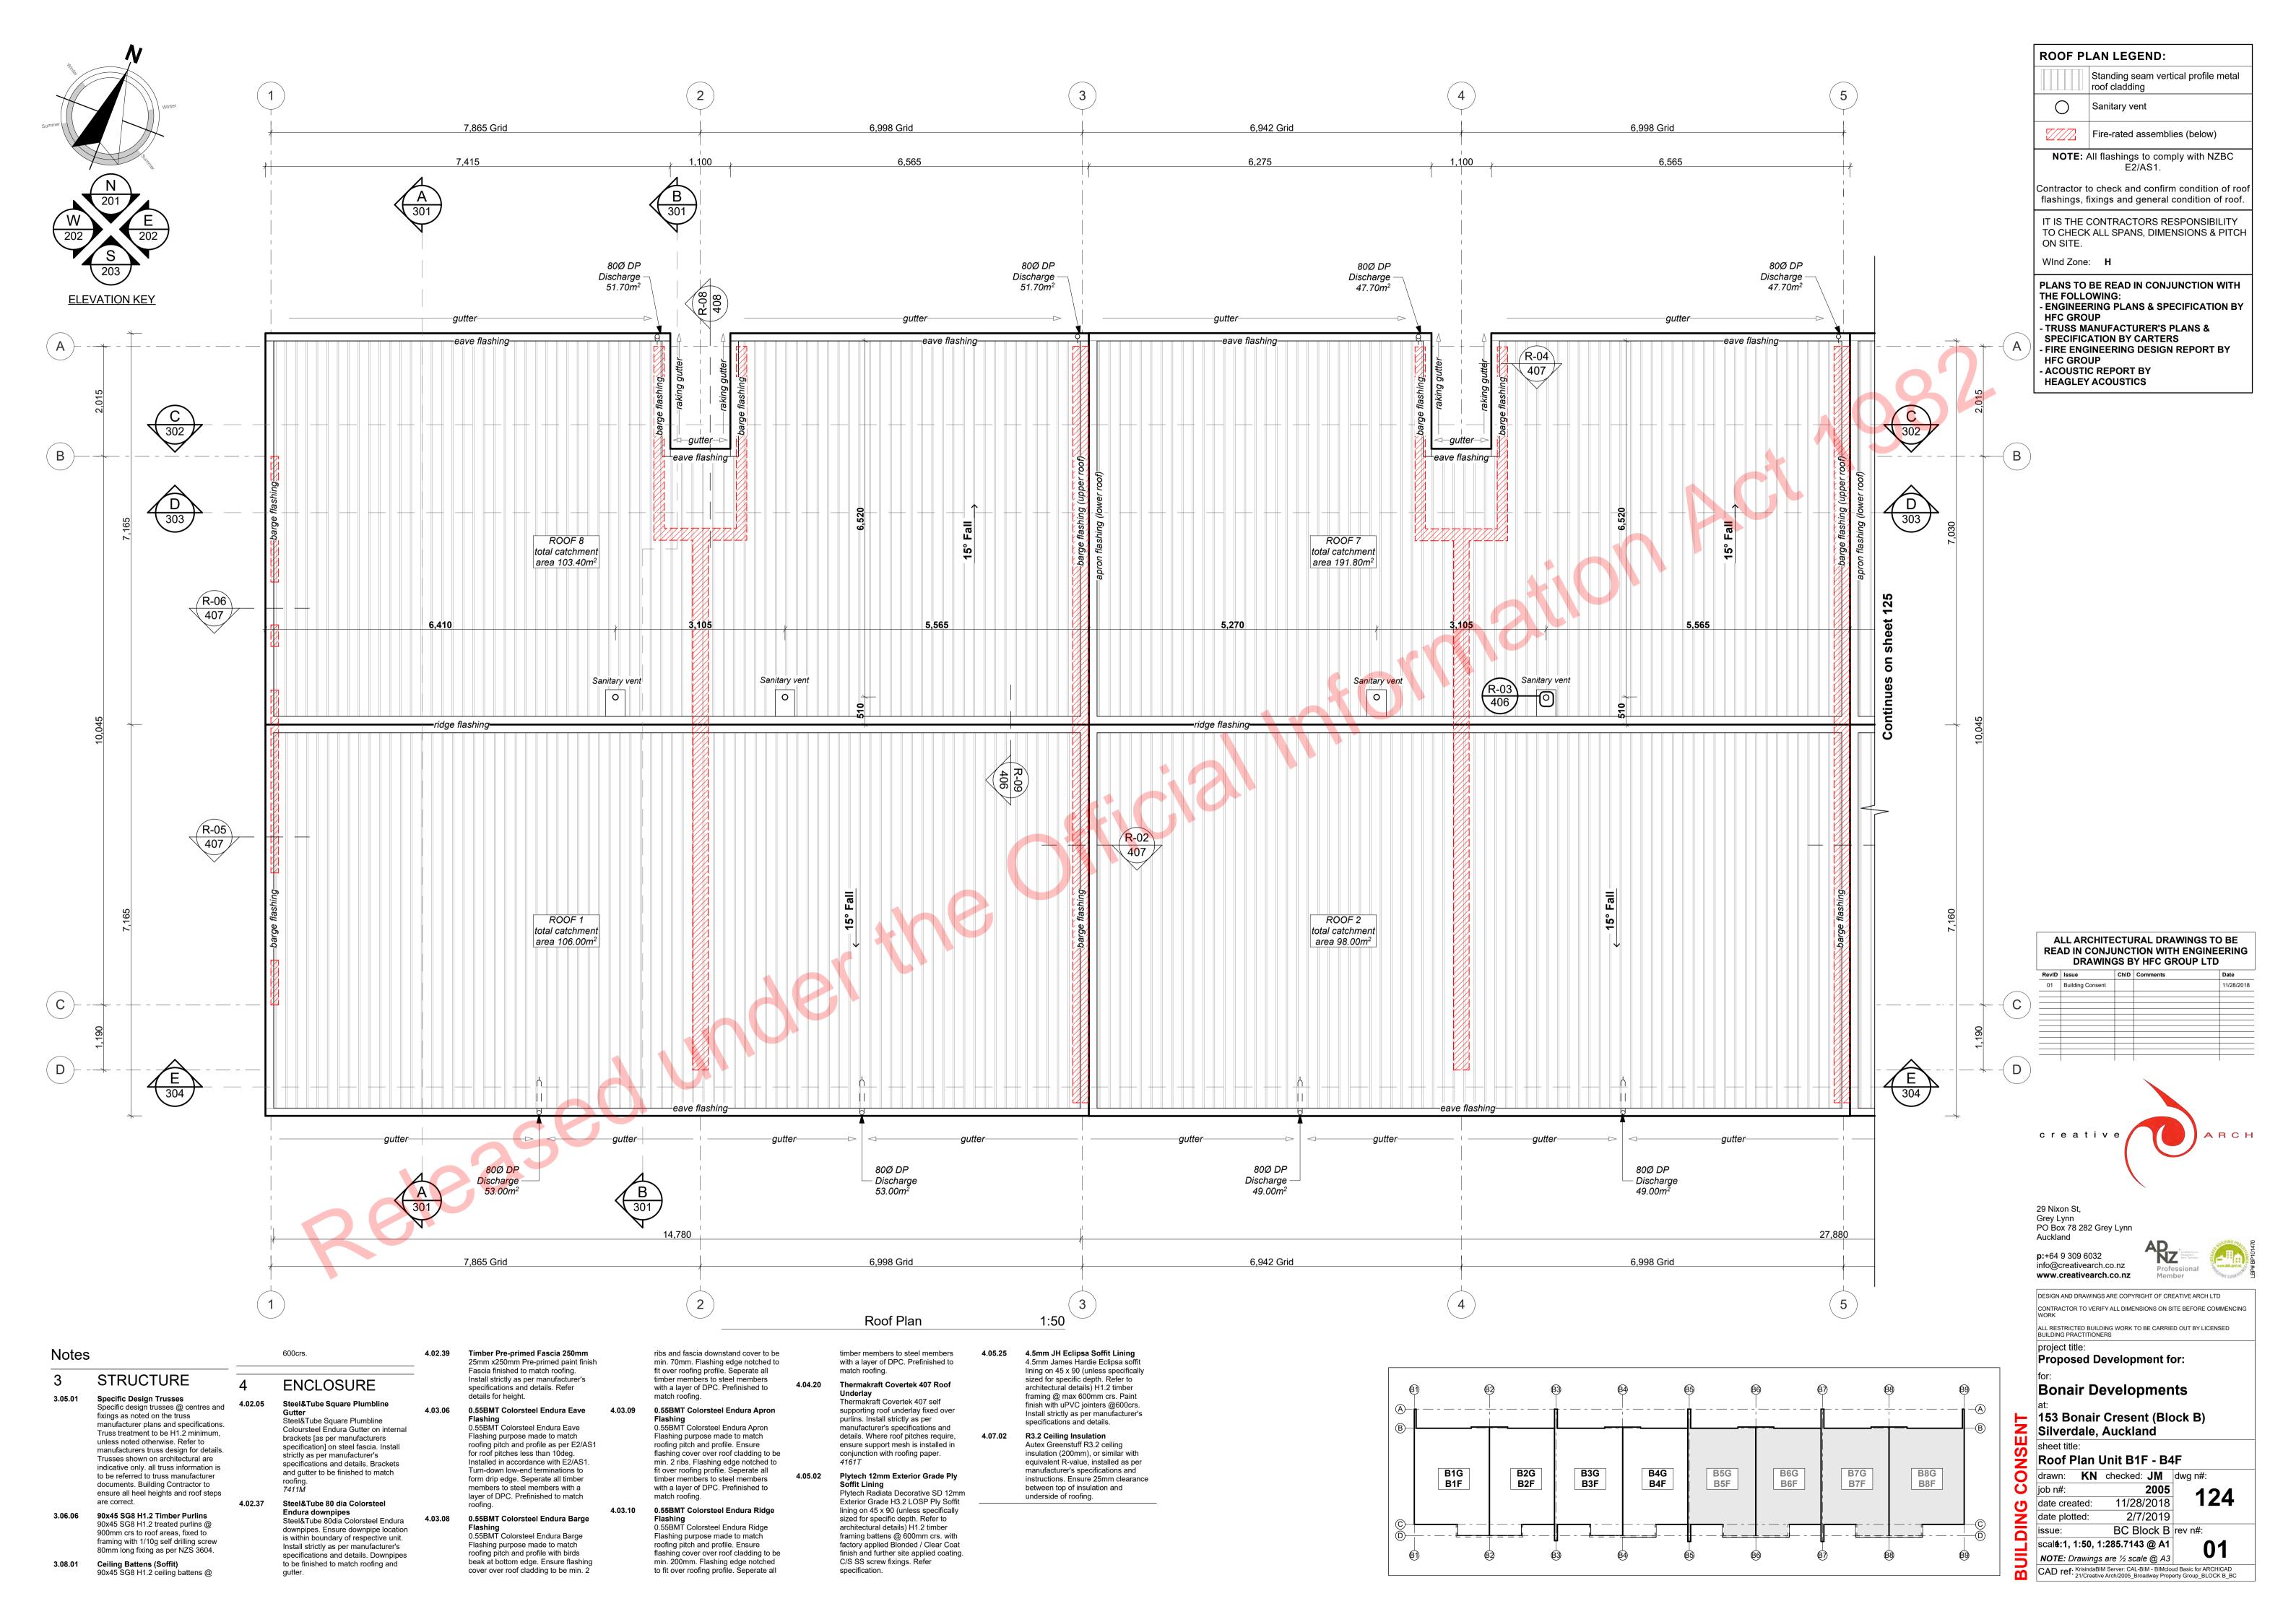

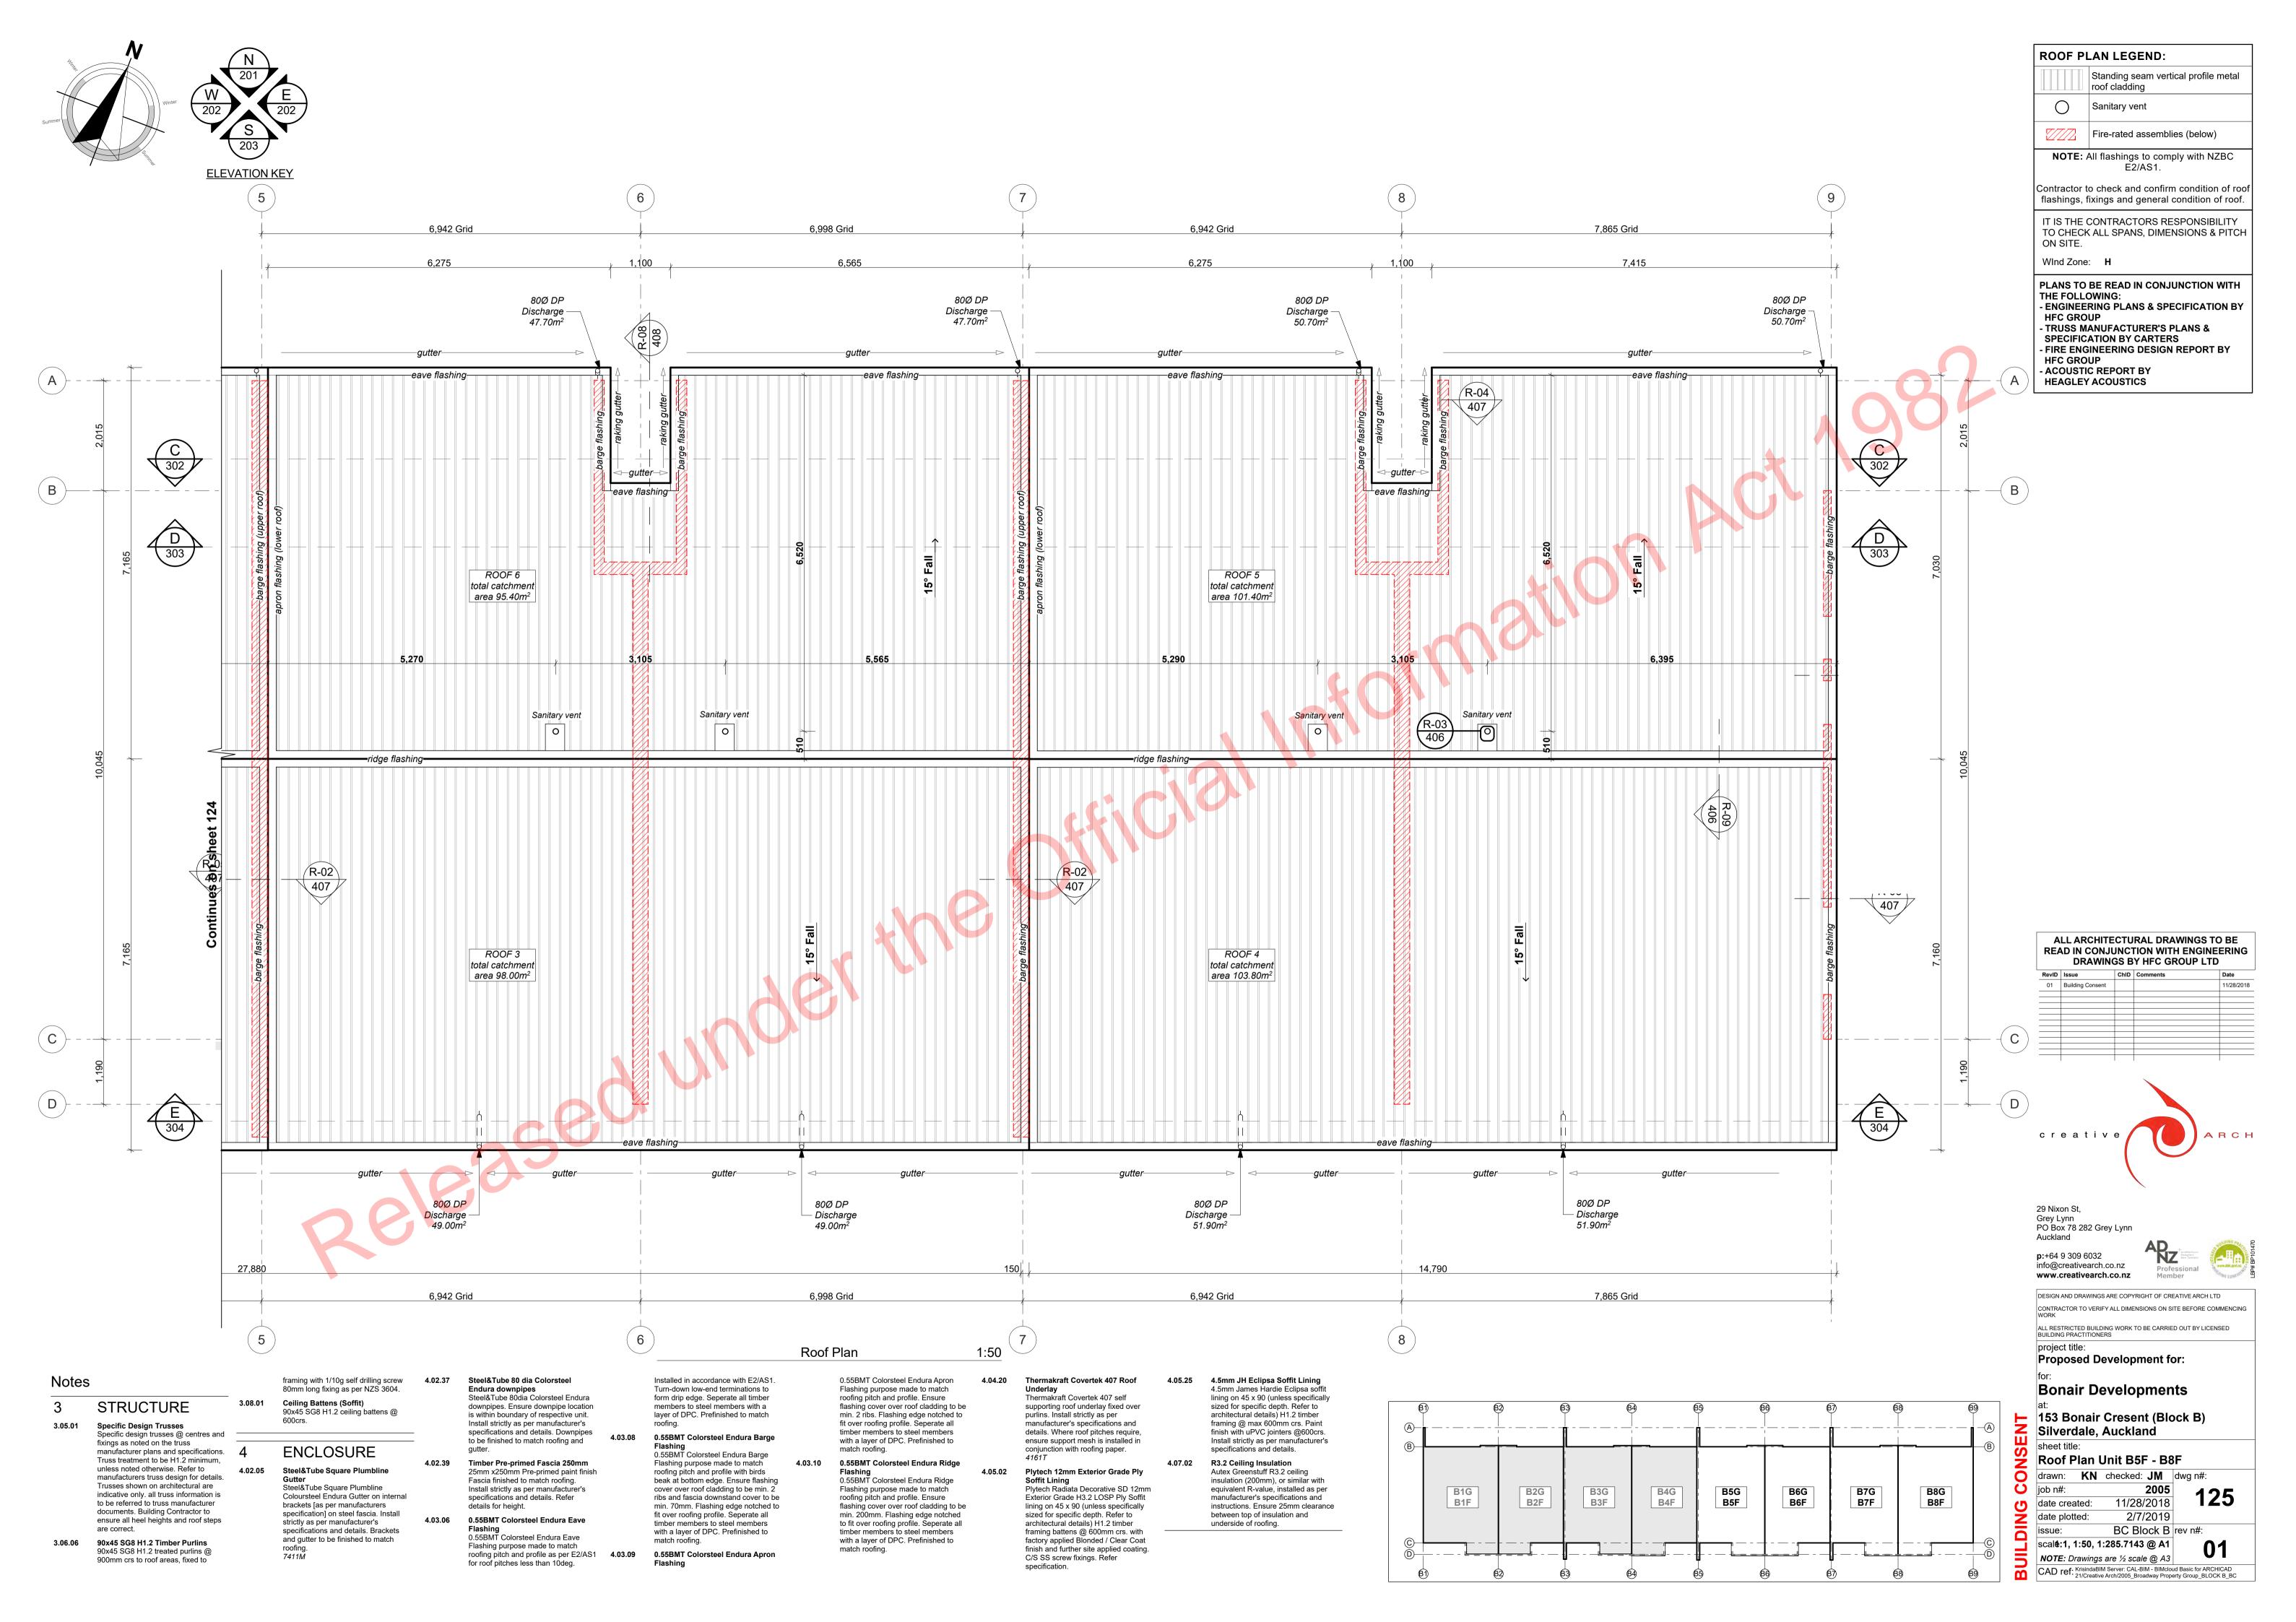

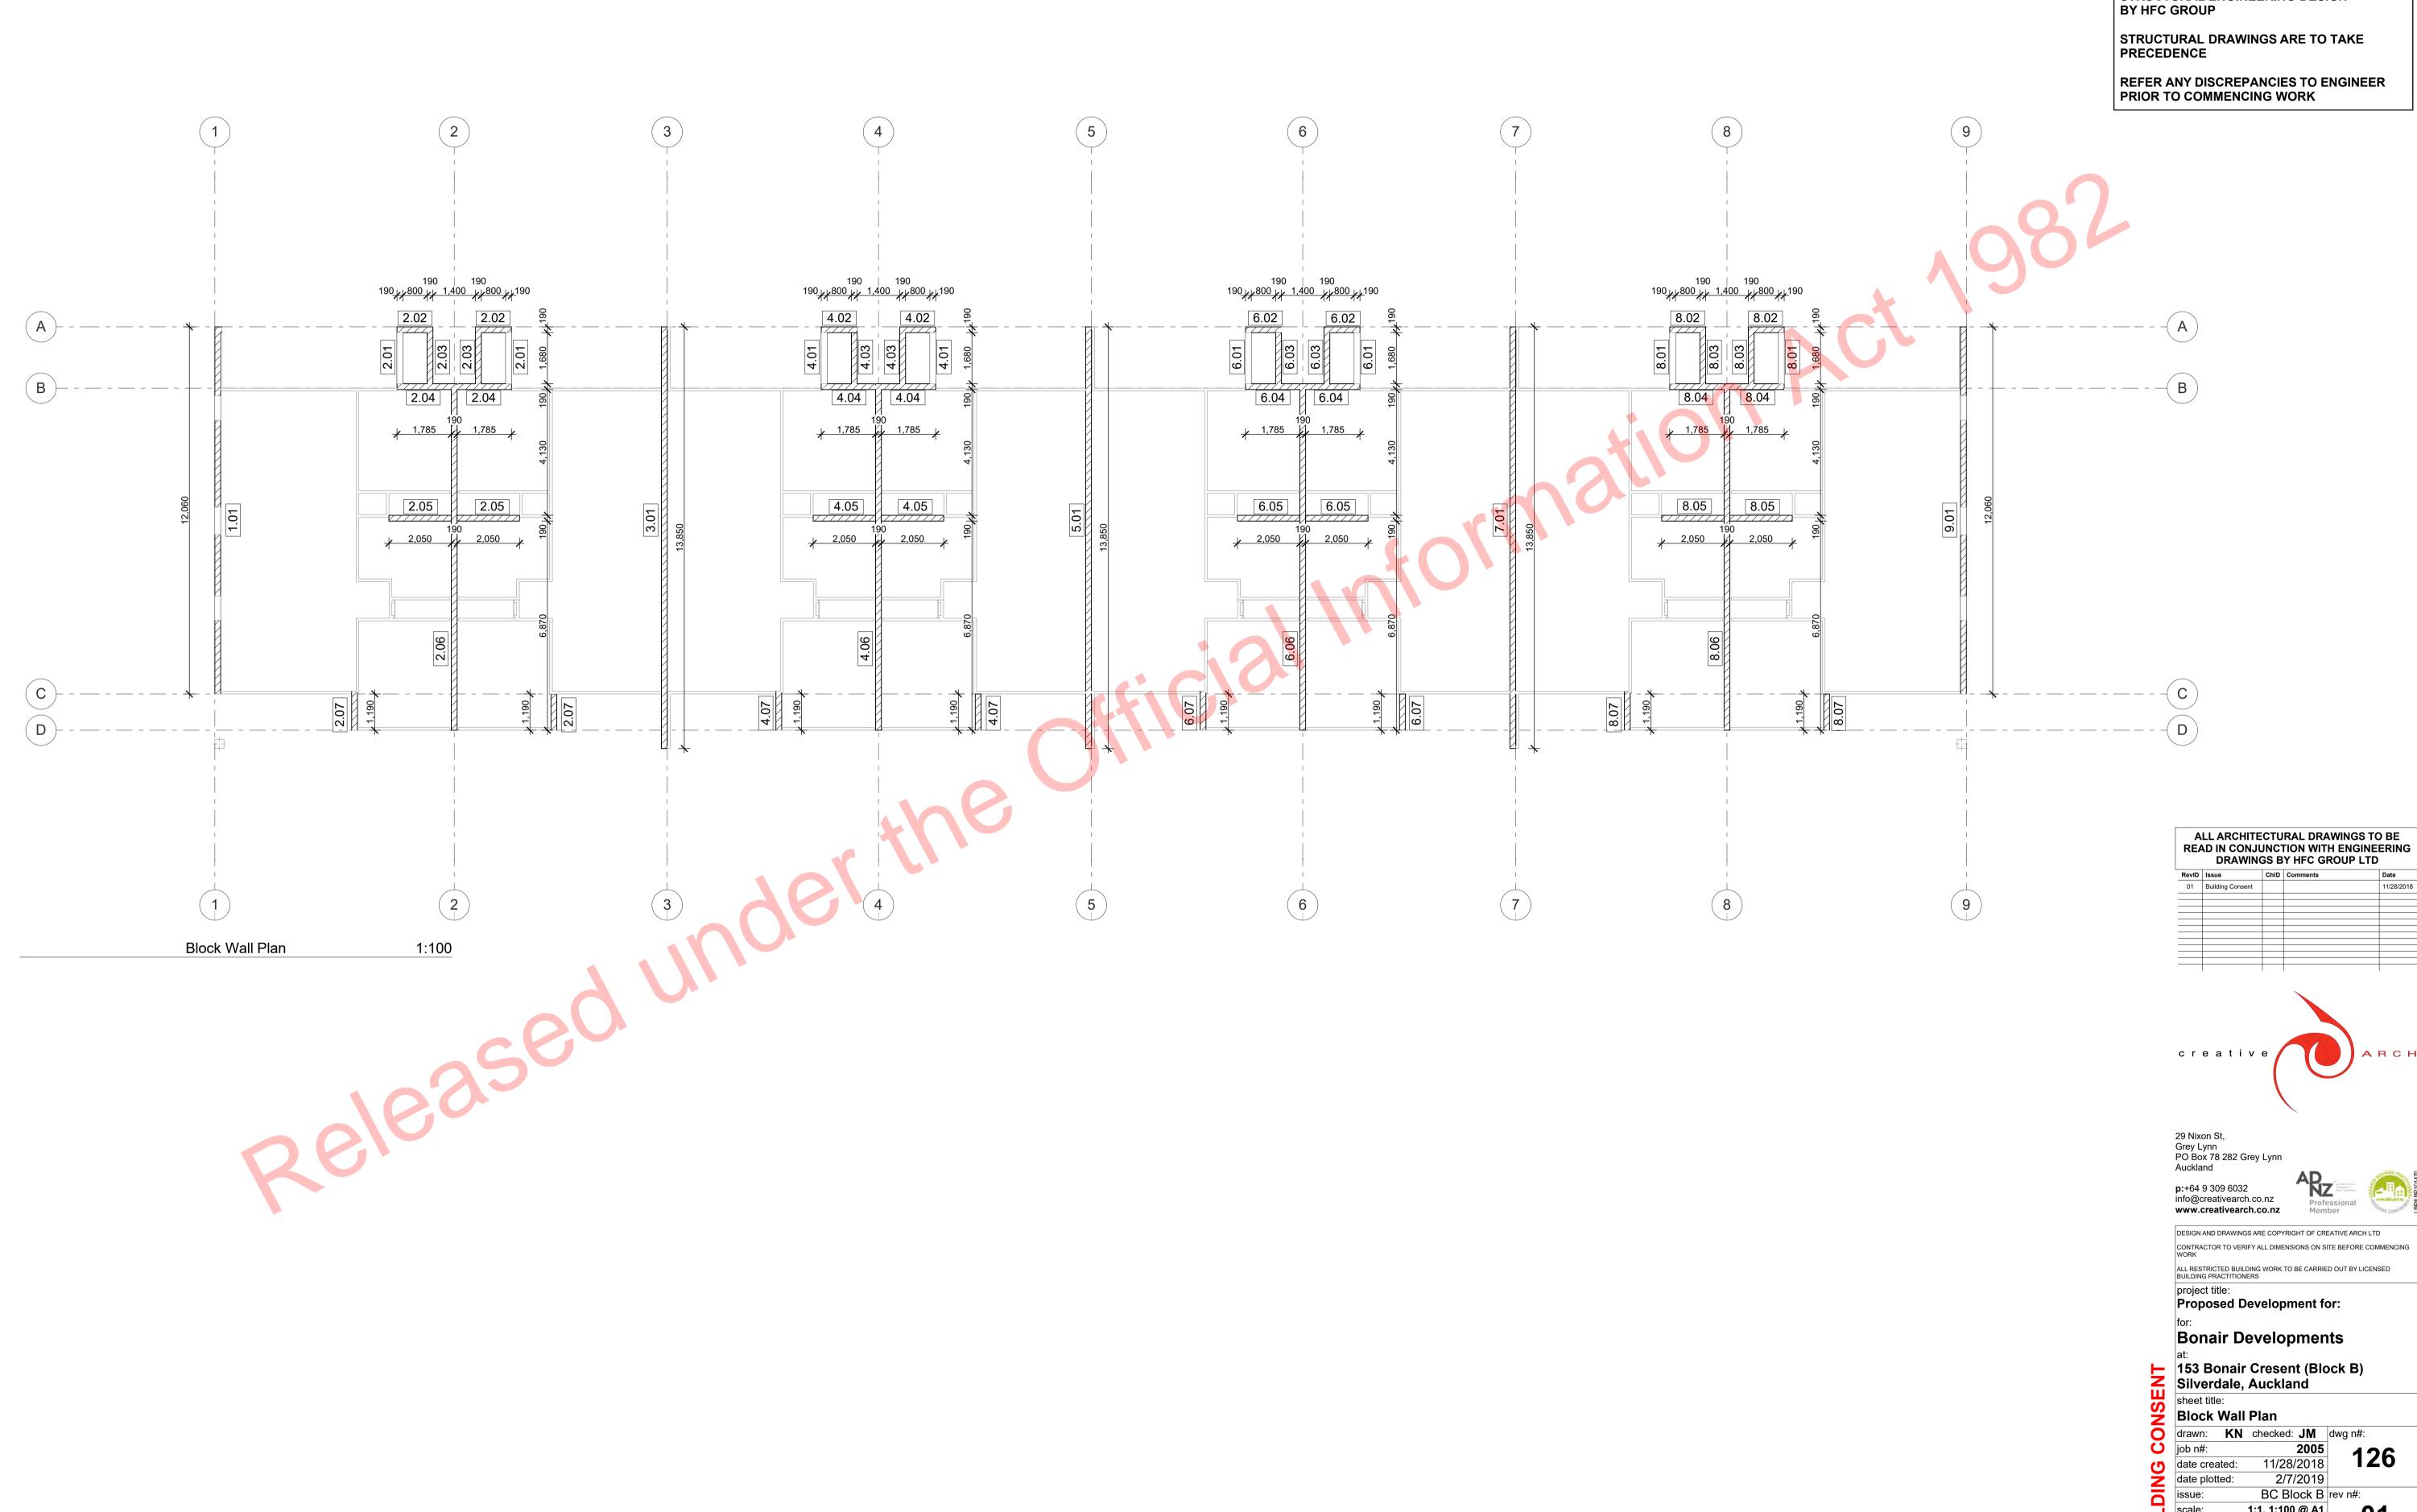


BLOCK WALL PLAN LEGEND: 90x45 internal framed wall 190 concrete block wall with rendered exterior finish Wall identification label


IMPORTANT:

PLANS TO BE READ IN CONJUNCTION WITH STRUCTURAL ENGINEERING DESIGN




1:1, 1:100 @ A1 scale: NOTE: Drawings are ½ scale @ A3 CAD ref: KrisindaBIM Server: CAL-BIM - BIMcloud Basic for ARCHICAD 21/Creative Arch/2005_Broadway Property Group_BLOCK B_BC

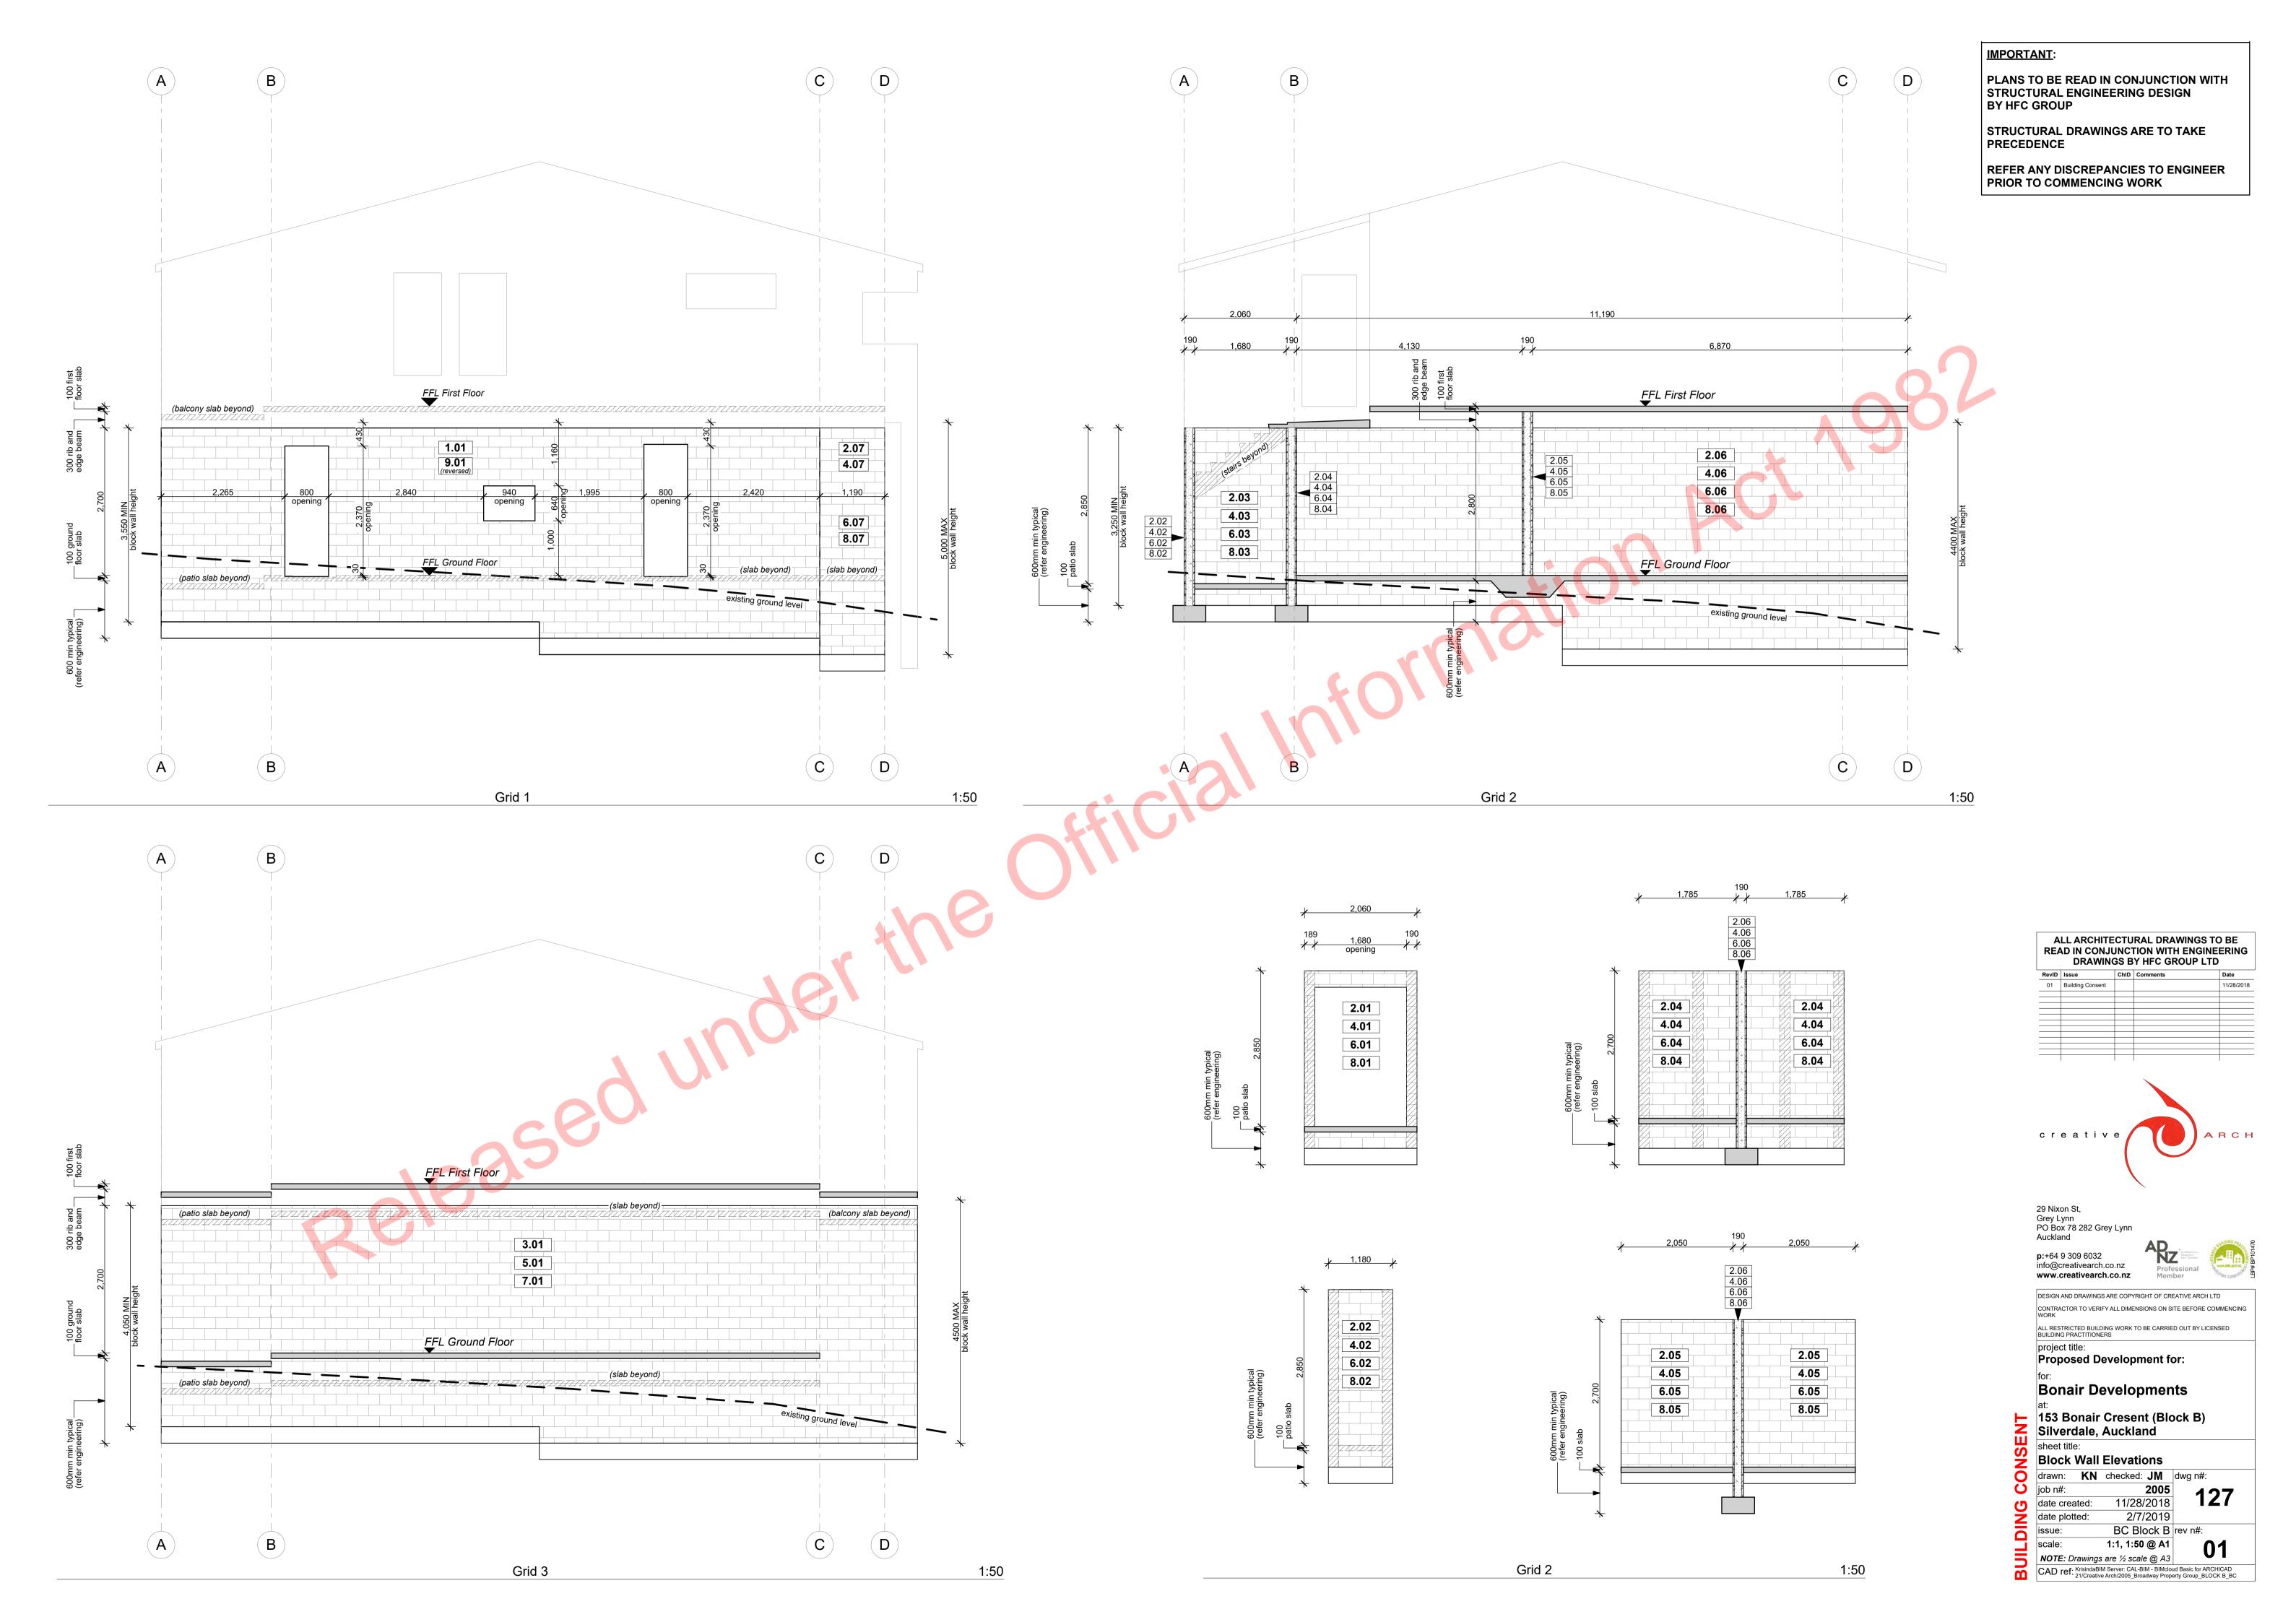

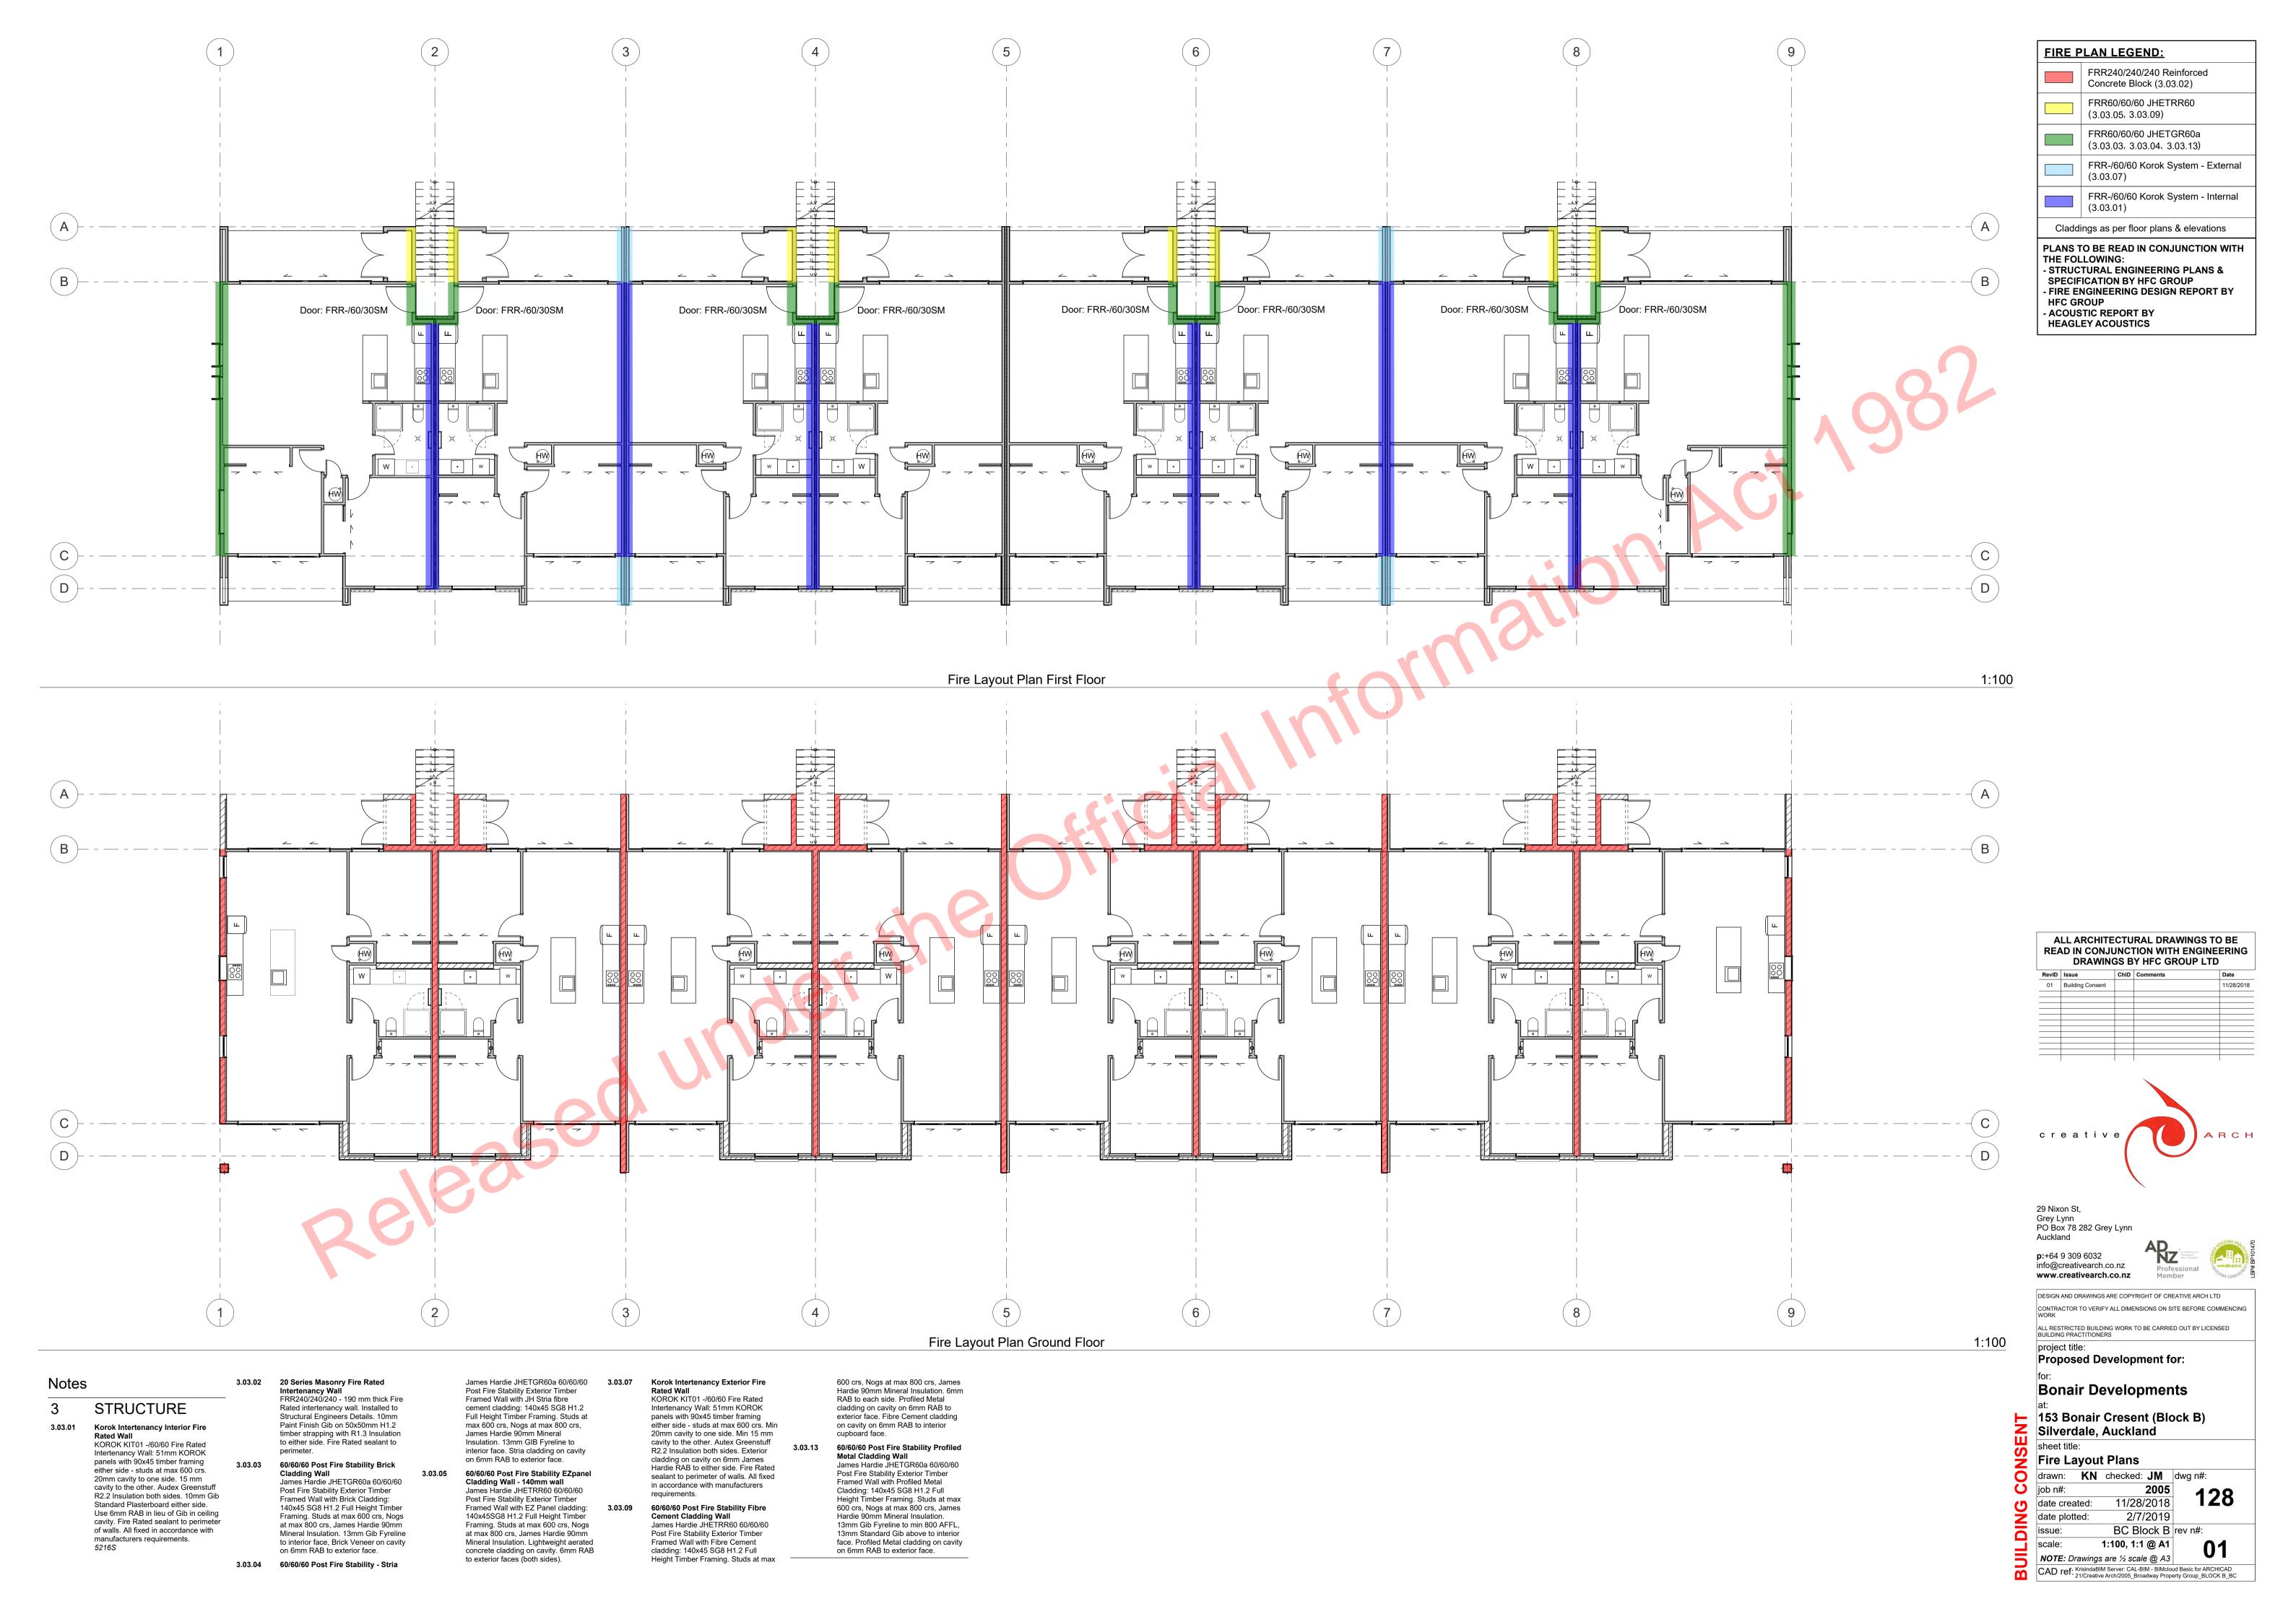



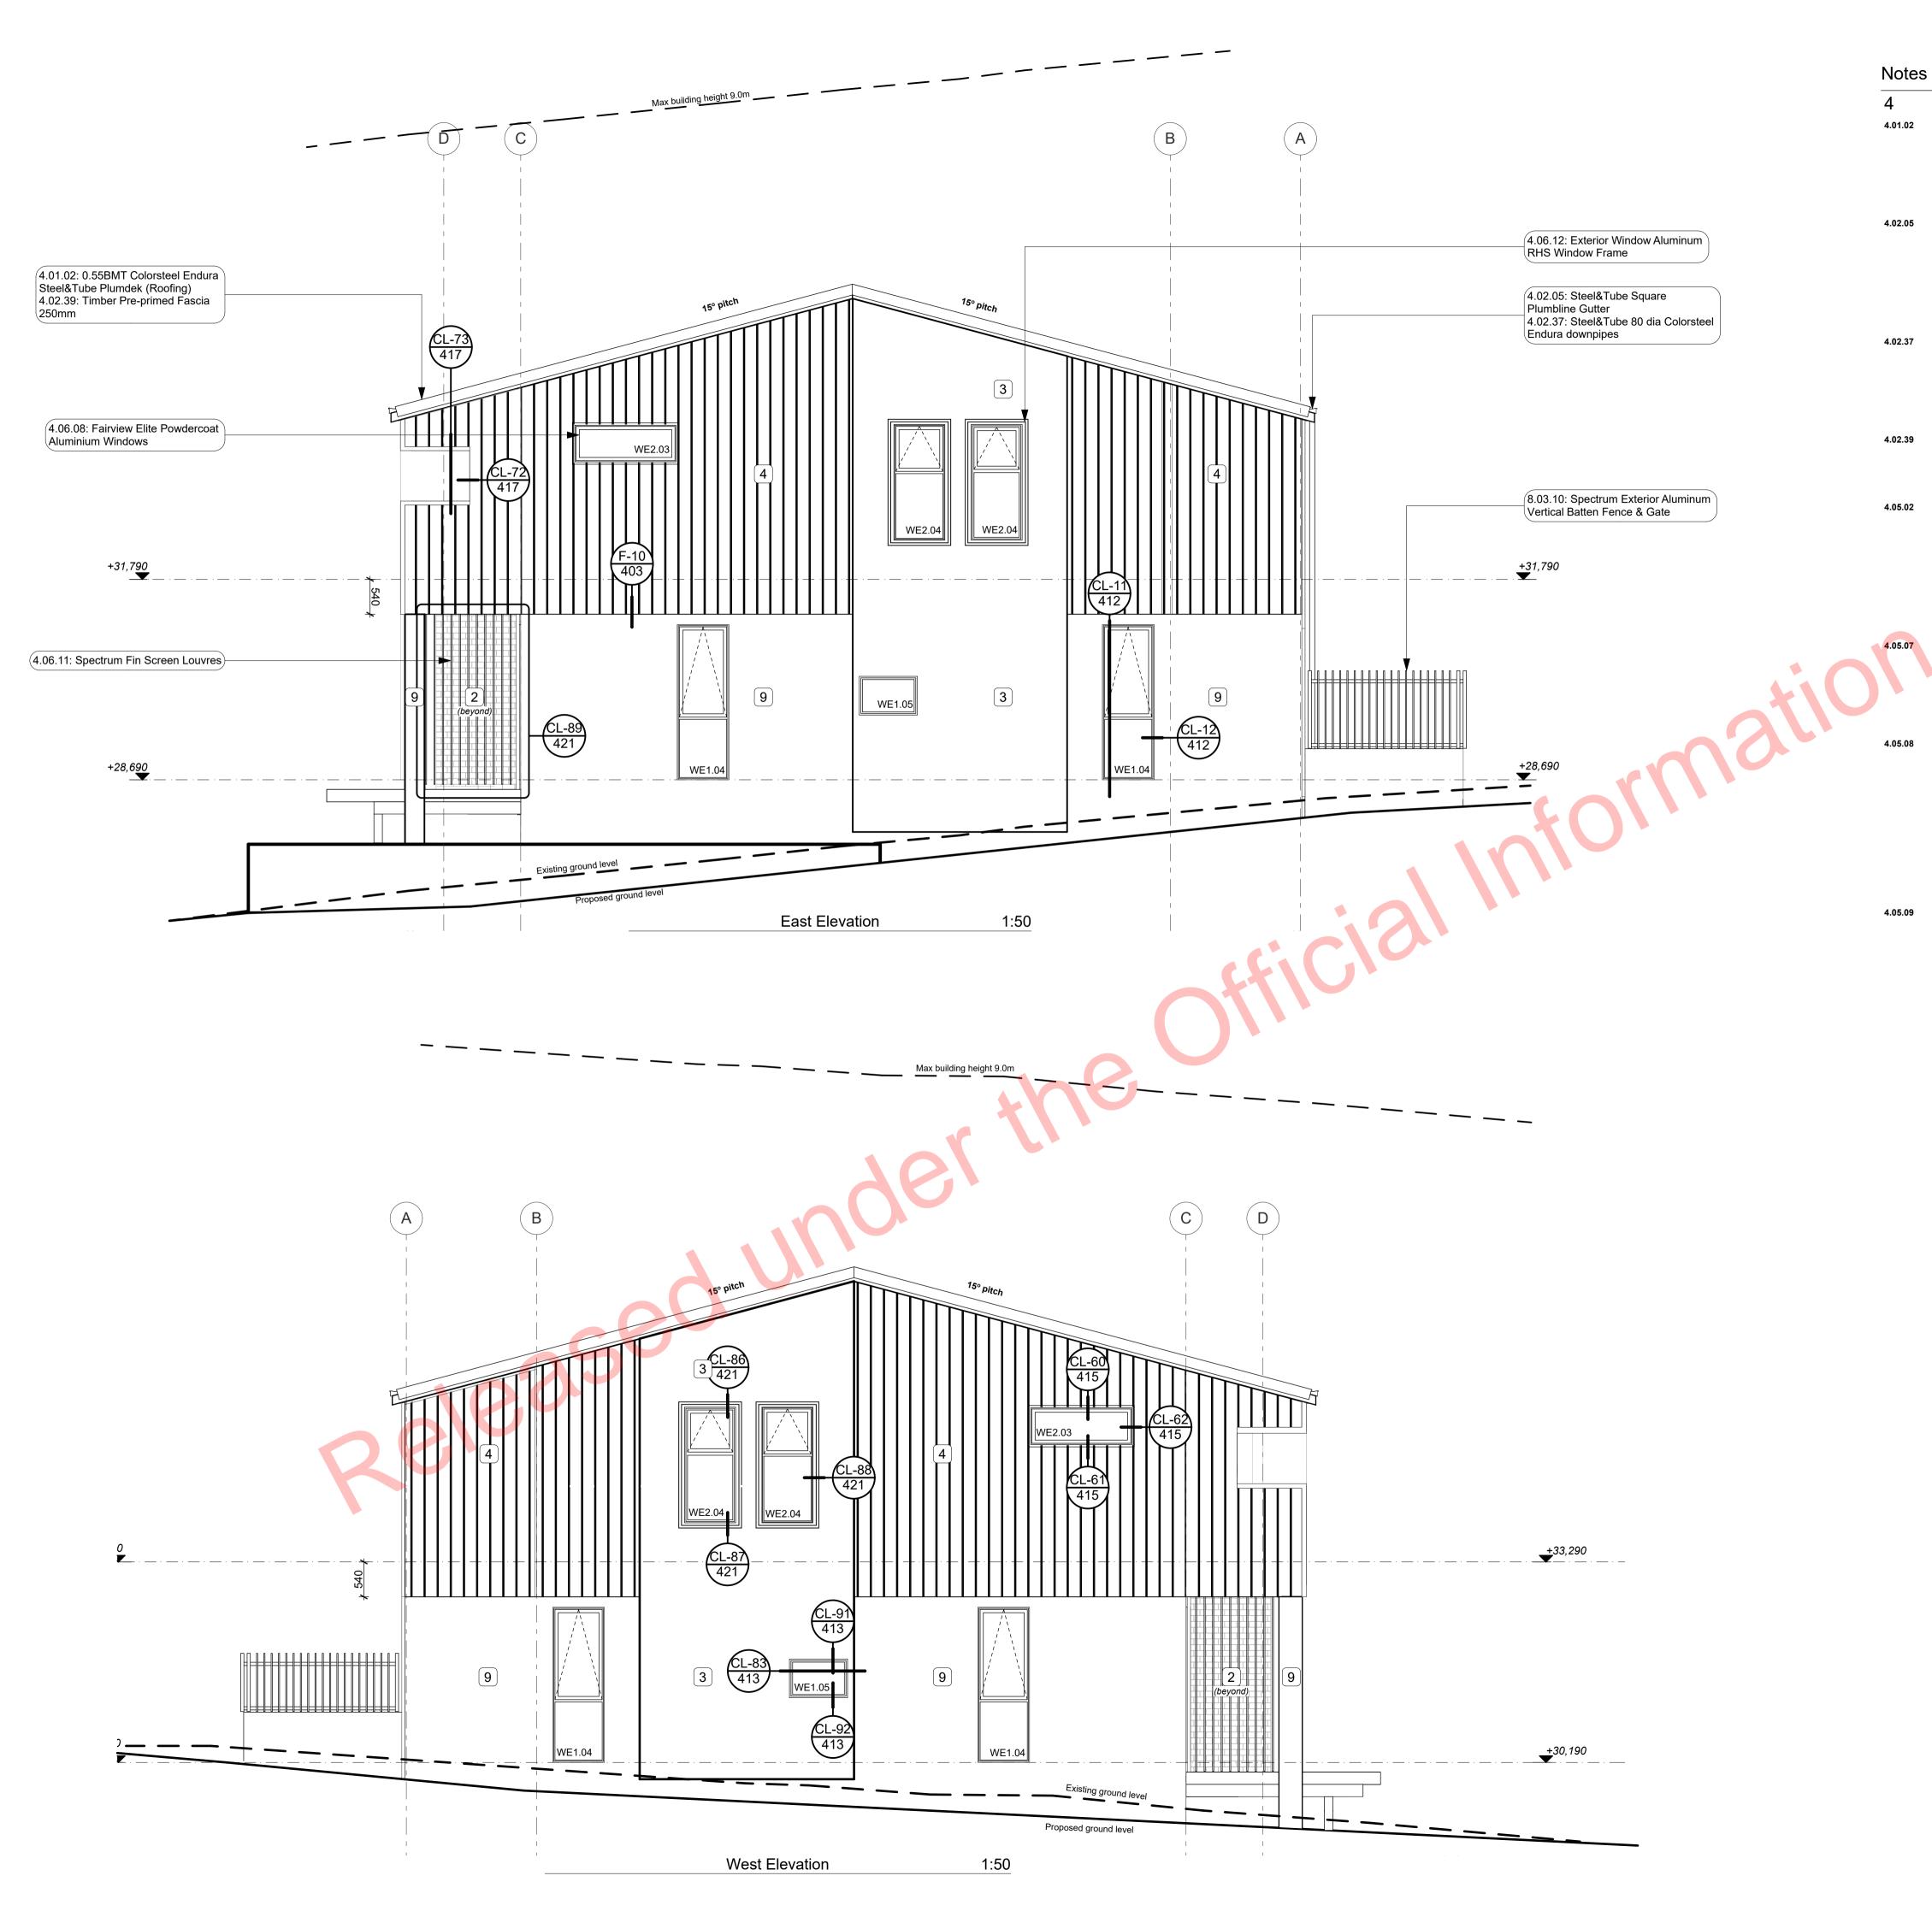

0.55BMT Colorsteel Endura 4.05.11 Steel&Tube Paneldek (Cladding) 0.55BMT Colorsteel Endura **ENCLOSURE** Steel&Tube Paneldek vertical cladding. Fix over separation DPC 0.55BMT Colorsteel Endura Steel&Tube Plumdek (Roofing) over 20x45 H3.2 horizontal timber cavity battens at max 600crs. Cavity battens to be castellated on both faces 0.55BMT Colorsteel Endura Steel&Tube Plumdek roofing system to provide drainage and ventilation and must be used horizontally only. on roofing underlay on 90x45 battens at max 900 crs at pitch as per roof Fix cladding with S&T concealed fixing clip. Install strictly as per manufacturer's specifications and plans, sections and elevations. Install strictly as per manufacturer's specifications and details. 6mm JH HardieFlex cladding 4.05.23 Steel&Tube Square Plumbline 6mm thick James Hardie Hardieflex Fibre Cement cladding over 45x20 Steel&Tube Square Plumbline H3.2 vertical cavity battens at max 600 Coloursteel Endura Gutter on internal brackets [as per manufacturers Install strictly as per manufacturer's specification] on steel fascia. Install specifications and details. strictly as per manufacturer's specifications and details. Brackets 4.5mm JH Eclipsa Soffit Lining and gutter to be finished to match 4.5mm James Hardie Eclipsa soffit lining on 45 x 90 (unless specifically sized for specific depth. Refer to architectural details) H1.2 timber Steel&Tube 80 dia Colorsteel framing @ max 600mm crs. Paint Endura downpipes Steel&Tube 80dia Colorsteel Endura finish with uPVC jointers @600crs. Install strictly as per manufacturer's downpipes. Ensure downpipe location specifications and details. is within boundary of respective unit. Install strictly as per manufacturer's 14mm JH Stria cladding specifications and details. Downpipes 14mm thick James Hardie Stria Fibre to be finished to match roofing and Cement cladding over 45x20 H3.2 vertical cavity battens at max 600 cr Timber Pre-primed Fascia 250mm 25mm x250mm Pre-primed paint finish Install strictly as per manufacturer's specifications and details. Fascia finished to match roofing. Fairview Elite Powdercoat Install strictly as per manufacturer's Aluminium Windows Elite Fairview Classic Residential 35 specifications and details. Refer details for height. Powdercoated Aluminium Windows. Colour as per Resource Consent Plytech 12mm Exterior Grade Ply Soffit Lining Plytech Radiata Decorative SD 12mm specifications. Double glazed with paint grade radiata pine architraves. Obscure glass to bathrooms, wc's and Exterior Grade H3.2 LOSP Ply Soffit ensuites. Refer to window and door lining on 35 x 70 (unless specifically schedule. Confirm size on site prior to sized for specific depth. Refer to manufacture. Install strictly as per architectural details) H1.2 timber manufacturer's specifications and framing battens @ 600mm crs. with details. Hardware TBC by client. factory applied Blonded / Clear Coat finish and further site applied coating. Spectrum Fin Screen Louvres C/S SS screw fixings. Use Spectrum 115x17 aluminum RHS fins Shadowclad negative detail at sheet louvre system fixed to 115x3 joints. Refer specification. Aluminium plate top and bottom fixed

to underside of concreet beam / deck

edge. Powdercoated finish to match

manufacturer's specifications and

Exterior Window Aluminum RHS

Spectrum (or approved similar) 150 x 40 aluminum RHS frame.

Powdercoated finish to match joinery. Install strictly as per manufacturer's

joinery. Install strictly as per

Window Frame

specifications and details.

EXTERIOR

Consent drawings.

Spectrum Exterior Aluminum

Vertical Batten Fence & Gate

Freestanding Spectrum Aluminium

Powdercoat finish as per Resource

Vertical Batten Fence and Gate.

BUILDING ENVELOPE RISK MATRIX EAST ELEVATION Risk Factor Risk Severity Risk Score High risk Wind zone (per NZS 3604) Number of storeys High risk Roof/wall intersection design Medium risk Eaves width Very high risk Medium risk Envelope complexity Deck design Low risk **Total Risk Score:**

Special<mark>ize</mark>d Plaster System

textured finish by Specialized Systems. Min 2 coats of paint. Colour

Specialized plaster System over 20

TBD. All installation in accordance

System only for timber framed wing

Midland NZ Brick Veneer Midland NZ brick veneer with 50mm

cavity with RAB on timber framed

walls, to NZS 3604 : 2011. Provide weep holes @800mm max centres and 10mm ventilation gap between top

of brick and soffit lining. Wall ties and fixings in accordance with NZS 4210:

2001. Standard range motar, colour to

cladding system used on this building

TB1' refer to Midland Brick for Design

must be completed to 'Design Note

match brick. The 2 storey brick

Note TB1. Install strictly as per manufacturer's specifications and

Specialized System EZ Panel

Lightweight Cladding Specialized System EZ Panel 50mm autoclaved lightweight concrete

Facade System over 50x20mm High Density EPS vertical cavity battens at

600crs max. Float textured finish by Specialized Systems. Min 2 coats of

paint. Colour TBD. All installation in


specifications. System only for timber

accordance with manufacturers

with manufacturers specifications.

series masonary blockwork, Float

BUILDING ENVELOPE RISK MATRIX WEST ELEVATION			
Wind zone (per NZS 3604)	High risk	1	
Number of storeys	High risk	2	
Roof/wall intersection design	Medium risk	1	
Eaves width	Very high risk	5	
Envelope complexity	Medium risk	1	
Deck design	Low risk	0	
Total Risk Score:		10	

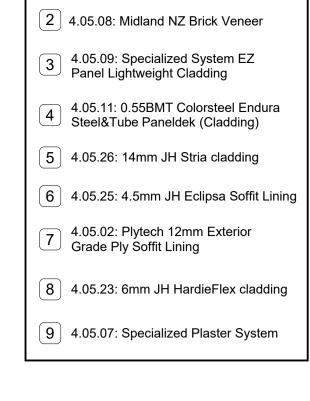

MATERIALS LEGNED:

THE FOLLOWING: - STRUCTURAL ENGINEERING PLANS & SPECIFICATION BY HFC GROUP TRUSS MANUFACTURER'S PLANS & SPECIFICATION BY CARTERS FIRE ENGINEERING DESIGN REPORT BY **HFC GROUP** - ACOUSTIC REPORT BY **HEAGLEY ACOUSTICS** - STORMWATER & SANITARY CONNECTION POINTS BY CRANG CIVIL ALL ARCHITECTURAL DRAWINGS TO BE **READ IN CONJUNCTION WITH ENGINEERING** DRAWINGS BY HFC GROUP LTD

PLANS TO BE READ IN CONJUNCTION WITH



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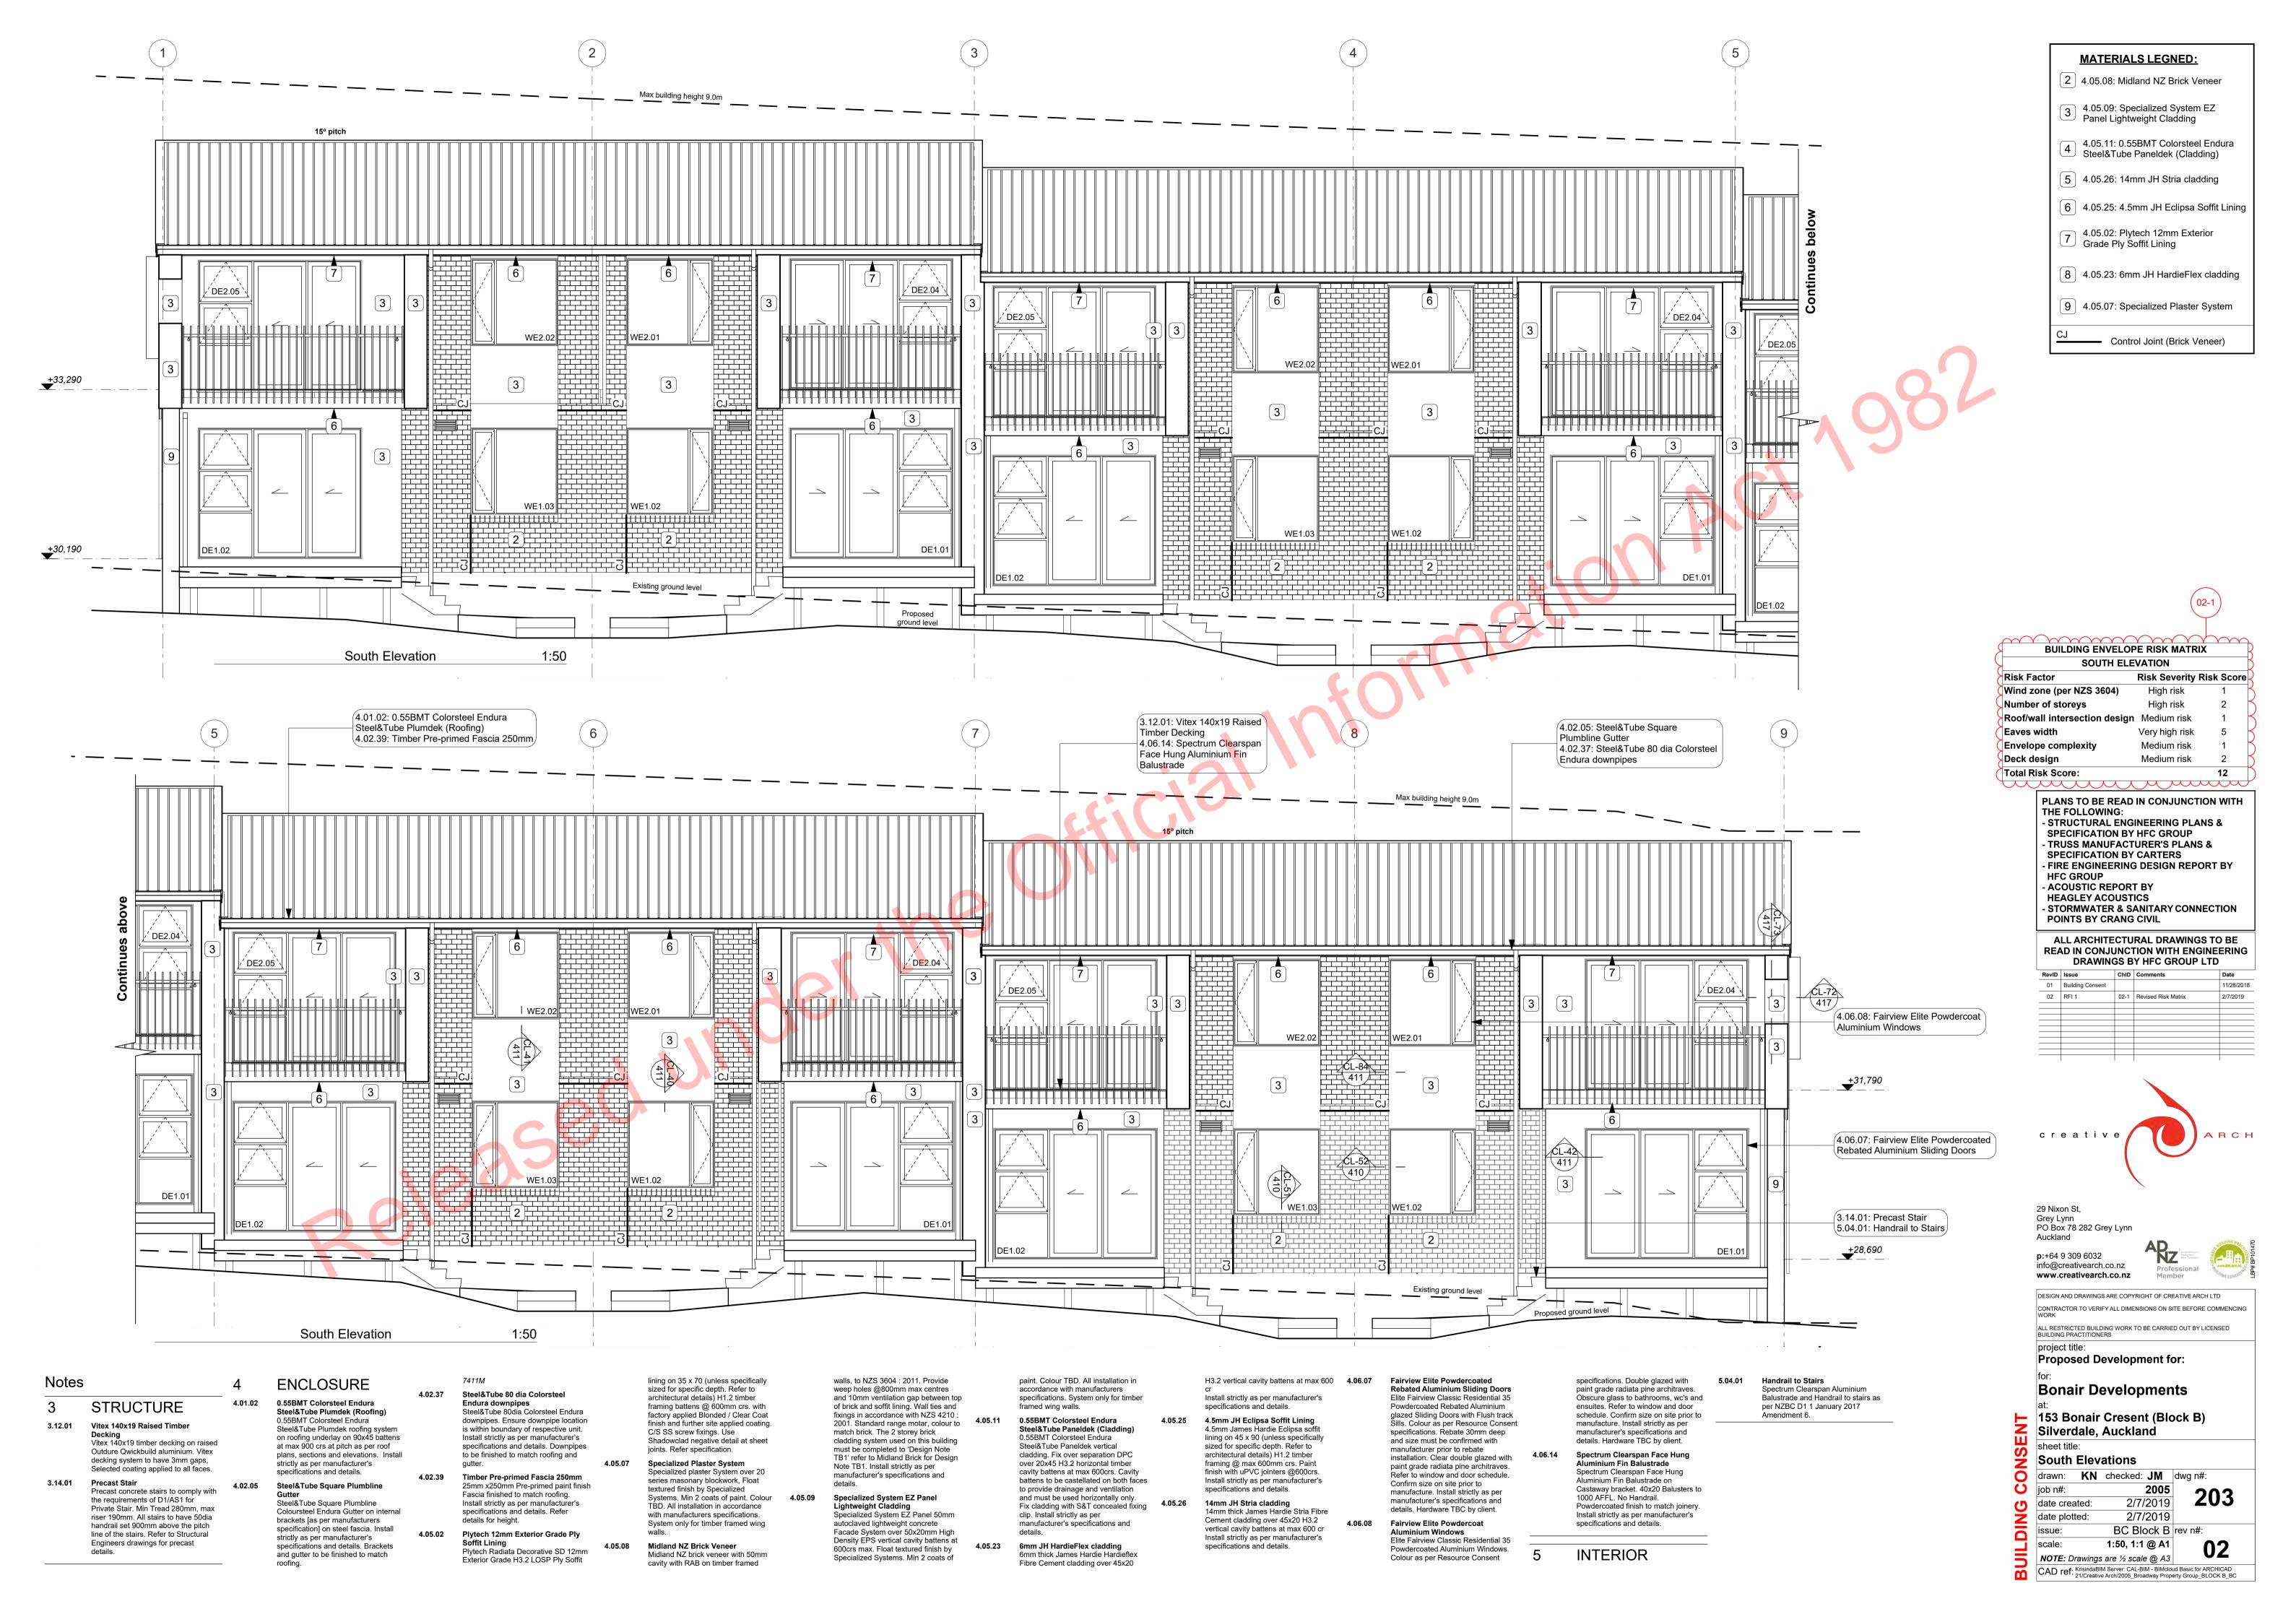
ALL RESTRICTED BUILDING WORK TO BE CARRIED OUT BY LICENSED BUILDING PRACTITIONERS project title: **Proposed Development for:**


Bonair Developments

153 Bonair Cresent (Block B) Silverdale, Auckland sheet title:

East & West Elevations drawn: KN checked: JM dwg n#: 2005 date created:

11/28/2018 2/7/2019 BC Block B rev n#: 1:50, 1:1 @ A1 NOTE: Drawings are ½ scale @ A3 CAD ref. KrisindaBIM Server: CAL-BIM - BIMCloud Basic for ARCHICAD 21/Creative Arch/2005_Broadway Property Group_BLOCK B_BC



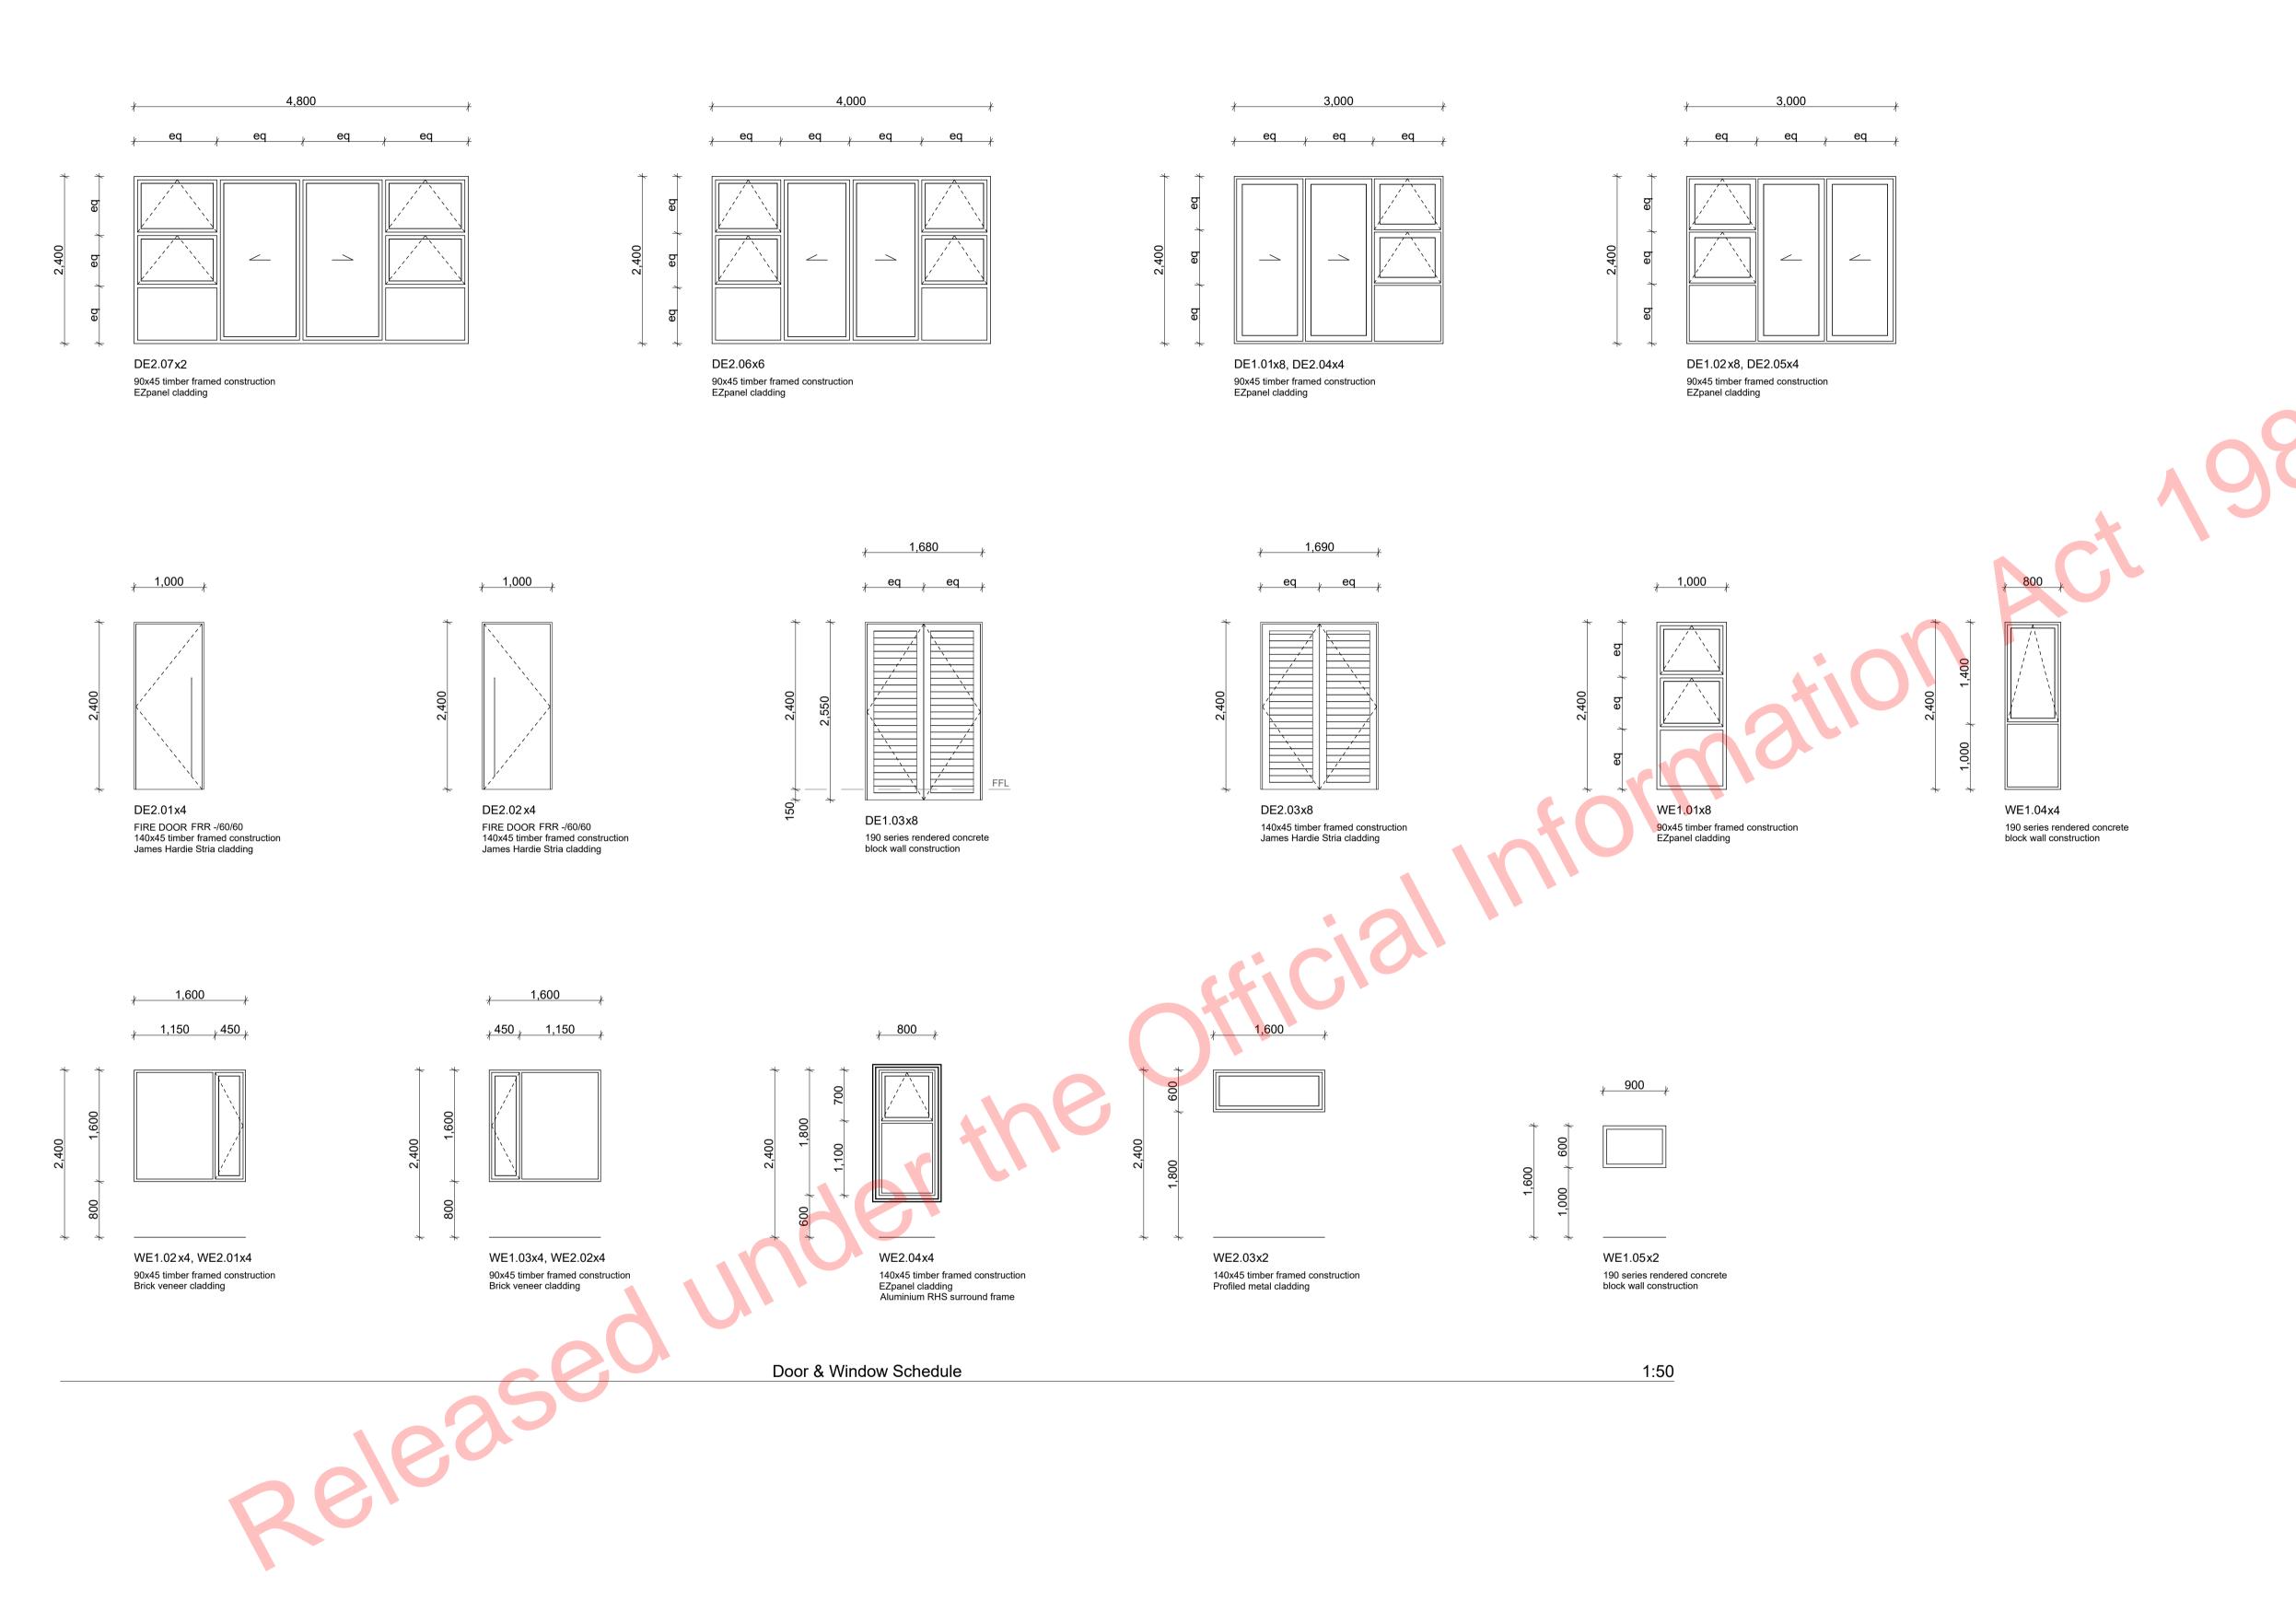

WINDOW AND DOOR NOTES:

GENERAL:

Site measure all joinery & check prior to constructionWindow suite design to allow for HIGH wind zone

- Exterior windows and doors viewed from exterior - Schedule to be read in conjunction with elevations and

the floor plans
- Supplier shall be IGUMA approved

JOINERY:

- Finish to be powdercoated aluminium (scratched joinery

will be rejected)
- Timber jamb liners with planted architraves. Refer to

detail/spec

Ensure continuous sill support to all joineryEnsure continuous 'tight fit' backing rod for sealing

around joinery openings HARDWARE:

To later schedule to owners approval

INTERNAL DOORS:

Typically solid core/flush/paint finish
ALL cavity sliding doors shall be reinforced with steel to prevent warping of jambs / lining.

GLASS:

- All glass to NZS 4223

- All joinery to be double glazed unless indicated otherwise on schedule


10mm thoughened glass to showers
Safety glass to all wet areas
Grey tint unless noted as Opaque

INSTALLATION: - Building paper shall be folded into the perimeter of all window and door openings to the inside face of framing - All corners shall be taped and flexible flashing tape applied to the head and the sill using Thermakraft

Aluband window sealing system
- Head, Sill and Jamb flashings throughout - All in

accordance with E2/AS1 of the NZBC



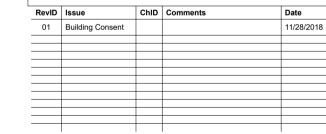



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PO Box 78 282 Grey Lynn Auckland

project title:

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Proposed Development for:

Bonair Developments


Silverdale, Auckland sheet title:

Door & Window Schedule

drawn: KN checked: JM dwg n#: 2005 date created: 11/28/2018

2/7/2019 BC Block B rev n#: 1:50 @ A1

NOTE: Drawings are ½ scale @ A3 CAD ref. KrisindaBIM Server: CAL-BIM - BIMCloud Basic for ARCHICAD 21/Creative Arch/2005_Broadway Property Group_BLOCK B_BC

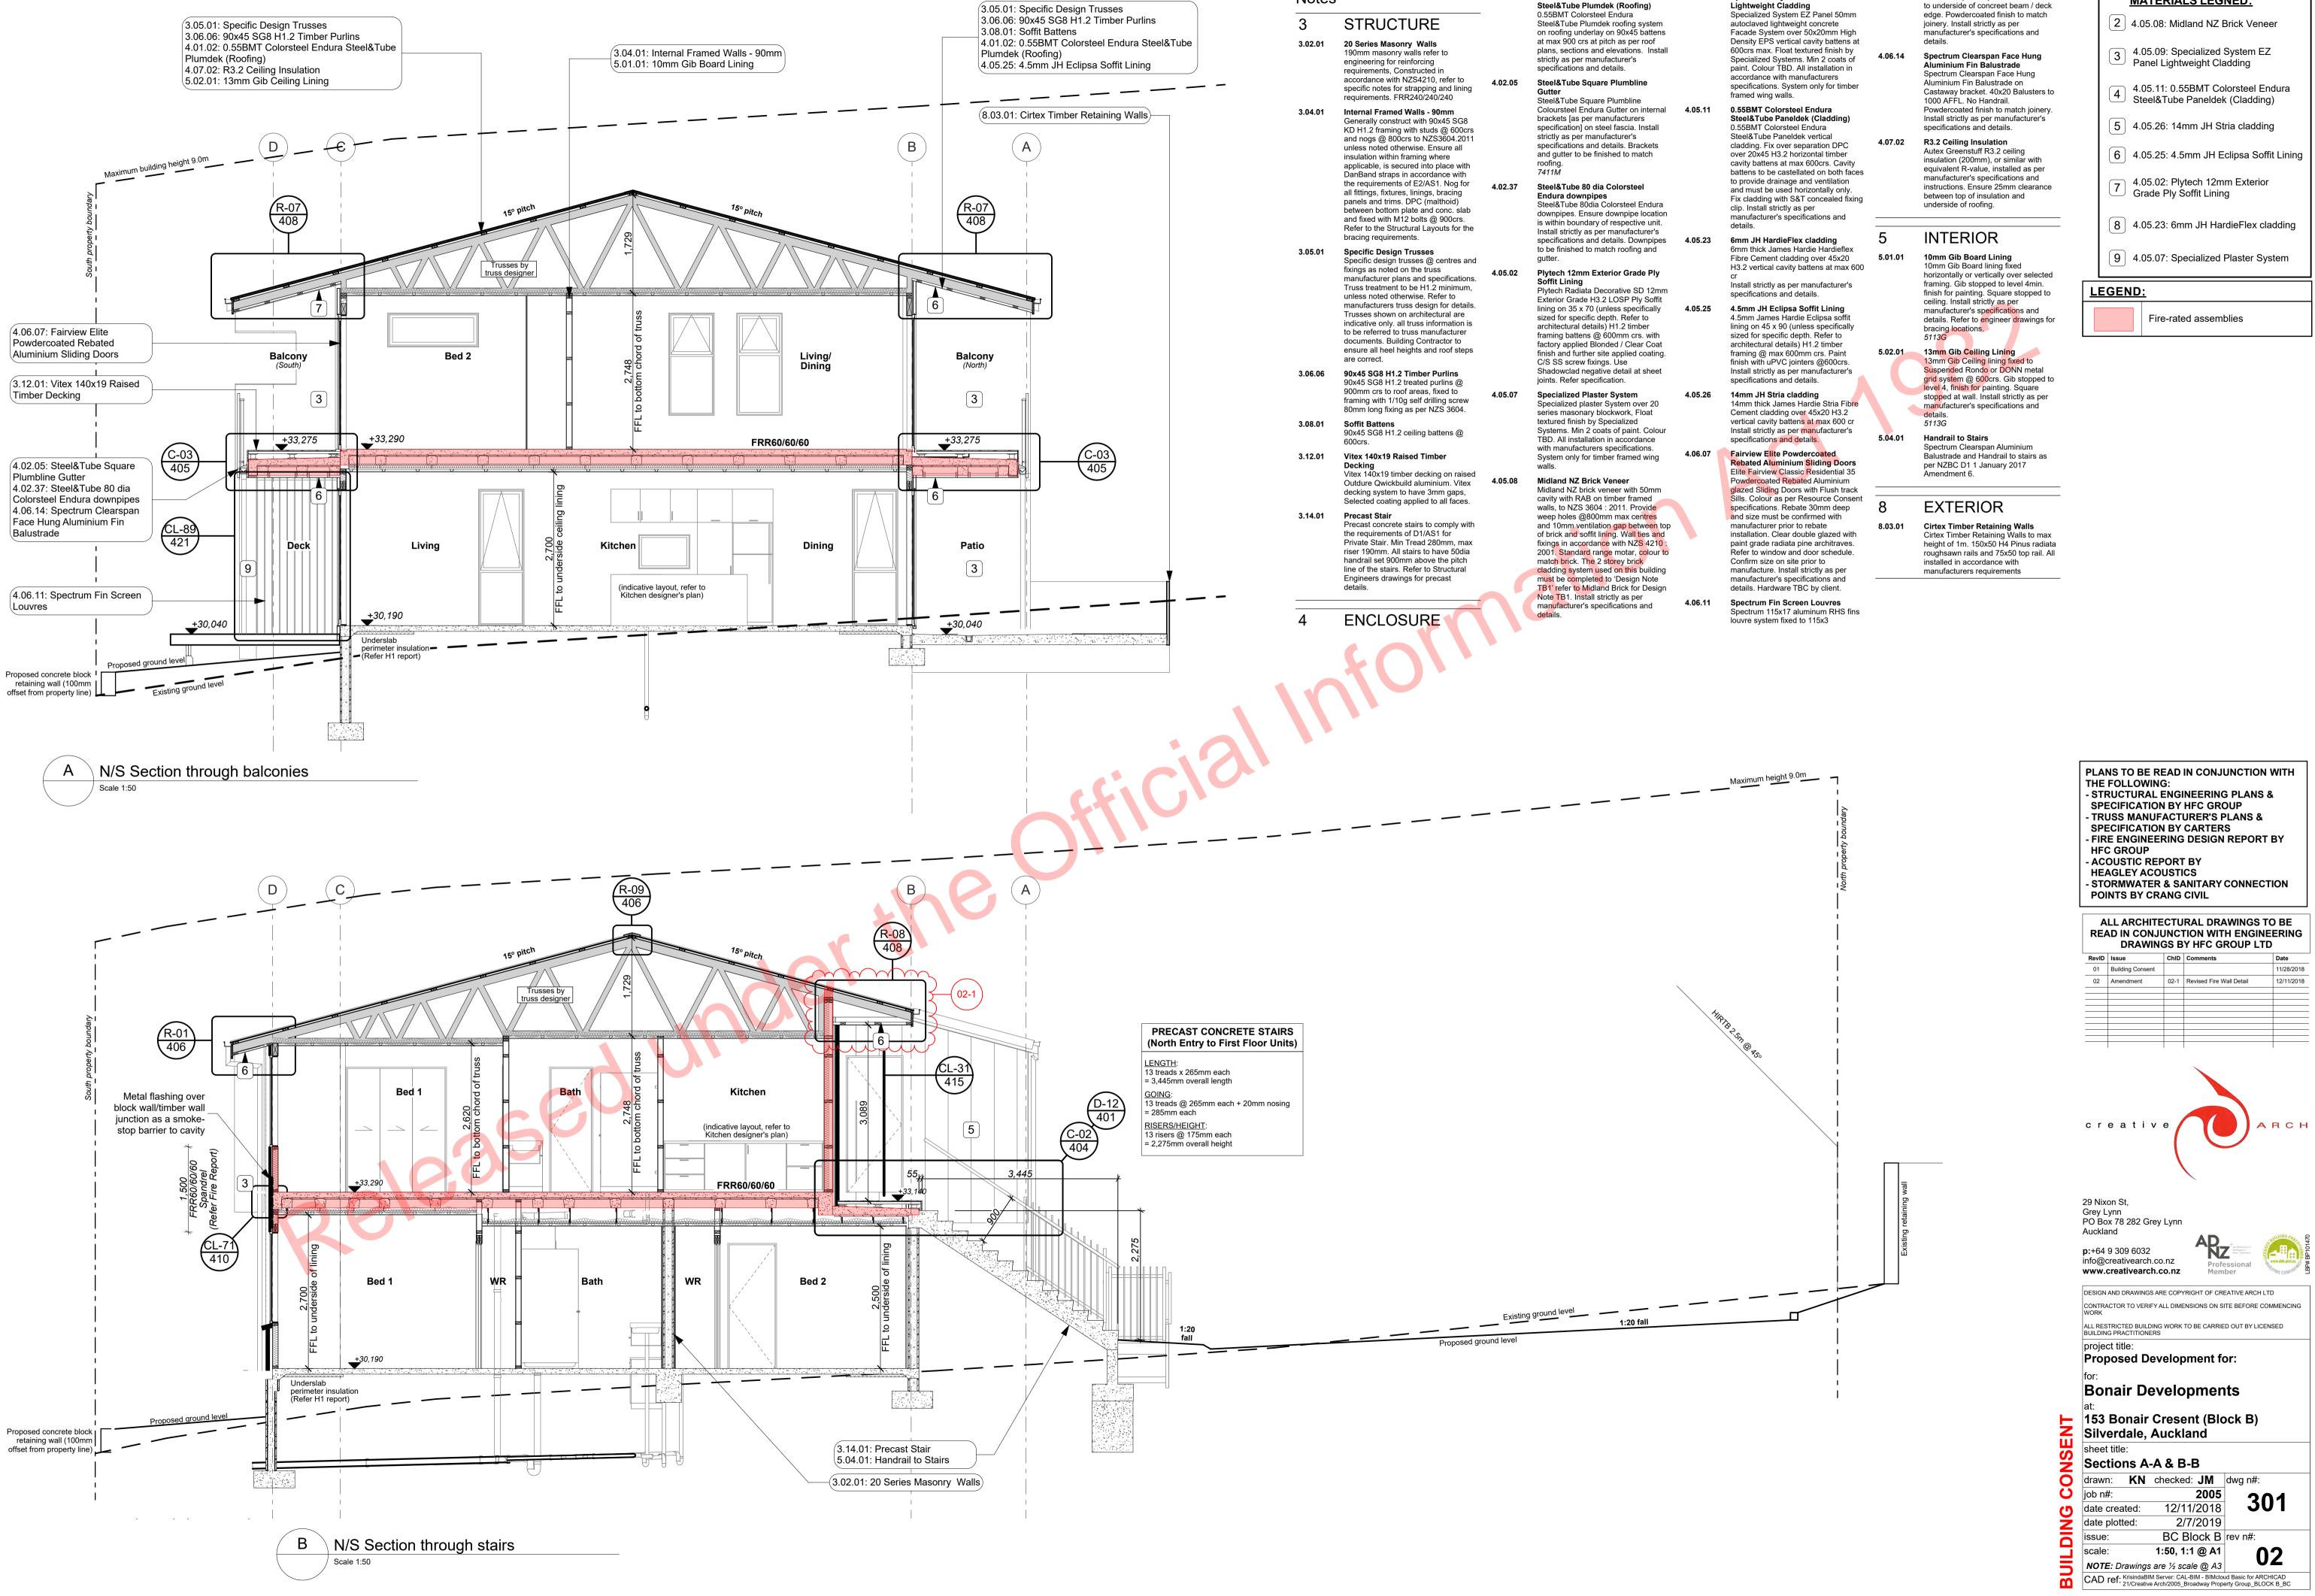

4.01.02 0.55BMT Colorsteel Endura


4.05.09


Specialized System EZ Panel

Notes

MATERIALS LEGNED:

Aluminium plate top and bottom fixed

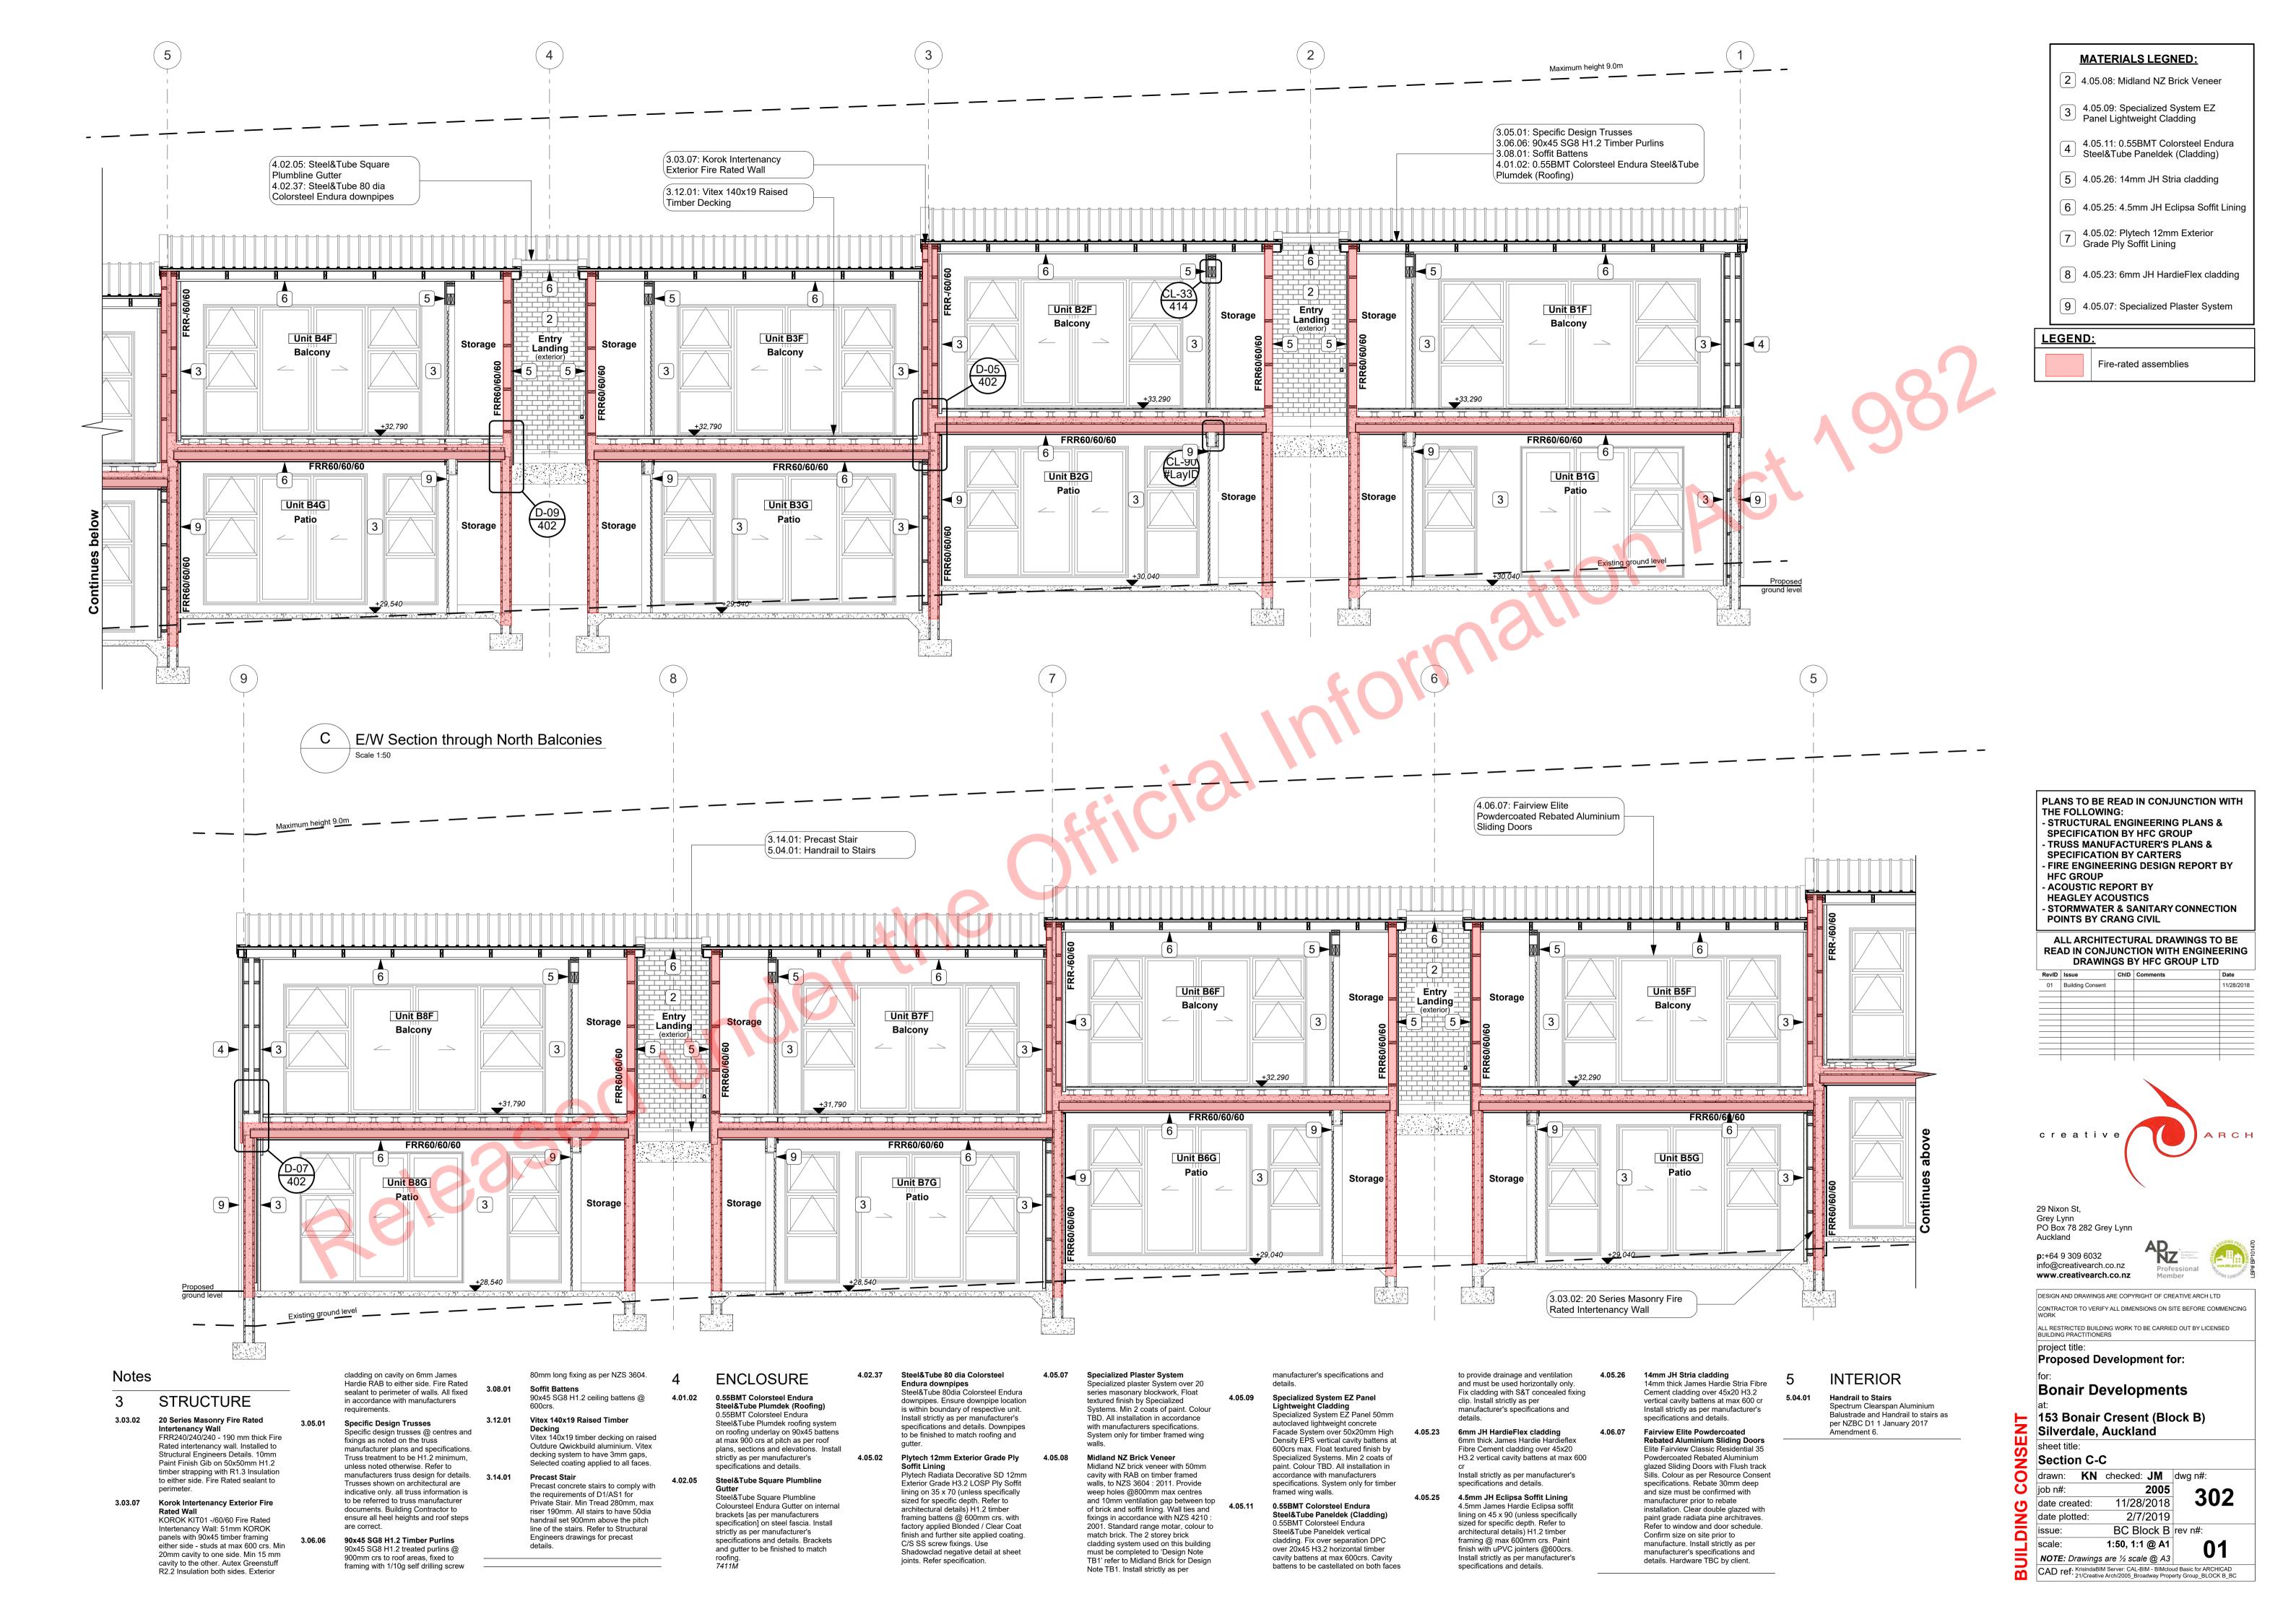

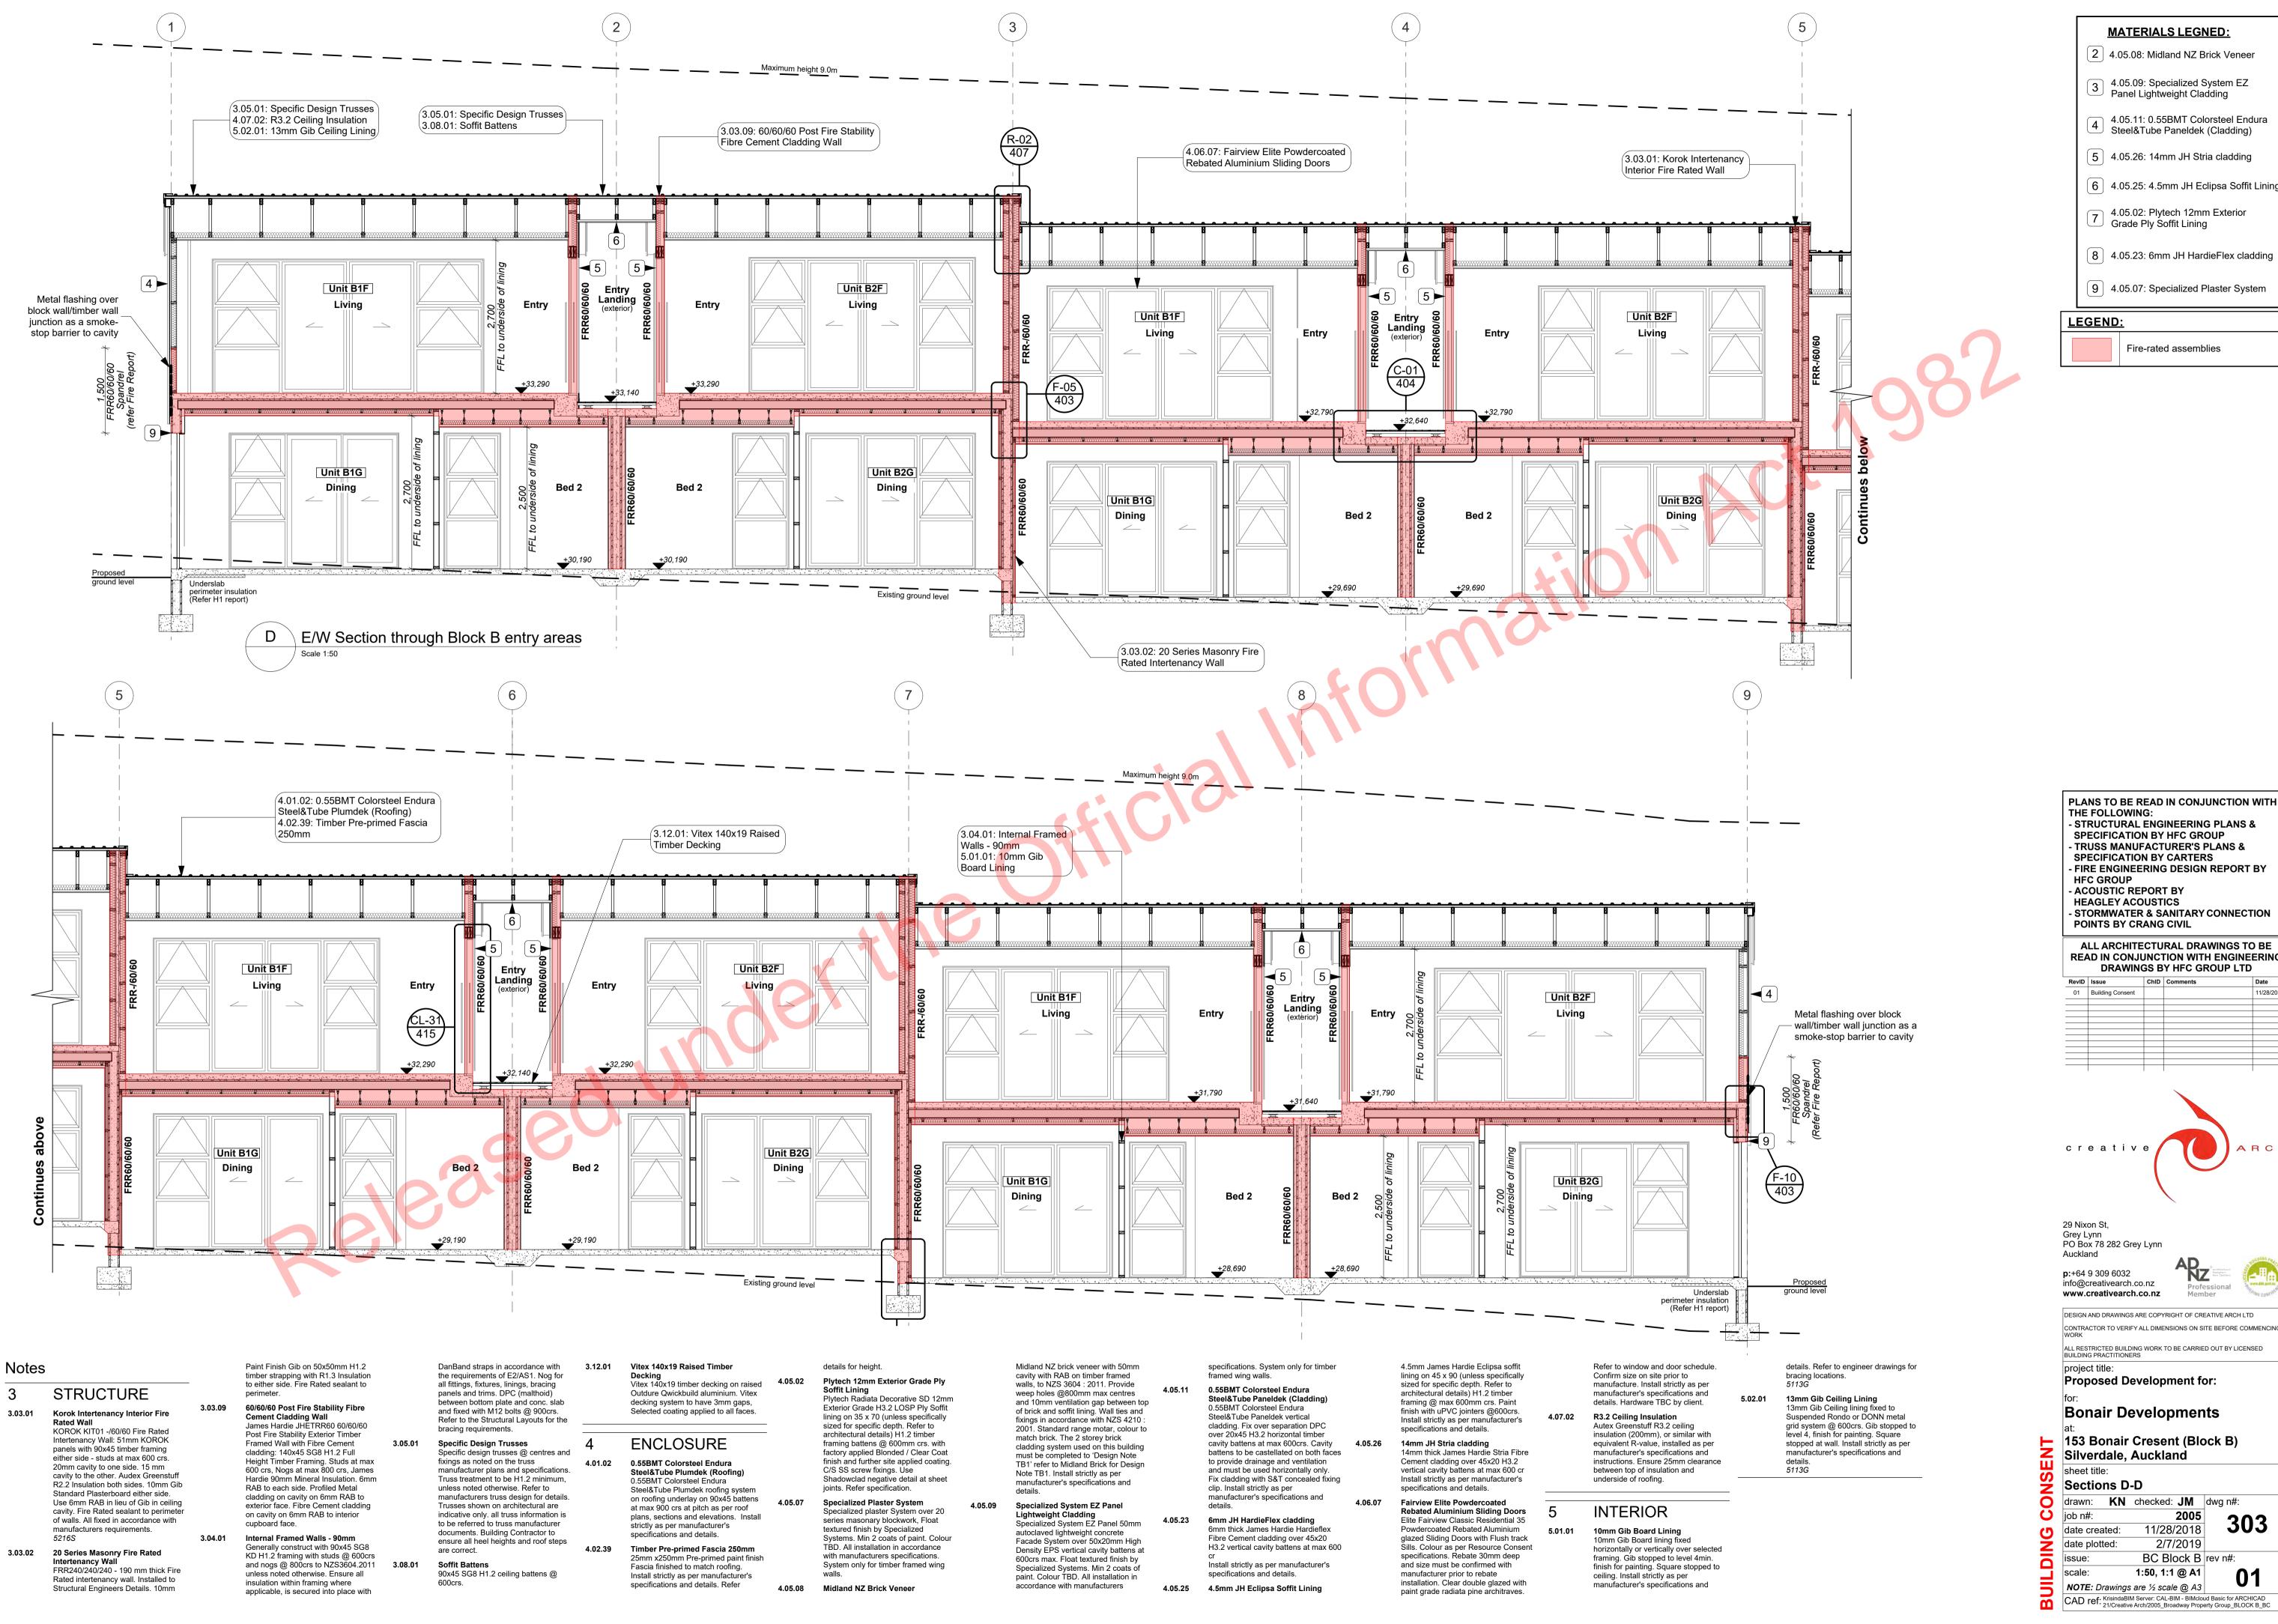

MATERIALS LEGNED:

2 4.05.08: Midland NZ Brick Veneer

4.05.09: Specialized System EZ Panel Lightweight Cladding

4.05.11: 0.55BMT Colorsteel Endura Steel&Tube Paneldek (Cladding)

5 4.05.26: 14mm JH Stria cladding

6 4.05.25: 4.5mm JH Eclipsa Soffit Lining

4.05.02: Plytech 12mm Exterior

8 4.05.23: 6mm JH HardieFlex cladding

9 4.05.07: Specialized Plaster System

Fire-rated assemblies

- TRUSS MANUFACTURER'S PLANS & SPECIFICATION BY CARTERS - ACOUSTIC REPORT BY

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Proposed Development for:

Bonair Developments


153 Bonair Cresent (Block B)


Silverdale, Auckland

KN checked: JM dwg n#: 2005 11/28/2018

2/7/2019 1:50, 1:1 @ A1

BC Block B rev n#: NOTE: Drawings are ½ scale @ A3

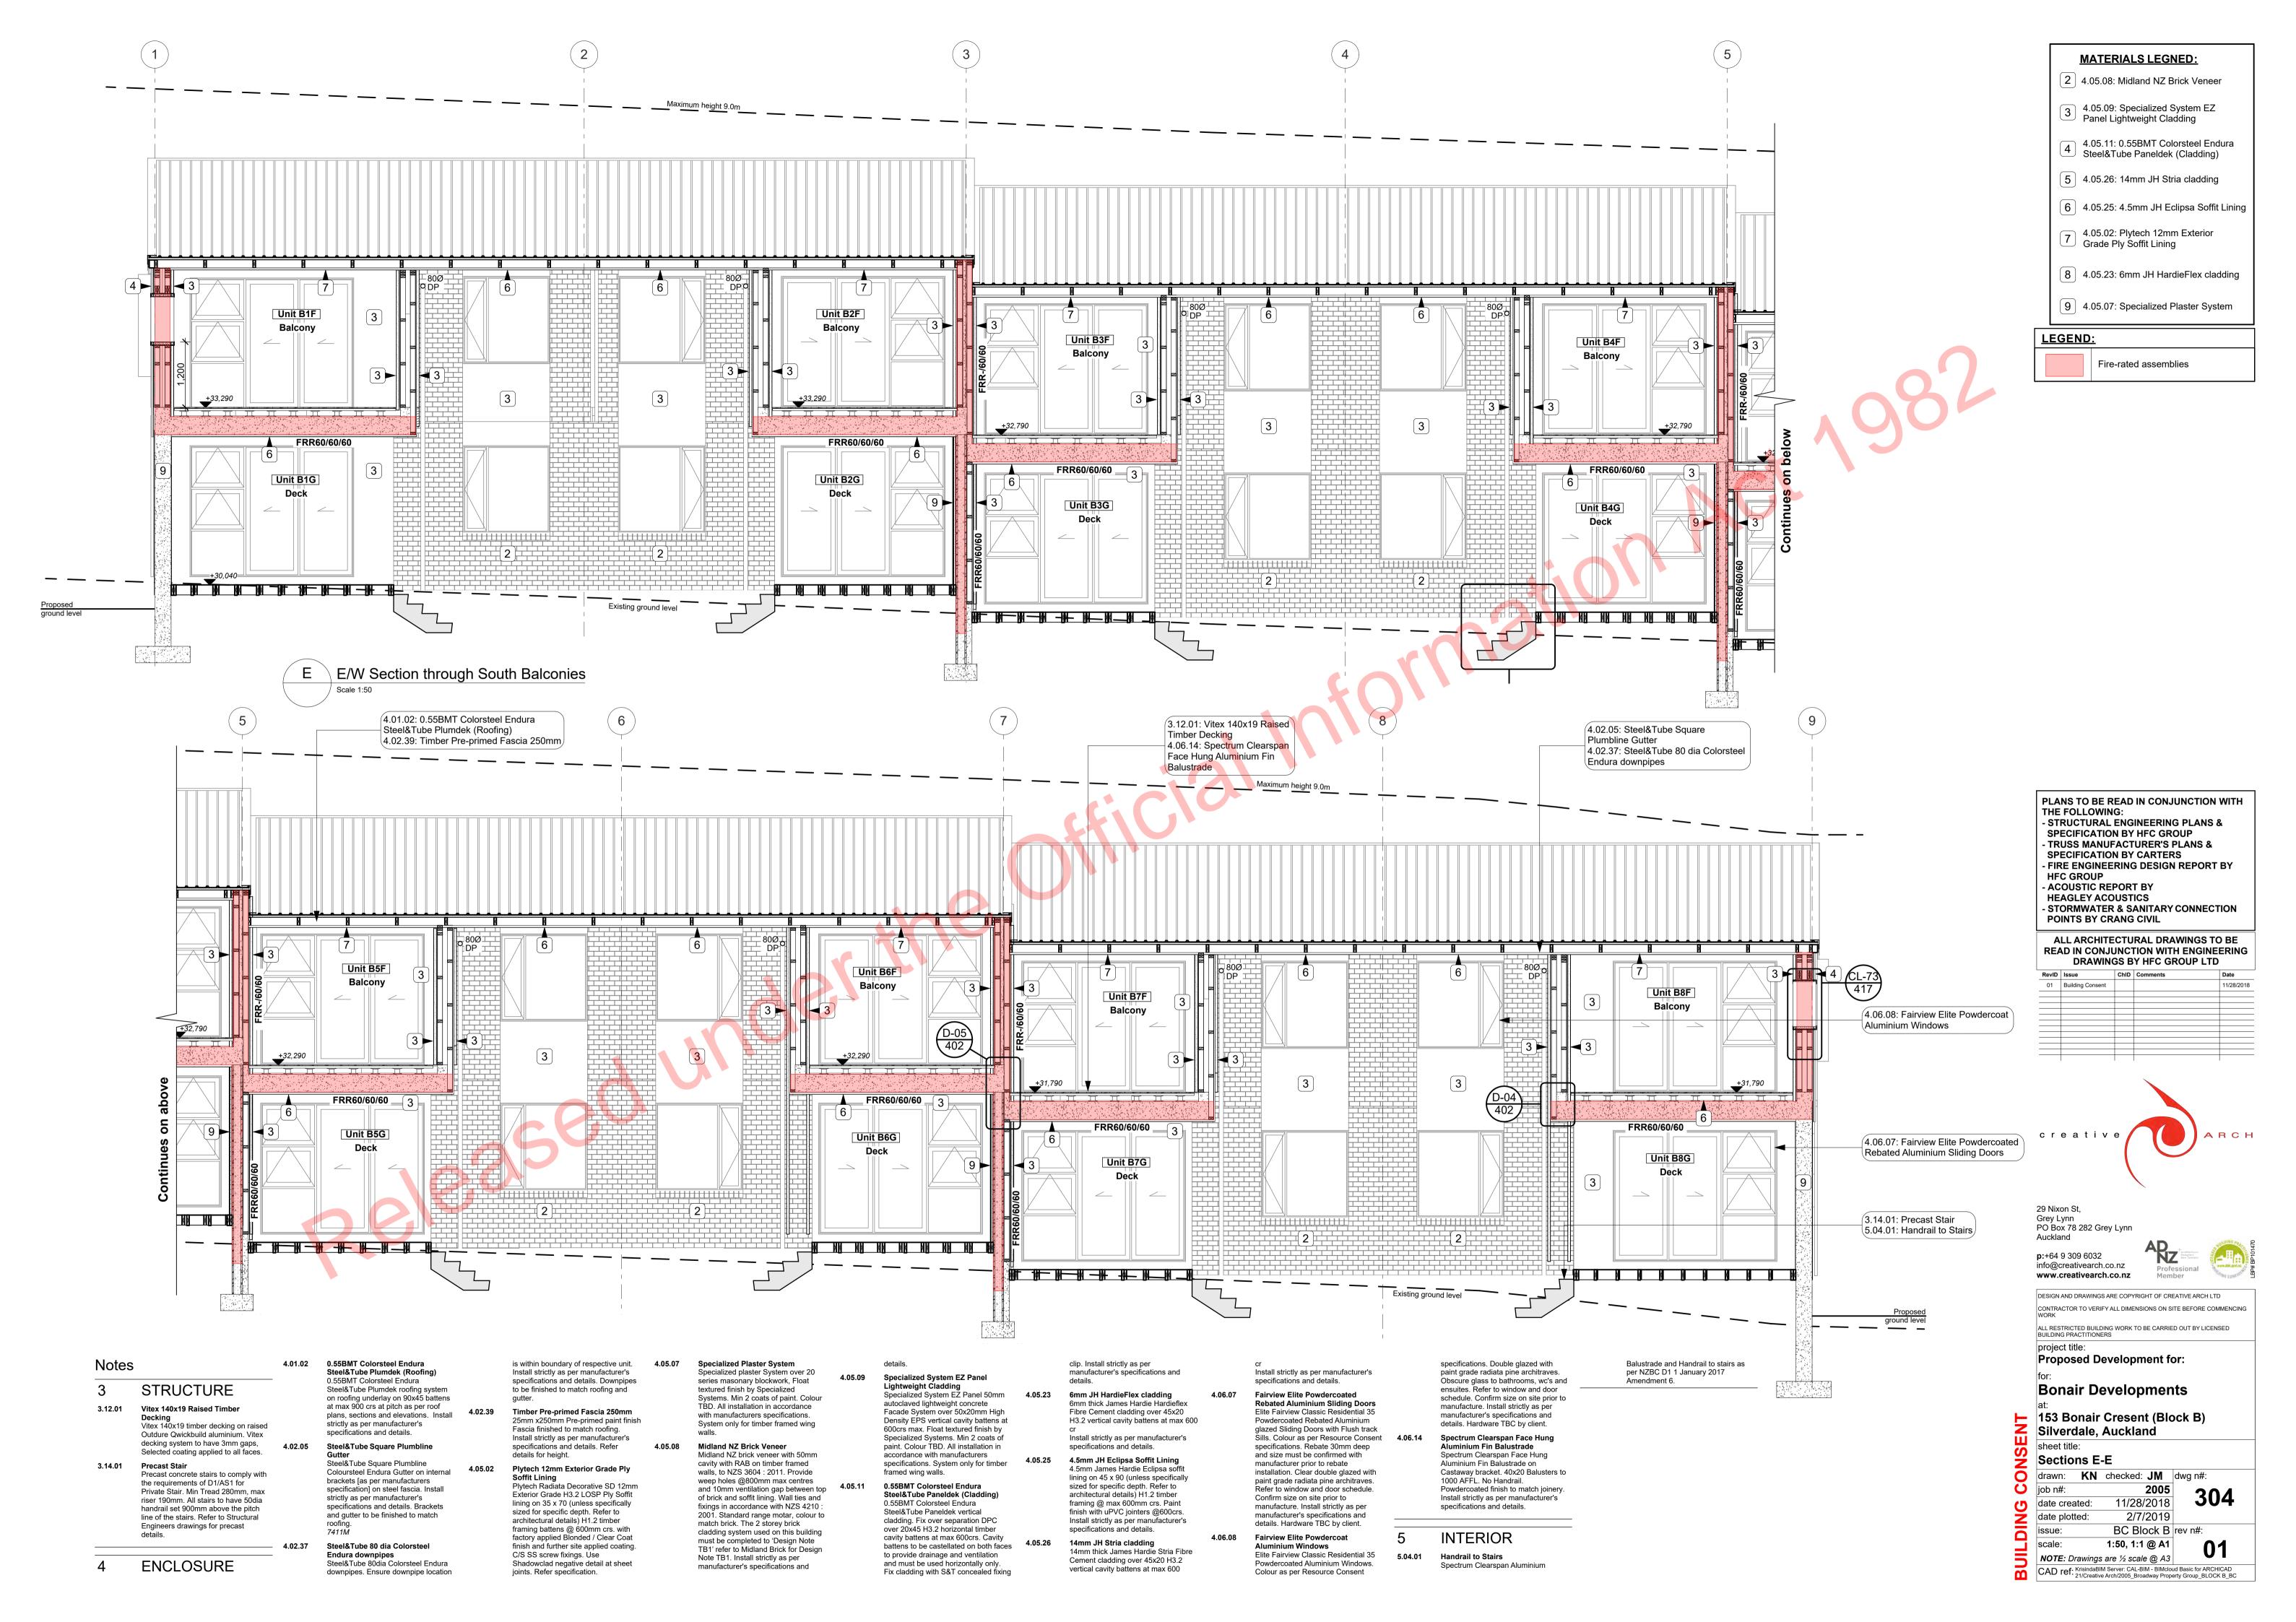

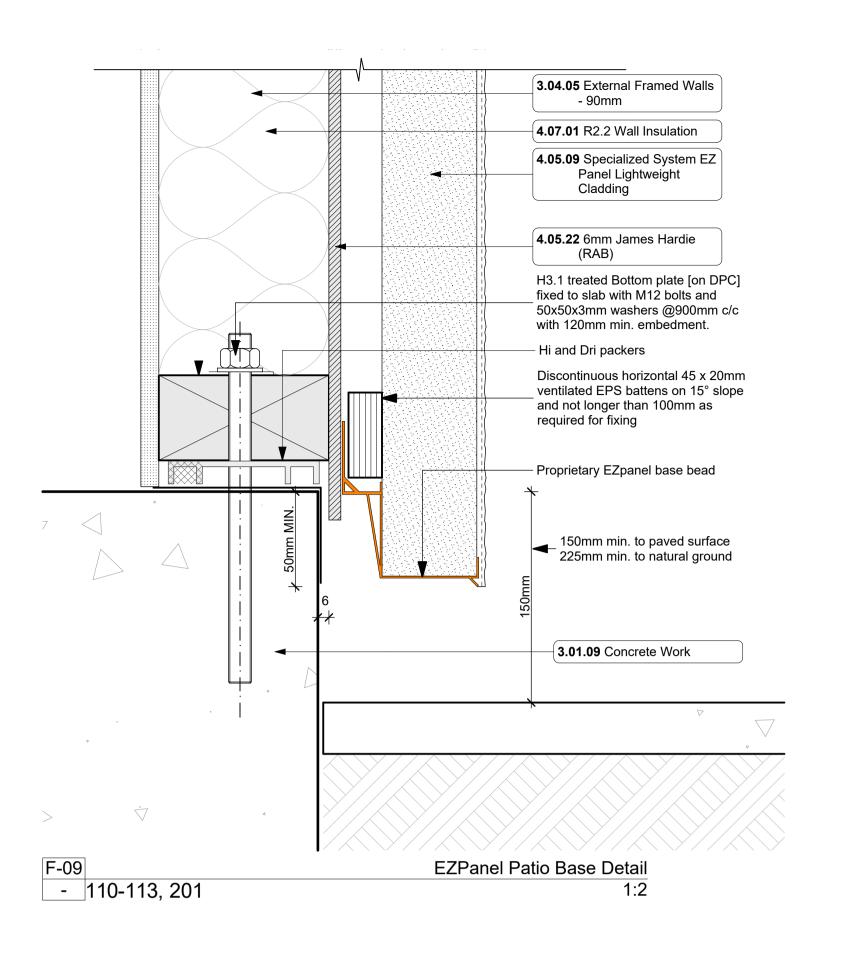

Provide weep holes every 800mm along the

base of brick veneer

Back fill with mortar

D-01 - 118,119

behind first row of -

laid brick veneer

(5.01.01: 10mm Gib Board Lining)

4.07.01: R2.2 Wall Insulation

(4.05.22: 6mm James Hardie (RAB)


4.05.08: Midland NZ Brick Veneer


Brick to Foundation Block Wall Detail

FFL Ground Floor

Hi and Dri packer

(3.04.05: External Framed Walls - 90mm)

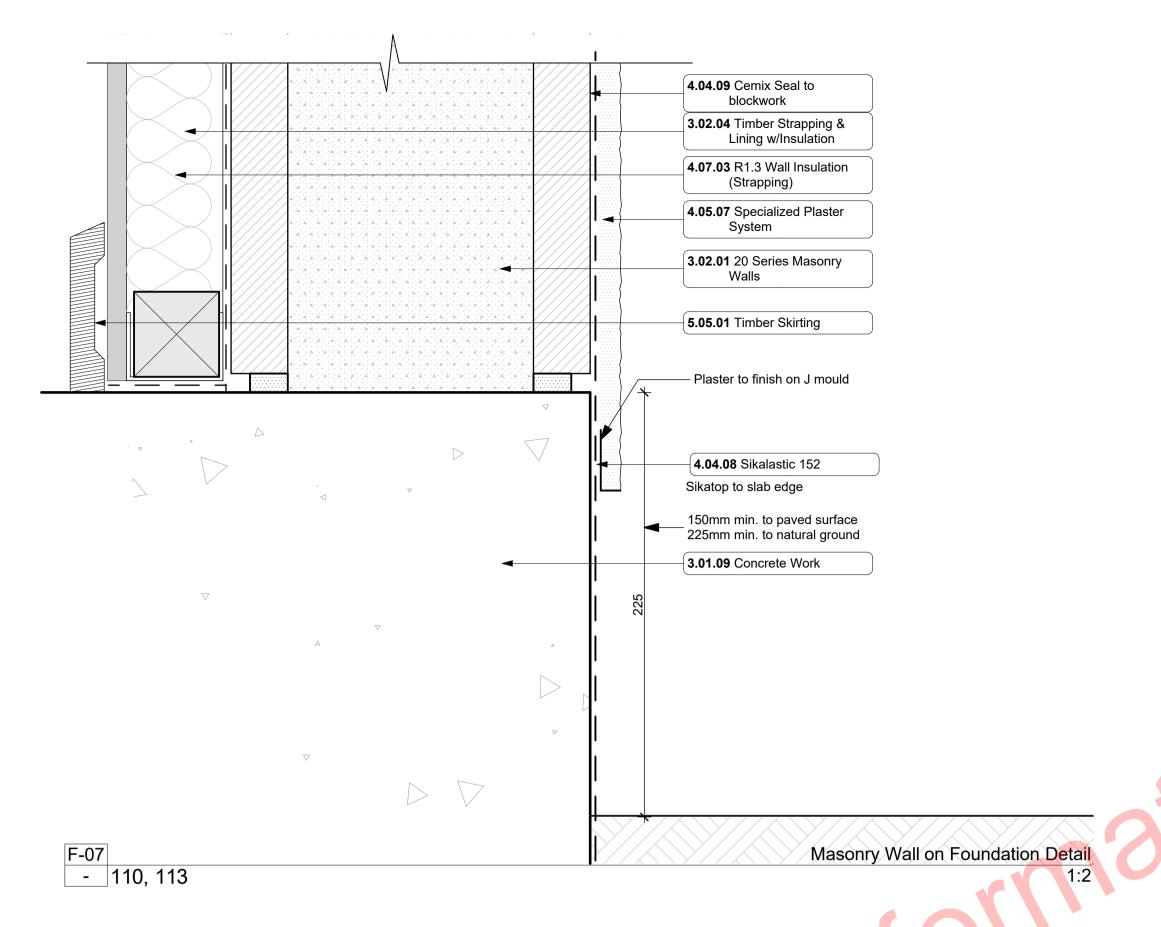

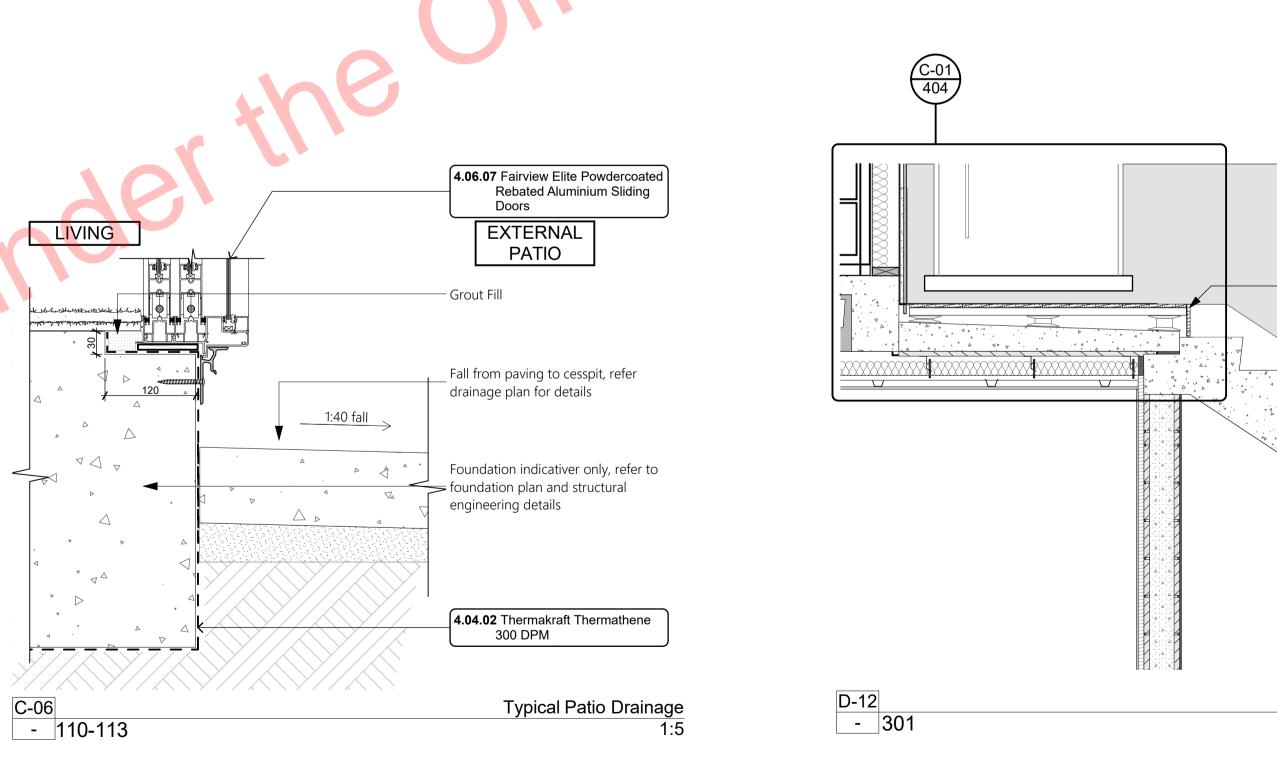

Notes

STRUCTURE

3.01.09 Concrete Work

Refer to Architectural drawings for all nibs, rebates, recesses etc. and for all setout dimensions and finished levels. Ensure all reinforcing sizing, frequency and locations are in accordance with the requirements of the Structural Engineers design.

3.02.01 20 Series Masonry Walls

190mm masonry walls refer to engineering for reinforcing requirements, Constructed in accordance with NZS4210, refer to specific notes for strapping and lining requirements. FRR240/240/240

3.02.04 Timber Strapping & Lining w/Insulation Masonry block wall to be strapped with 50x50mm H1.2 battens on dpc at 600crs with Audex Greenstuff R1.3 40mm fibreglass insulation installed between with 10mm Gib board lining.

3.04.05 External Framed Walls - 90mm

Generally construct with 90x45 SG8 KD H1.2 framing with studs on Hi and Dri packers at crs as per setout plans and nogs @ 600crs to NZS3604.2011 unless noted otherwise. Ensure all insulation within framing where applicable, is secured into place with DanBand straps in accordance with the requirements of E2/AS1. Nog for all fittings, fixtures, linings, bracing panels and trims. DPC (malthoid) between bottom plate and conc. slab and fixed with M12 bolts @ 900crs. Refer to the Structural Layouts for the bracing requirements. 6mm RAB to exterior face of walls.

ENCLOSURE

4.04.02 Thermakraft Thermathene 300 DPM Thermakraft Thermathene Orange 300 micron polythene damp-proof membrane (DPM) under slab / footings. Install strictly as per manufacturer's specifications and details. 4161T

4.04.08 Sikalastic 152

Sikalastic 152 Exterior Waterproofing Membrane applied to exposed face of Slab and rebates. All in accordance with manufacturers requirements.

4.04.09 Cemix Seal to blockwork Cemix Brick and Block Sealer Applied to block face prior to lining with brick cladding. All in accordance with manufacturers requirements.

4.05.07 Specialized Plaster System

Specialized plaster System over 20 series masonary blockwork, Float textured finish by Specialized Systems. Min 2 coats of paint. Colour TBD. All installation in accordance with manufacturers specifications. System only for timber framed wing walls.

4.05.08 Midland NZ Brick Veneer

Midland NZ brick veneer with 50mm cavity with RAB on timber framed walls, to NZS 3604 : 2011. Provide weep holes @800mm max centres and 10mm ventilation gap between top of brick and soffit lining. Wall ties and fixings in accordance with NZS 4210 : 2001. Standard range motar, colour to match brick. The 2 storey brick

-Stria or EZ panel cladding

Cladding line to align with entry landing

Cladding line to align with bottom of deck

-Plaster over block

Entry Landing/Stairs Cladding

cladding system used on this building must be completed to 'Design Note TB1' refer to Midland Brick for Design Note TB1. Install strictly as per manufacturer's specifications and details.

4.05.09 Specialized System EZ Panel Lightweight Cladding Specialized System EZ Panel 50mm autoclaved lightweight concrete Facade System over 50x20mm High Density EPS vertical cavity battens at 600crs max. Float textured finish by Specialized Systems. Min 2 coats of paint. Colour TBD. All installation in accordance with manufacturers specifications. System only for timber framed wing walls.

4.05.22 6mm James Hardie (RAB)

6mm thick James Hardie Rigid Air Barrier RAB board fixed in accordance with manufacturer's specifications and details. Use only in areas where fire rating is required on a timber framing system inconjunction with Gib Fyreline. Refer to architectural details. Seal vertical joints with sealing tape and horizontal joints with James Hardie proprietary RAB flashings. Install strictly as per manufacturer's specifications and details. Refer to Fire report and drawings.

4.06.07 Fairview Elite Powdercoated Rebated Aluminium Sliding Doors

Elite Fairview Classic Residential 35 Powdercoated Rebated Aluminium glazed Sliding Doors with Flush track Sills. Colour as per Resource Consent specifications. Rebate 30mm deep and size must be confirmed with manufacturer prior to rebate installation. Clear double glazed with paint grade radiata pine architraves. Refer to window and door schedule. Confirm size on site prior to manufacture. Install strictly as per manufacturer's specifications and details. Hardware TBC by client.

4.07.01 R2.2 Wall Insulation

Autex Greenstuff R2.2 Wall insulation (90mm), or similar with equivalent R-value, installed as per manufacturer's specifications and instructions.

4.07.03 R1.3 Wall Insulation (Strapping)

Autex Greenstuff Masonry Blanket R1.3 / 40mm, or similar with equivalent R-value. Wall strapping insulation (45mm) installed as per manufacturer's specifications and instructions. Ensure timber strapping system as per keynote: 3.02.04 Timber Strapping

INTERIOR

5.01.01 10mm Gib Board Lining 10mm Gib Board lining fixed horizontally or vertically over selected framing. Gib stopped to level 4min. finish for painting. Square stopped to ceiling. Install strictly as per manufacturer's specifications and details. Refer to engineer drawings for bracing locations.

5.05.01 Timber Skirting


Finger jointed pine skirting, 60 x 10 single bevel pine. Paint finish. Install skirting board to overlay surface as per acoustic report. Gap to be sealed with sealant to match skirting.

GENERAL NOTES

1. Flashing materials must be selected based on environmental exposure, refer to NZS 3604 and Table 20 of NZBC clause E2/AS1. 2. Building wrap must comply with acceptable solution NZBC clause E2/AS1 and NZS 3604. 3. Flashing tape must have proven compatibility with the selected building wrap and other materials with which it comes into contact as per Table 21 of NZBC clause

E2/AS1. Refer to the manufacturer or supplier for

technical information for these these materials.

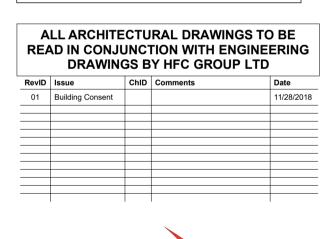



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project title: **Proposed Development for:**

Bonair Developments


153 Bonair Cresent (Block B)

Silverdale, Auckland sheet title: Cladding Base Details

drawn: KN checked: JM dwg n#: 2005 11/28/2018 date created:

2/7/2019 BC Block B rev n#: scalet:5, 1:2, 1:20 @ A1

NOTE: Drawings are ½ scale @ A3 CAD ref: KrisindaBIM Server: CAL-BIM - BIMcloud Basic for ARCHICAD 21/Creative Arch/2005_Broadway Property Group_BLOCK B_BC

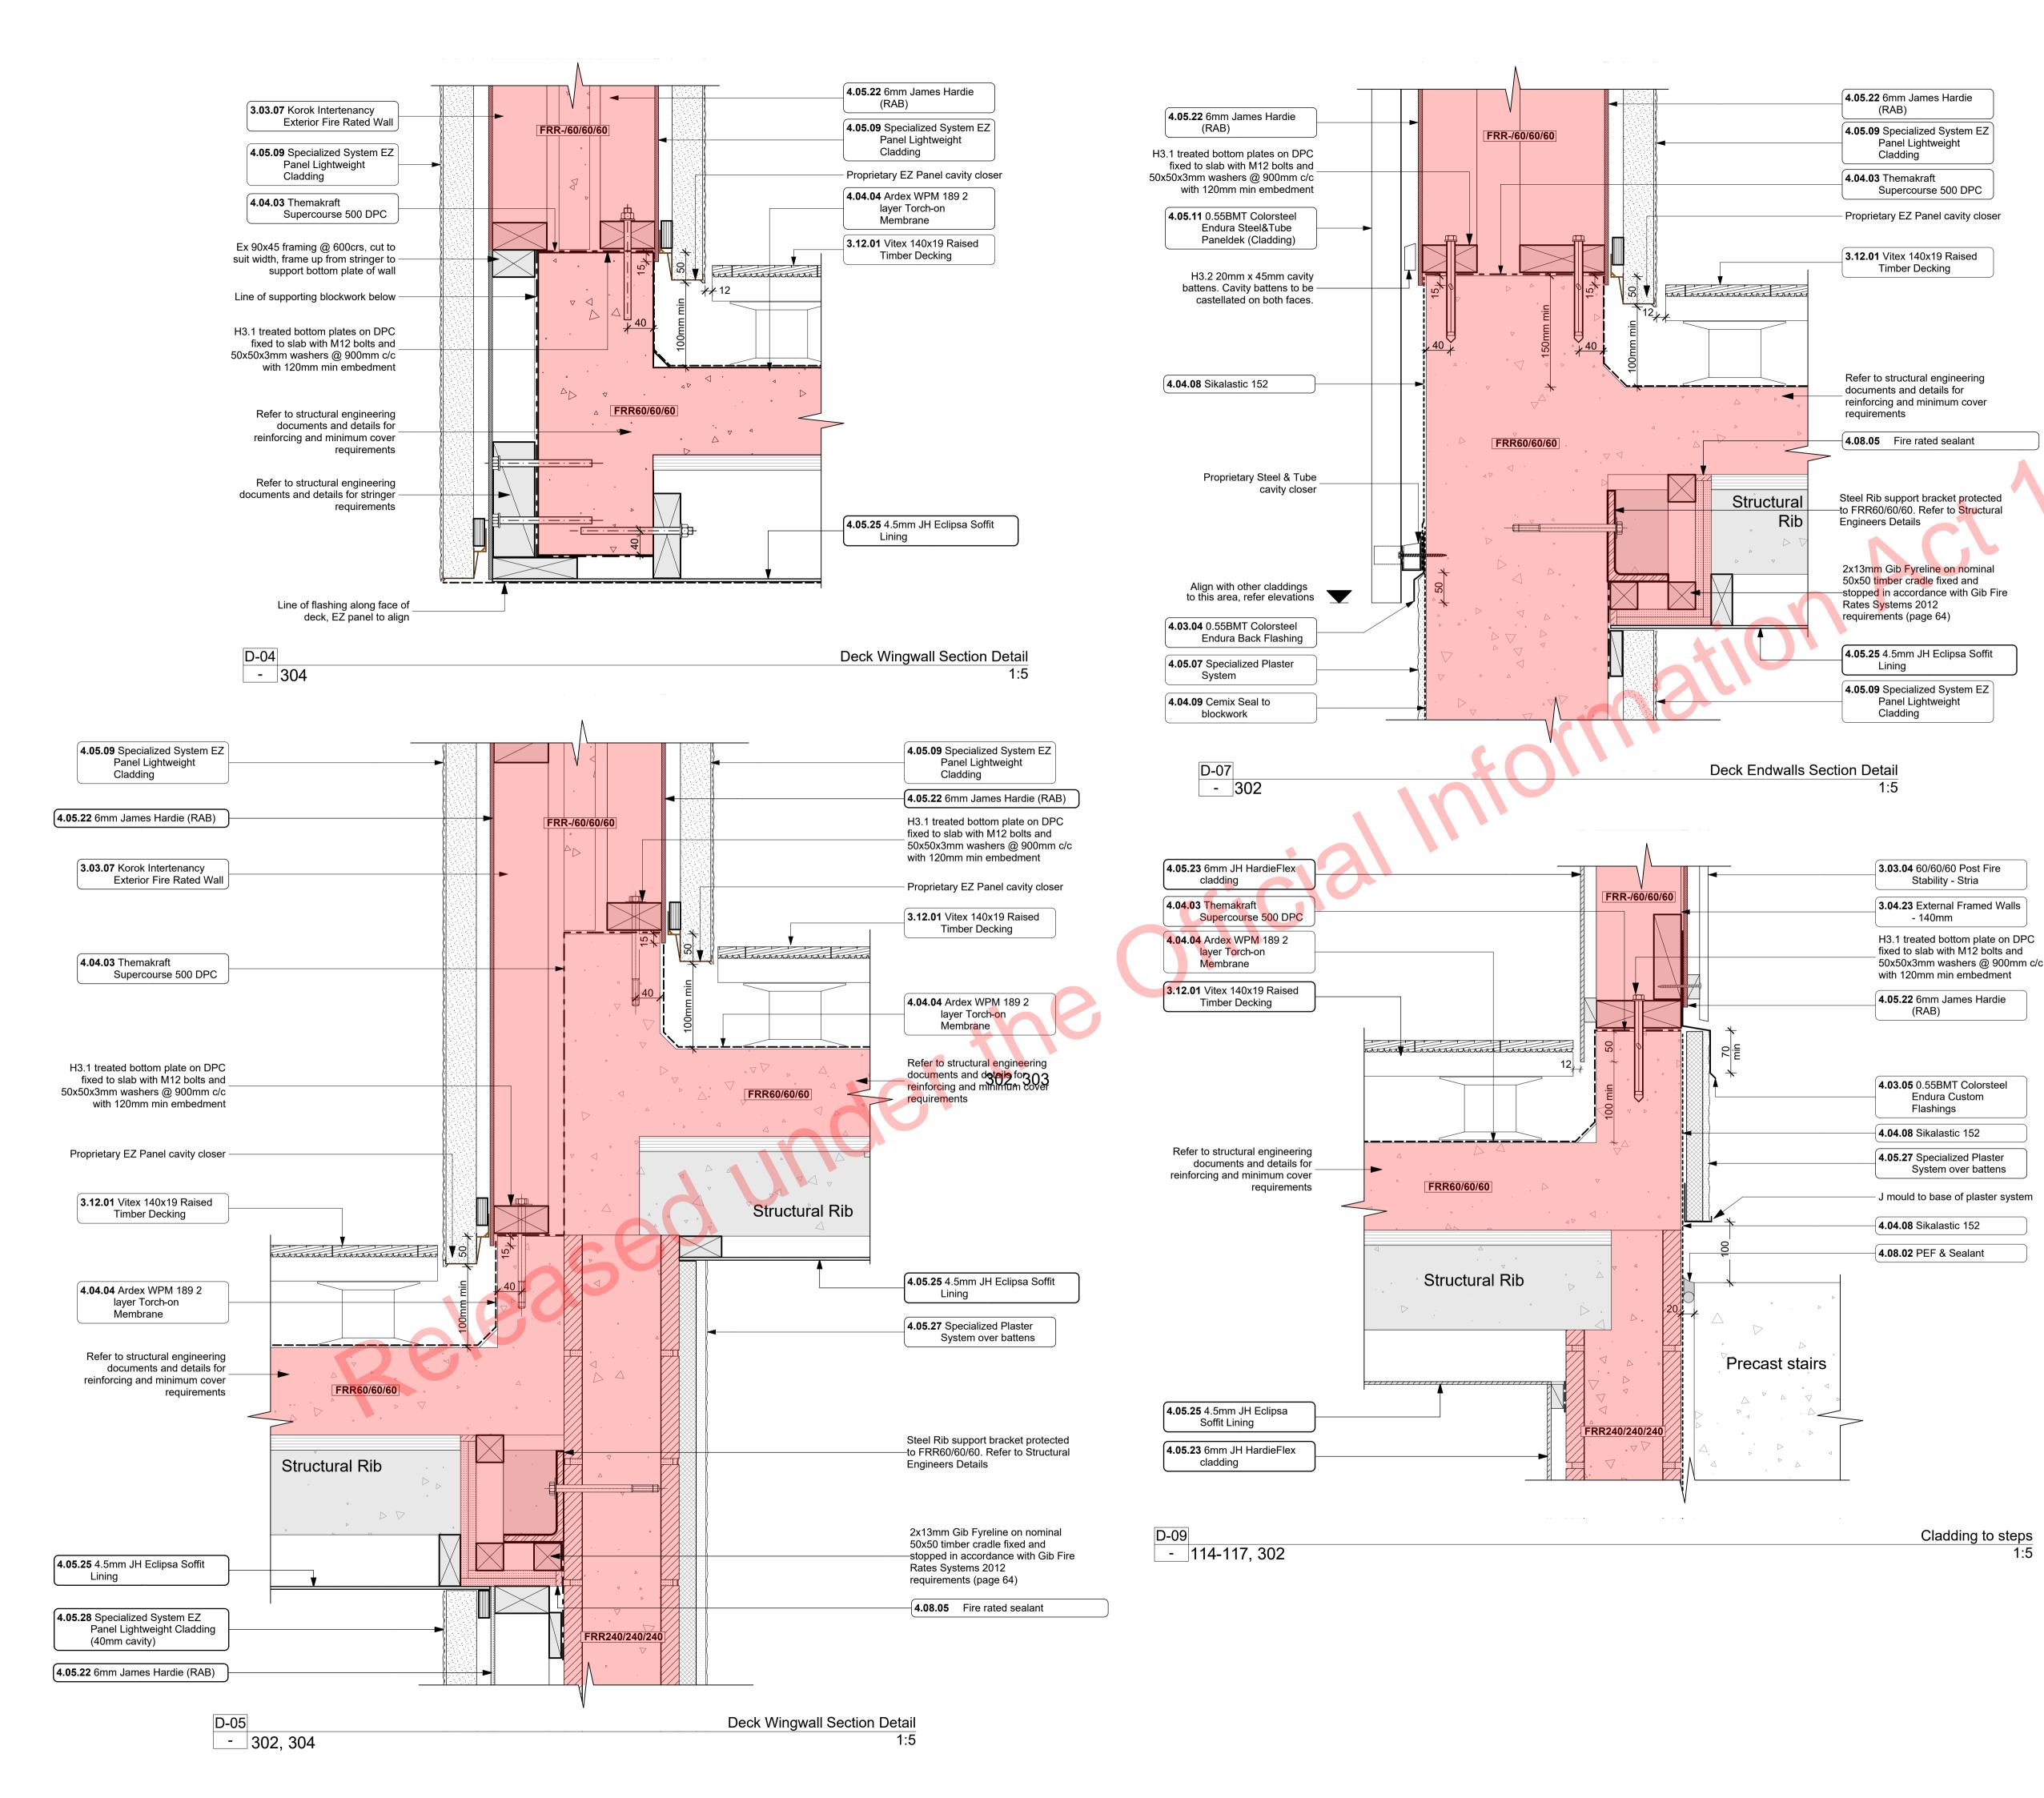

3.03.04

STRUCTURE

60/60/60 Post Fire Stability - Stria James Hardie JHETGR60a 60/60/60 Post Fire Stability Exterior Timber Framed Wall with JH Stria fibre cement cladding: 140x45 SG8 H1.2 Full Height Timber Framing. Studs at max 600 crs, Nogs at max 800 crs, James Hardie 90mm Mineral Insulation. 13mm GIB Fyreline to interior face. Stria cladding on

cavity on 6mm RAB to exterior face. 3.03.07 Korok Intertenancy Exterior Fire Rated

KOROK KIT01 -/60/60 Fire Rated Intertenancy Wall: 51mm KOROK panels with 90x45 timber framing either side - studs at max 600 crs. Min 20mm cavity to one side. Min 15 mm cavity to the other. Autex Greenstuff R2.2 Insulation both sides. Exterior cladding on cavity on 6mm James Hardie RAB to either side. Fire Rated sealant to perimeter of walls. All fixed in accordance with manufacturers requirements. External Framed Walls - 140mm Generally construct with 140x45 SG8 KD

H1.2 framing with studs on Hi and Dri packers at 600 crs and nogs @ 600crs to NZS3604.2011 unless noted otherwise. Nog for all fittings, fixtures, linings, bracing panels and trims. DPC (malthoid) between bottom plate and conc. slab and fixed with M12 bolts @ 900crs. 6mm RAB to exterior face of walls. Vitex 140x19 Raised Timber Decking Vitex 140x19 timber decking on raised

Outdure Qwickbuild aluminium. Vitex decking system to have 3mm gaps, Selected coating applied to all faces.

ENCLOSURE

0.55BMT Colorsteel Endura Back Flashing Prefinished 0.55BMT Colorsteel Endura Back Flashing purpose made flashing with turned edge to be placed behind cladding junction. Seperate all timber members to steel members with a layer of DPC. Ensure all laps & overhangs comply with E2/AS1 January 2017 Amendment 7

4.03.05 0.55BMT Colorsteel Endura Custom Prefinished 0.55BMT Endura purpose made flashings with turned edge - Ensure all laps & overhangs comply with E2/AS1 January 2017 Amendment 7. Measure and confirm all dimensions on site prior to manufacturing Seperate all timber members to steel

members with a layer of DPC. Visible flashings prefinished to matched to adjacent joinery of roofing materials Themakraft Supercourse 500 DPC Thermakraft Supercourse 500 DPC between concrete/concrete masonry /aluminium and timber members. Install strictly as per manufacturer's specifications and details.

Ardex WPM 189 2 layer Torch-on Ardex WPM 189 2 layer Torch-on Membrane installed strictly in accordance with manufacturers requirements. Dual Layer system to decks below raised decking

4.04.03

4.04.08 Sikalastic 152 Sikalastic 152 Exterior Waterproofing Membrane applied to exposed face of Slab and rebates. All in accordance with manufacturers requirements. 4.04.09 Cemix Seal to blockwork

Cemix Brick and Block Sealer Applied to

All in accordance with manufacturers

requirements.

block face prior to lining with brick cladding.

only for timber framed wing walls.

masonary blockwork, Float textured finish by Specialized Systems. Min 2 coats of paint. Colour TBD. All installation in accordance with manufacturers specifications. System Specialized System EZ Panel Lightweight

Specialized plaster System over 20 series

Specialized Plaster System

Specialized System EZ Panel 50mm autoclaved lightweight concrete Facade System over 50x20mm High Density EPS vertical cavity battens at 600crs max. Float textured finish by Specialized Systems. Min 2 coats of paint. Colour TBD. All installation in accordance with manufacturers specifications. System only for timber framed

0.55BMT Colorsteel Endura Steel&Tube Paneldek (Cladding) 0.55BMT Colorsteel Endura Steel&Tube Paneldek vertical cladding. Fix over battens to be castellated on both faces to

separation DPC over 20x45 H3.2 horizontal timber cavity battens at max 600crs. Cavity provide drainage and ventilation and must be used horizontally only. Fix cladding with S&T concealed fixing clip. Install strictly as per manufacturer's specifications and details. 6mm James Hardie (RAB)

6mm thick James Hardie Rigid Air Barrier RAB board fixed in accordance with manufacturer's specifications and details. Use only in areas where fire rating is required on a timber framing system inconjunction with Gib Fyreline. Refer to architectural details. Seal vertical joints with sealing tape and horizontal joints with James Hardie proprietary RAB flashings. Install strictly as per manufacturer's specifications and details. Refer to Fire report and drawings.

6mm JH HardieFlex cladding 6mm thick James Hardie Hardieflex Fibre 4.05.23 Cement cladding over 45x20 H3.2 vertical cavity battens at max 600 cr Install strictly as per manufacturer's specifications and details.

4.05.25 4.5mm JH Eclipsa Soffit Lining 4.5mm James Hardie Eclipsa soffit lining on 45 x 90 (unless specifically sized for specific depth. Refer to architectural details) H1.2 timber framing @ max 600mm crs. Paint finish with uPVC jointers @600crs. Install strictly as per manufacturer's specifications

and details.

Specialized Plaster System over battens Specialized plaster System over 30mm High Density EPS, Float textured finish by Specialized Systems. Min 2 coats of paint. Colour TBD. All installation in accordance with manufacturers specifications. System

System over 40mm High Density EPS vertical cavity battens at 600crs max. Float textured


finish by Specialized Systems. Min 2 coats of

only for timber framed wing walls. 4.05.28 Specialized System EZ Panel Lightweight Cladding (40mm cavity) Specialized System EZ Panel 50mm autoclaved lightweight concrete Facade

paint. Colour TBD. All installation in accordance with manufacturers specifications. System only for timber framed wing walls. 4.08.02 PEF & Sealant

PEF Backing rod and Sealant. Ensure all laps and overhangs comply with E2/AS1. Install strictly as per manufacturer's specifications Fire rated sealant

Approved fire rated sealant to all penetrations and connections as per details. Install strictly as per manufacturer's specifications and

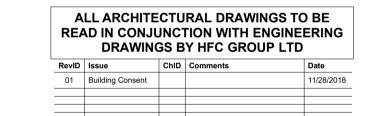



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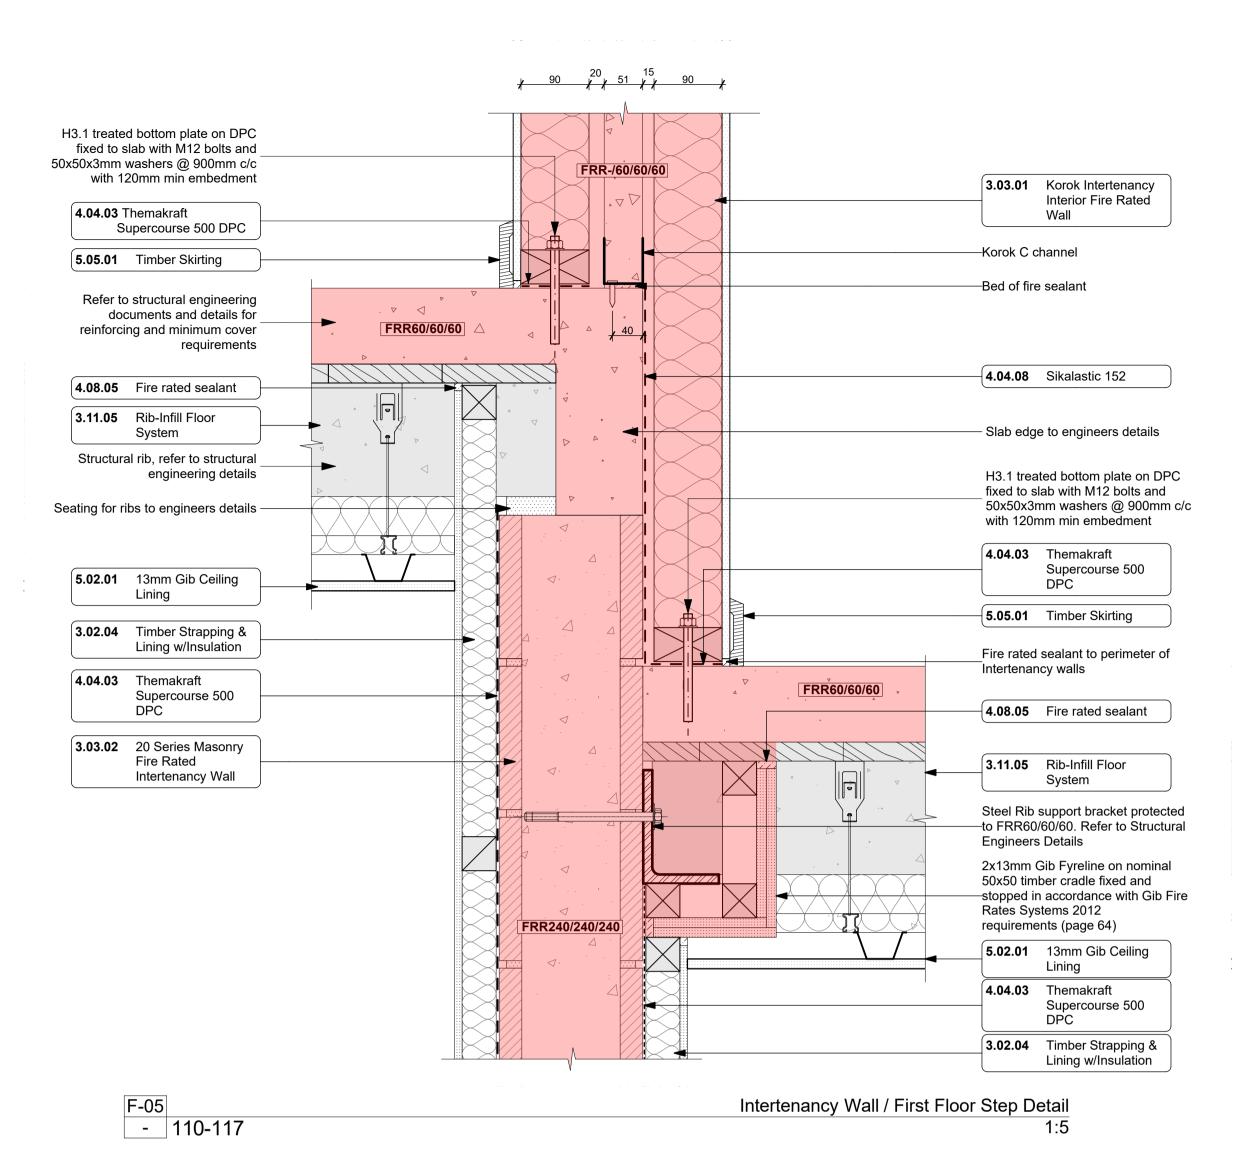
Bonair Developments

153 Bonair Cresent (Block B) Silverdale, Auckland sheet title:

MidFloor Slab Details drawn: KN checked: JM dwg n#: date created:

2005 11/28/2018 2/7/2019 BC Block B rev n#:

1:5 @ A1 NOTE: Drawings are ½ scale @ A3 CAD ref: KrisindaBIM Server: CAL-BIM - BIMCloud Basic for ARCHICAD 21/Creative Arch/2005_Broadway Property Group_BLOCK B_BC



DROP IN FIRE COLLAR TEST RESULTS:


Tested on a trapezoidal steel tray concrete floor with 70mm minimum thickness and 130mm maximum thickness.

NOMINAL PIPE SIZE (MM)	NOMINAL PIPE WALL THICKNESS (MM)	PRODUCT CODE	PENETRATION HOLE SIZE (MM)	FLOOR FRL*	FTC#
PVC PLASTIC PIPE					
40	2.0	DIFC40	72	-/90/60	728
50	2.2	DIFC50	82	-/90/90	728
65	2.7	DIFC65	102	-/90/90	728
80	2.9	DIFC80	112	-/90/90	728
100	3.2	DIFC100	142	-/90/60	728
150	4.5	DIFC150	192	-/90/90	728
PVC PIPE SOCKET	CONNECTIONS				
40	4.0	DIFC40	72	-/90/60	728
100	6.4	DIFC100	142	-/90/90	728
HDPE					
150	7.0	DIFC150	192	-/90/90	728


INSTALLATION


- **INSTRUCTIONS:**
- 1. Core drill hole to specified diameter to suit pipe size.
- 2. Install drop in fire collar fixing with two M5x22mm metal pin anchors.
- 3. Insert pipework through collar.
- 4. Seal gaps between concrete/ collar and collar/pipe with
- Allproof intumescent sealant.



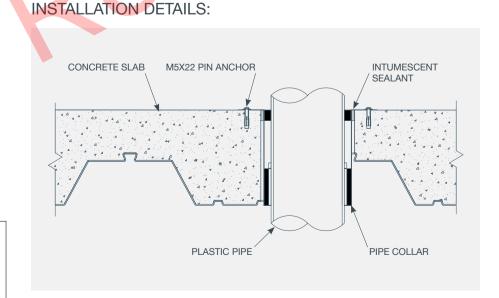

AllProof Drop In Fire Collar Details

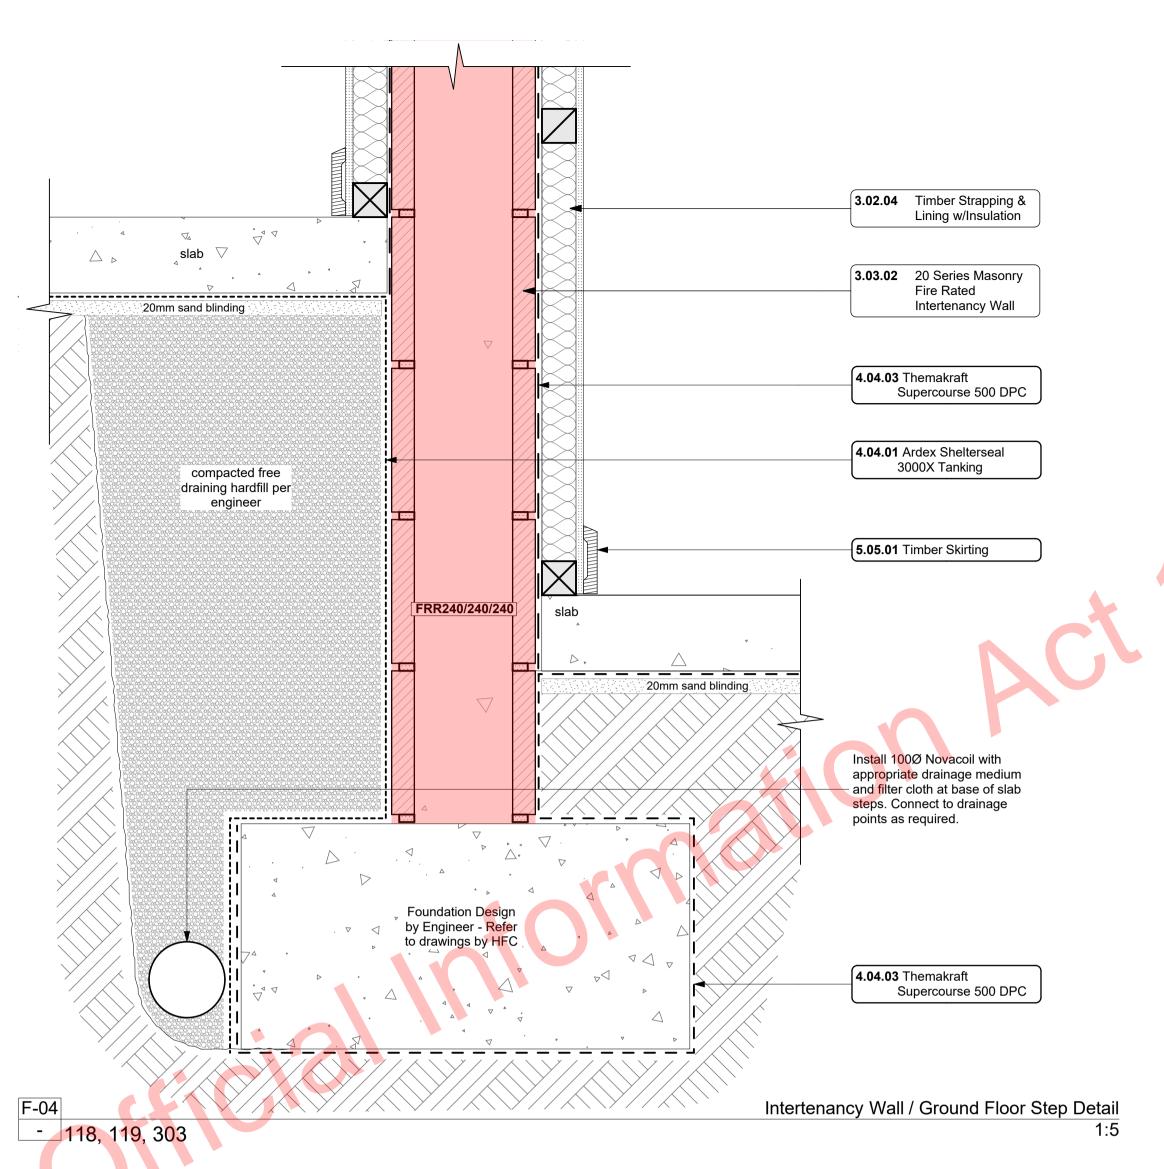

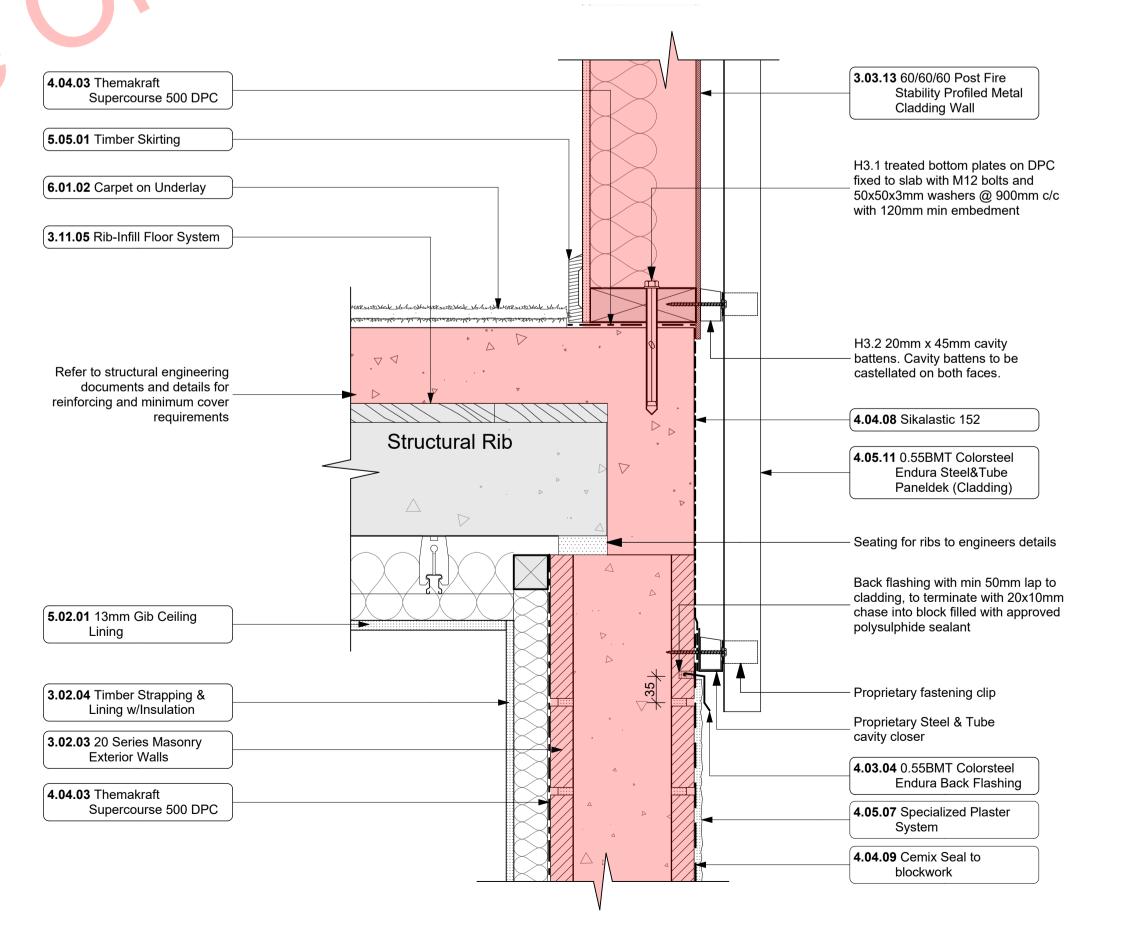

___114, 117, 120, 121, 303

Metal Cladding/Masonry Wall Horizontal Junction Detail

1:5

Notes

STRUCTURE 20 Series Masonry Exterior Walls 190mm Exterior masonry walls with Solid plaster finish to exterior, refer to engineering for reinforcing

requirements, Constructed in accordance with NZS4210, refer to

specific notes for strapping and lining requirements. FRR240/240/240 Timber Strapping & Lining 3.02.04 Masonry block wall to be strapped with 50x50mm H1.2 battens on dpc at

600crs with Audex Greenstuff R1.3 40mm fibreglass insulation installed between with 10mm Gib board lining. Korok Intertenancy Interior Fire 3.03.01

Rated Wall KOROK KIT01 -/60/60 Fire Rated Intertenancy Wall: 51mm KOROK panels with 90x45 timber framing either side - studs at max 600 crs. 20mm cavity to one side. 15 mm cavity to the other. Audex Greenstuff R2.2 Insulation both sides. 10mm Gib Standard Plasterboard either side. Use 6mm RAB in lieu of Gib in ceiling cavity. Fire Rated sealant to perimeter of walls. All fixed in accordance with manufacturers requirements 5216S

3.03.02 20 Series Masonry Fire Rated Intertenancy Wall FRR240/240/240 - 190 mm thick Fire Rated intertenancy wall. Installed to Structural Engineers Details. 10mm Paint Finish Gib on 50x50mm H1.2 timber strapping with R1.3 Insulation to either side. Fire Rated sealant to

60/60/60 Post Fire Stability Profiled Metal Cladding Wall James Hardie JHETGR60a 60/60/60 Post Fire Stability Exterior Timber Framed Wall with Profiled Metal Cladding: 140x45 SG8 H1.2 Full Height Timber Framing. Studs at max 600 crs, Nogs at max 800 crs, James Hardie 90mm Mineral Insulation. 13mm Gib Fyreline to min 800 AFFL. 13mm Standard Gib above to interior face. Profiled Metal cladding on cavity on 6mm RAB to exterior face.

Rib-Infill Floor System Rib and Infill floor slab as designed and detailed by structural engineer. 150 Rib + 25 infill + 100 topping. Refer to structural engineer's plans for structural layout & reinforcing. Refer to architectural plan for recesses, dimensions and levels only. 3155FR

ENCLOSURE

4.03.04 0.55BMT Colorsteel Endura Back Flashing
Prefinished 0.55BMT Colorsteel Endura Back Flashing purpose made flashing with turned edge to be placed behind cladding junction. Seperate all

timber members to steel members

overhangs comply with E2/AS1 January 2017 Amendment 7

with a layer of DPC. Ensure all laps &

FINISH Carpet on Underlay

/aluminium and timber members. Install strictly as per manufacturer's specifications and details. Sikalastic 152

Themakraft Supercourse 500 DPC

Thermakraft Supercourse 500 DPC

between concrete/concrete masonry

Sikalastic 152 Exterior Waterproofing Membrane applied to exposed face of Slab and rebates. All in accordance

with manufacturers requirements. Cemix Seal to blockwork Cemix Brick and Block Sealer Applied to block face prior to lining with brick cladding. All in accordance with

Specialized Plaster System Specialized plaster System over 20 series masonary blockwork, Float textured finish by Specialized Systems. Min 2 coats of paint. Colour TBD. All installation in accordance with manufacturers specifications.

manufacturers requirements.

System only for timber framed wing 0.55BMT Colorsteel Endura Steel&Tube Paneldek (Cladding) 0.55BMT Colorsteel Endura Steel&Tube Paneldek vertical cladding. Fix over separation DPC over 20x45 H3.2 horizontal timber cavity battens at max 600crs. Cavity

battens to be castellated on both faces to provide drainage and ventilation and must be used horizontally only. Fix cladding with S&T concealed fixing clip. Install strictly as per manufacturer's specifications and


Fire rated sealant Approved fire rated sealant to all penetrations and connections as per details. Install strictly as per manufacturer's specifications and details.

INTERIOR

13mm Gib Ceiling Lining 13mm Gib Ceiling lining fixed to Suspended Rondo or DONN metal grid system @ 600crs. Gib stopped to level 4, finish for painting. Square stopped at wall. Install strictly as per manufacturer's specifications and

Timber Skirting Finger jointed pine skirting, 60 x 10 single bevel pine. Paint finish. Install skirting board to overlay surface as per acoustic report. Gap to be sealed with sealant to match skirting.

Selected carpet over underlay installed as per manufacturer's specification. Selection TBC by client.

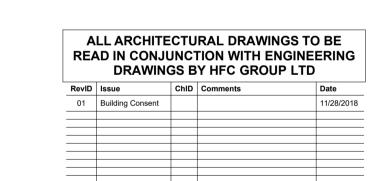



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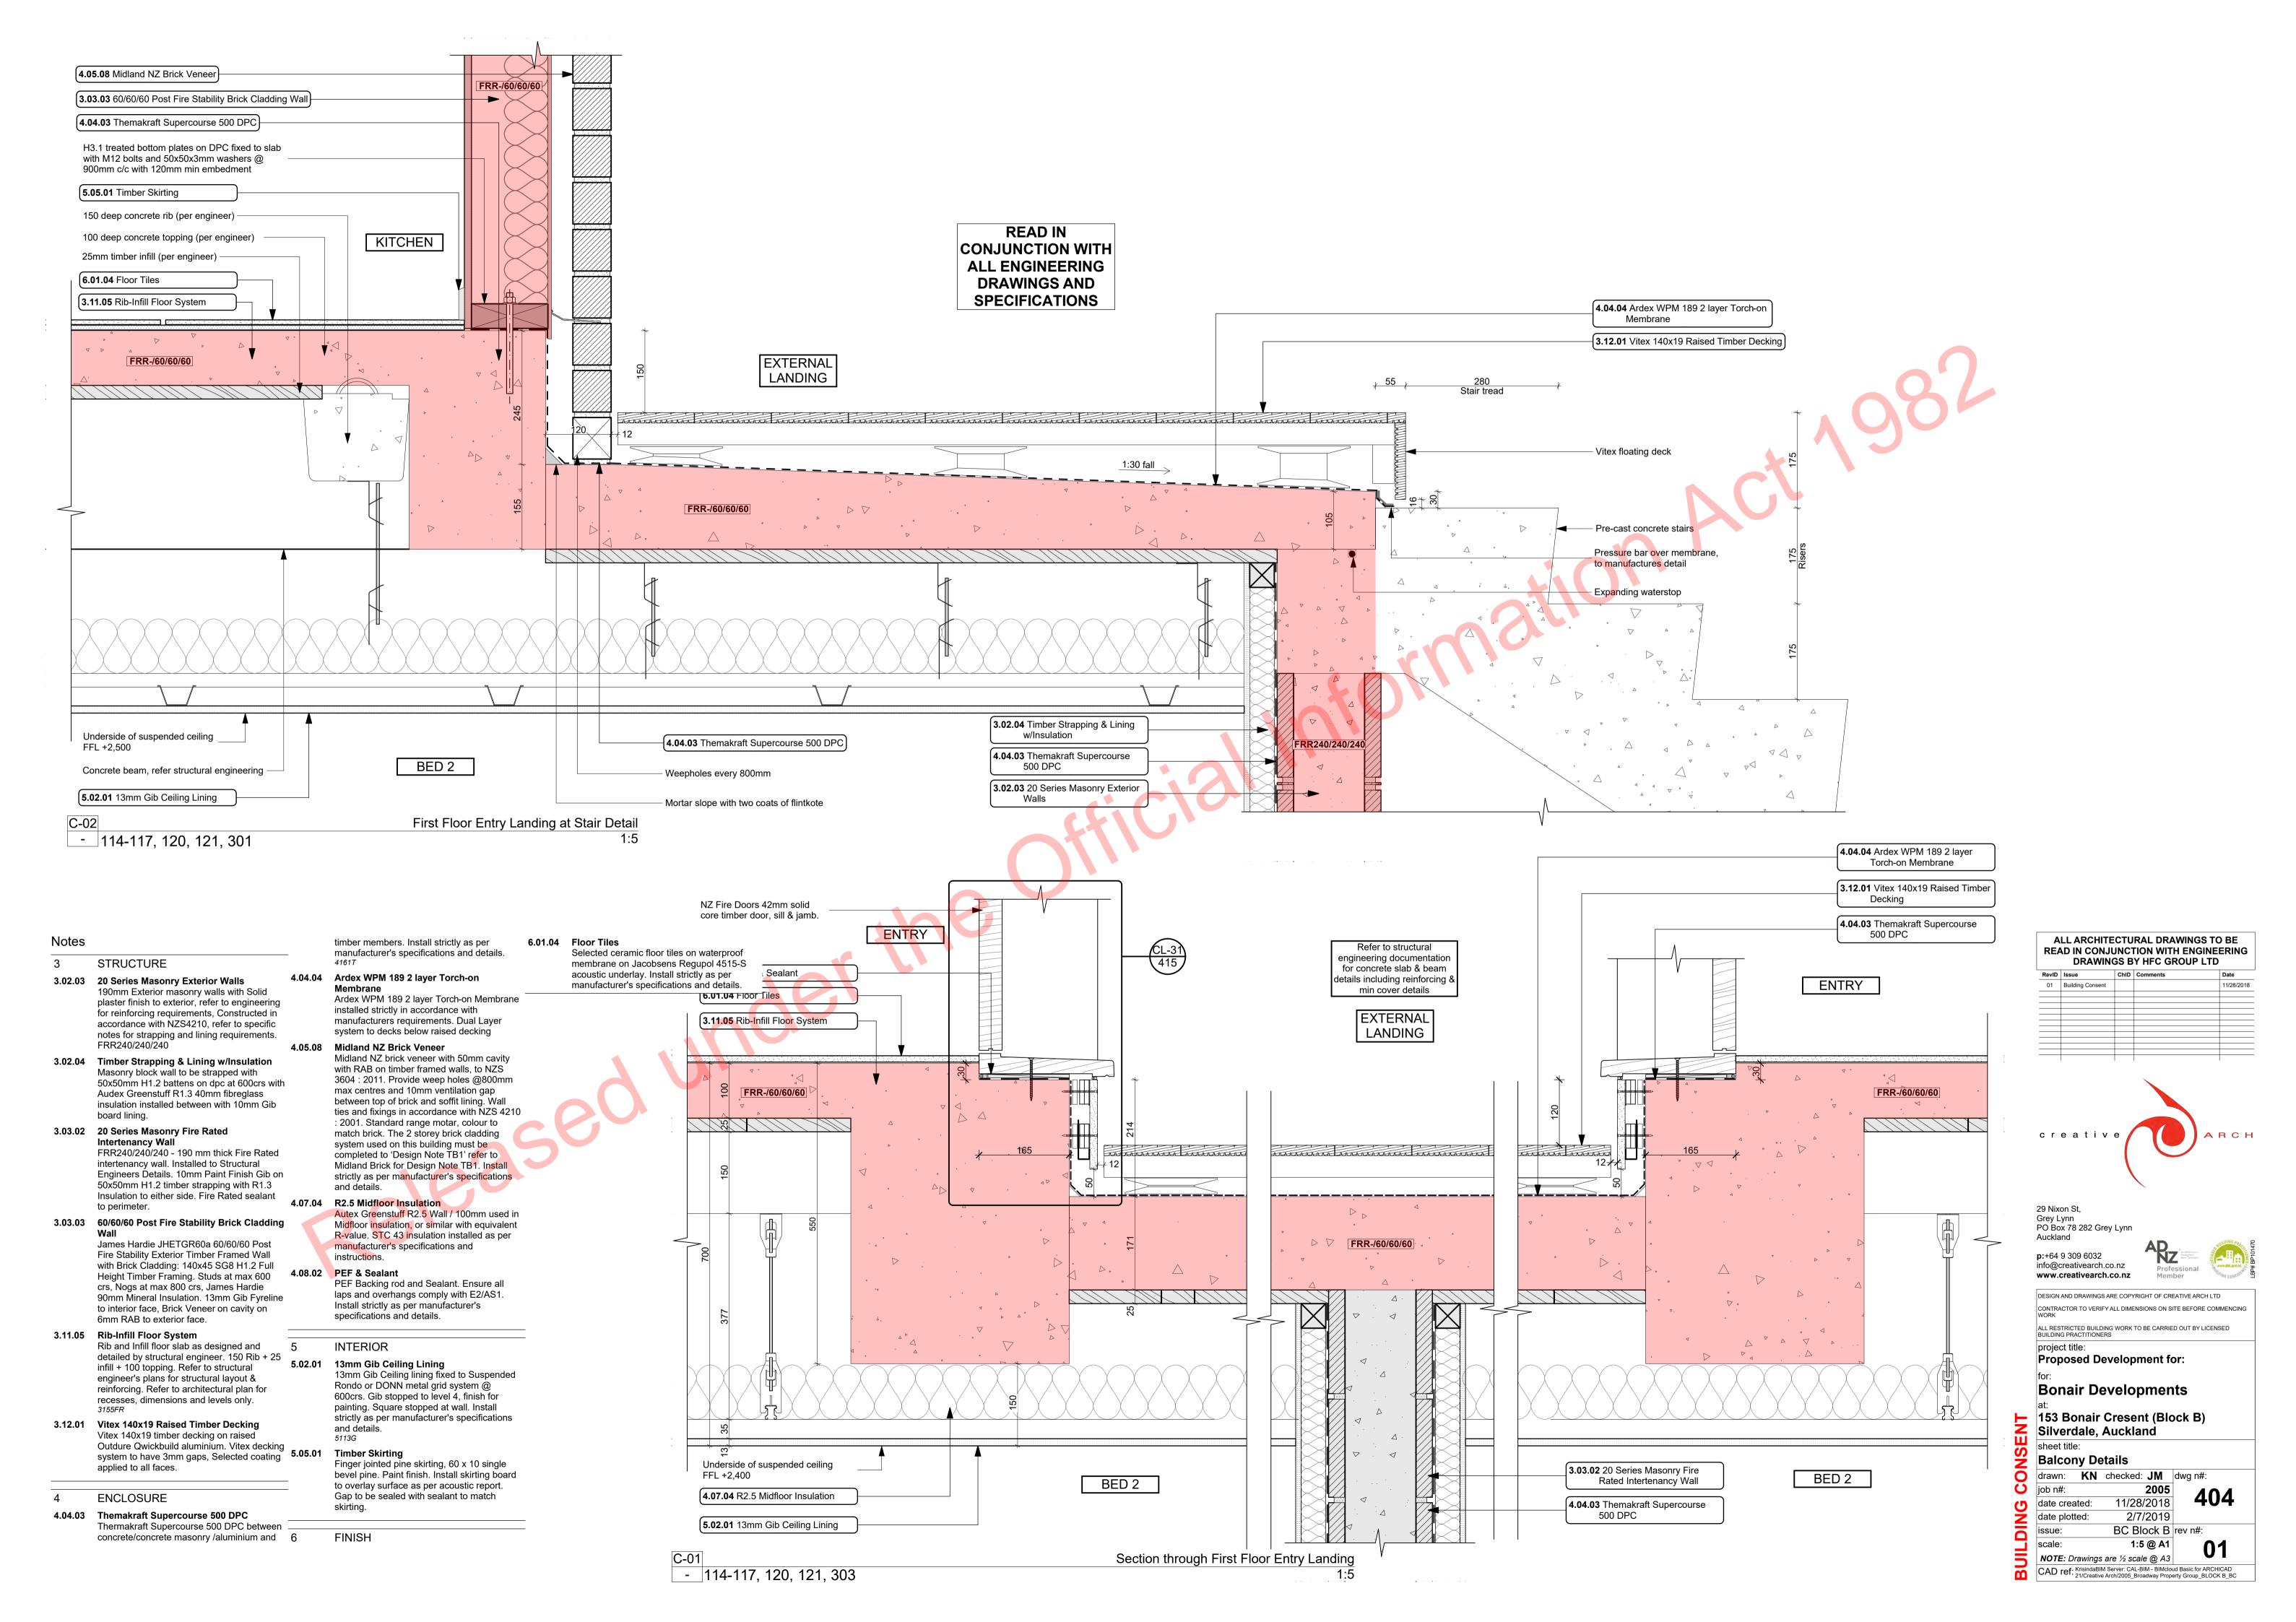
Bonair Developments


 153 Bonair Cresent (Block B) Silverdale, Auckland sheet title:

MidFloor Slab Details drawn: KN checked: JM dwg n#: 2005 11/28/2018 date created:

2/7/2019 BC Block B rev n#: 1:5, 1:1 @ A1

NOTE: Drawings are ½ scale @ A3 CAD ref: KrisindaBIM Server: CAL-BIM - BIMcloud Basic for ARCHICAD 21/Creative Arch/2005_Broadway Property Group_BLOCK B_BC



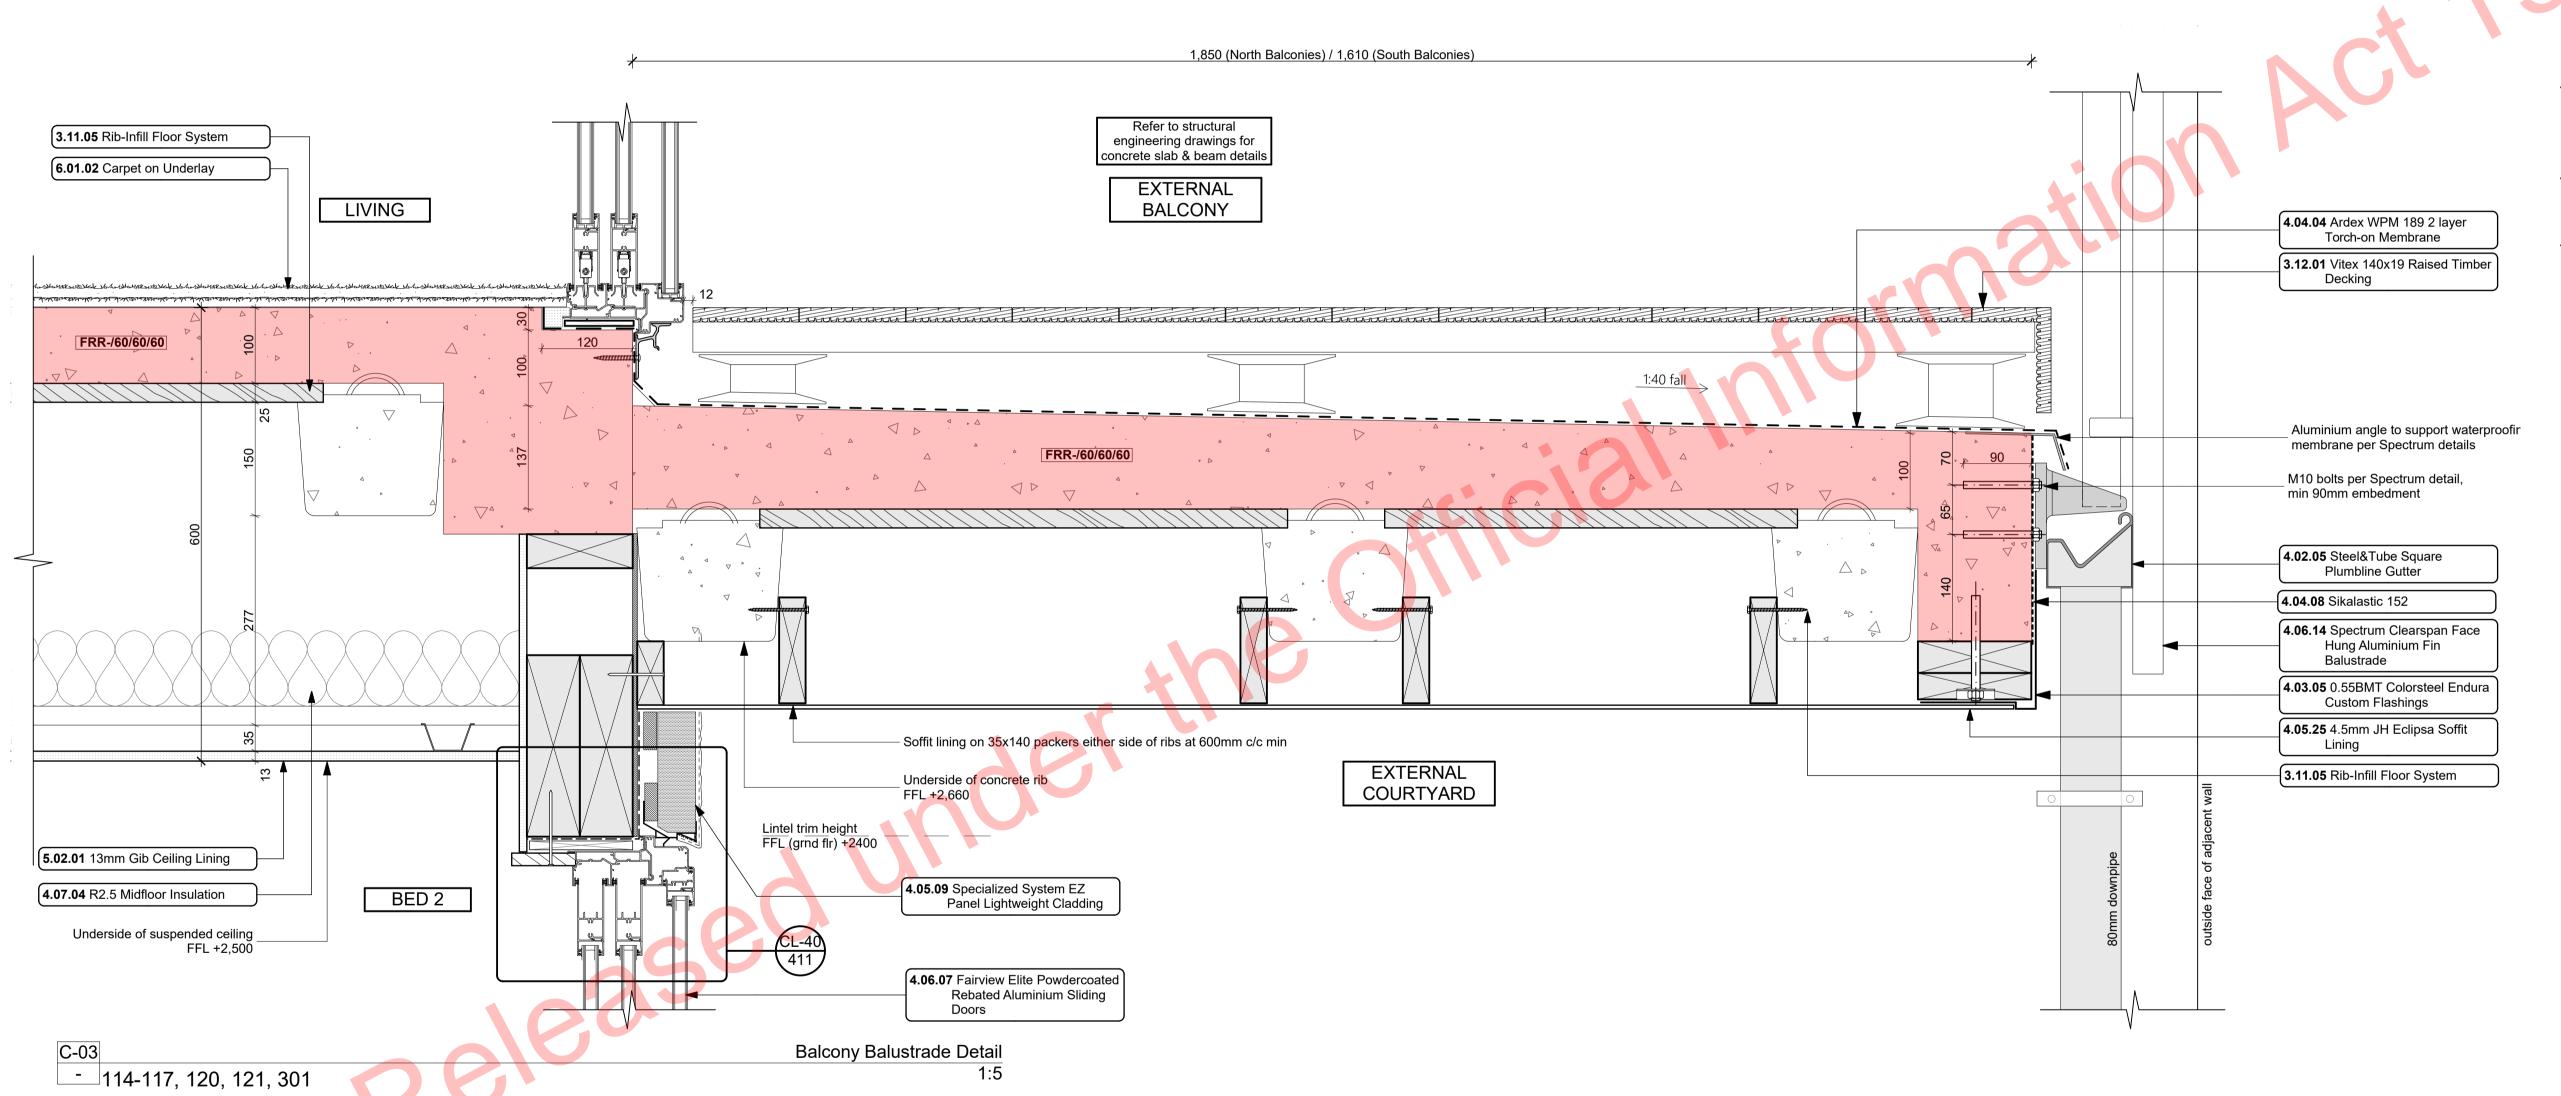

STRUCTURE

Rib-Infill Floor System Rib and Infill floor slab as designed and detailed by structural engineer. 150 Rib + 25 infill + 100 topping. Refer

to structural engineer's plans for structural layout & reinforcing. Refer to architectural plan for recesses, dimensions and levels only. Vitex 140x19 Raised Timber

3.12.01 Vitex 140x19 timber decking on raised Outdure Qwickbuild aluminium. Vitex decking system to have 3mm gaps, Selected coating applied to all faces.

ENCLOSURE

4.02.05 Steel&Tube Square Plumbline

Steel&Tube Square Plumbline Coloursteel Endura Gutter on internal brackets [as per manufacturers specification] on steel fascia. Install strictly as per manufacturer's specifications and details. Brackets and gutter to be finished to match 7411M

4.03.05 0.55BMT Colorsteel Endura Custom

Prefinished 0.55BMT Endura purpose made flashings with turned edge -Ensure all laps & overhangs comply with E2/AS1 January 2017 Amendment 7. Measure and confirm all dimensions on site prior to manufacturing. Seperate all timber members to steel members with a layer of DPC. Visible flashings prefinished to matched to adjacent joinery of roofing materials

Ardex WPM 189 2 layer Torch-on Membrane Ardex WPM 189 2 layer Torch-on Membrane installed strictly in

accordance with manufacturers requirements. Dual Layer system to decks below raised decking

Sikalastic 152

Sikalastic 152 Exterior Waterproofing Membrane applied to exposed face of Slab and rebates. All in accordance with manufacturers requirements. Specialized System EZ Panel

Lightweight Cladding Specialized System EZ Panel 50mm autoclaved lightweight concrete Facade System over 50x20mm High Density EPS vertical cavity battens at 600crs max. Float textured finish by

paint. Colour TBD. All installation in accordance with manufacturers specifications. System only for timber

framed wing walls. **4.5mm JH Eclipsa Soffit Lining**4.5mm James Hardie Eclipsa soffit lining on 45 x 90 (unless specifically sized for specific depth. Refer to architectural details) H1.2 timber

framing @ max 600mm crs. Paint finish with uPVC jointers @600crs. Install strictly as per manufacturer's specifications and details.

Specialized Systems. Min 2 coats of

Fairview Elite Powdercoated **Rebated Aluminium Sliding Doors** Elite Fairview Classic Residential 35 Powdercoated Rebated Aluminium glazed Sliding Doors with Flush track Sills. Colour as per Resource Consent specifications. Rebate 30mm deep and size must be confirmed with manufacturer prior to rebate installation. Clear double glazed with paint grade radiata pine architraves. Refer to window and door schedule. Confirm size on site prior to manufacture. Install strictly as per manufacturer's specifications and details. Hardware TBC by client.

Spectrum Clearspan Face Hung Aluminium Fin Balustrade Spectrum Clearspan Face Hung Aluminium Fin Balustrade on Castaway bracket. 40x20 Balusters to 1000 AFFL. No Handrail. Powdercoated finish to match joinery. Install strictly as per manufacturer's specifications and details.

R2.5 Midfloor Insulation Autex Greenstuff R2.5 Wall / 100mm used in Midfloor insulation, or similar with equivalent R-value. STC 43 insulation installed as per manufacturer's specifications and instructions.


INTERIOR

13mm Gib Ceiling Lining 13mm Gib Ceiling lining fixed to Suspended Rondo or DONN metal grid system @ 600crs. Gib stopped to level 4, finish for painting. Square stopped at wall. Install strictly as per manufacturer's specifications and details. *5113G*

FINISH

6.01.02 Carpet on Underlay Selected carpet over underlay installed as per manufacturer's specification. Selection TBC by client.

ALL ARCHITECTURAL DRAWINGS TO BE READ IN CONJUNCTION WITH ENGINEERING DRAWINGS BY HFC GROUP LTD

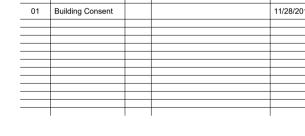



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Proposed Development for:

Bonair Developments


153 Bonair Cresent (Block B)
Silverdale, Auckland sheet title:


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drawn: KN checked: JM dwg n#: 11/28/2018 2/7/2019

BC Block B rev n#: 1:5 @ A1


NOTE: Drawings are ½ scale @ A3 CAD ref. KrisindaBIM Server: CAL-BIM - BIMCloud Basic for ARCHICAD 21/Creative Arch/2005_Broadway Property Group_BLOCK B_BC



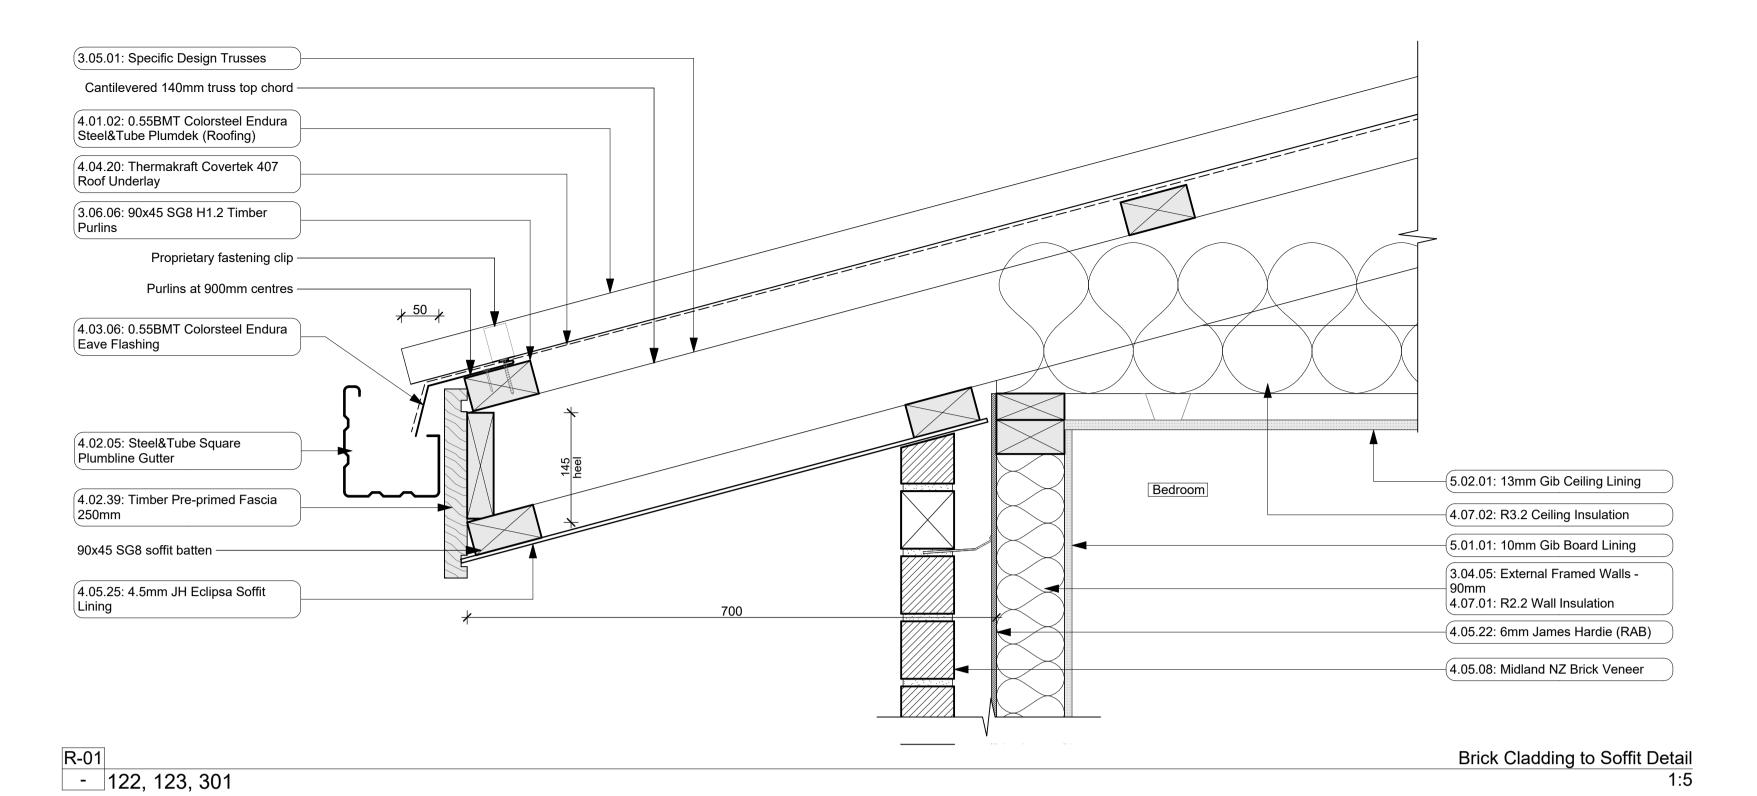

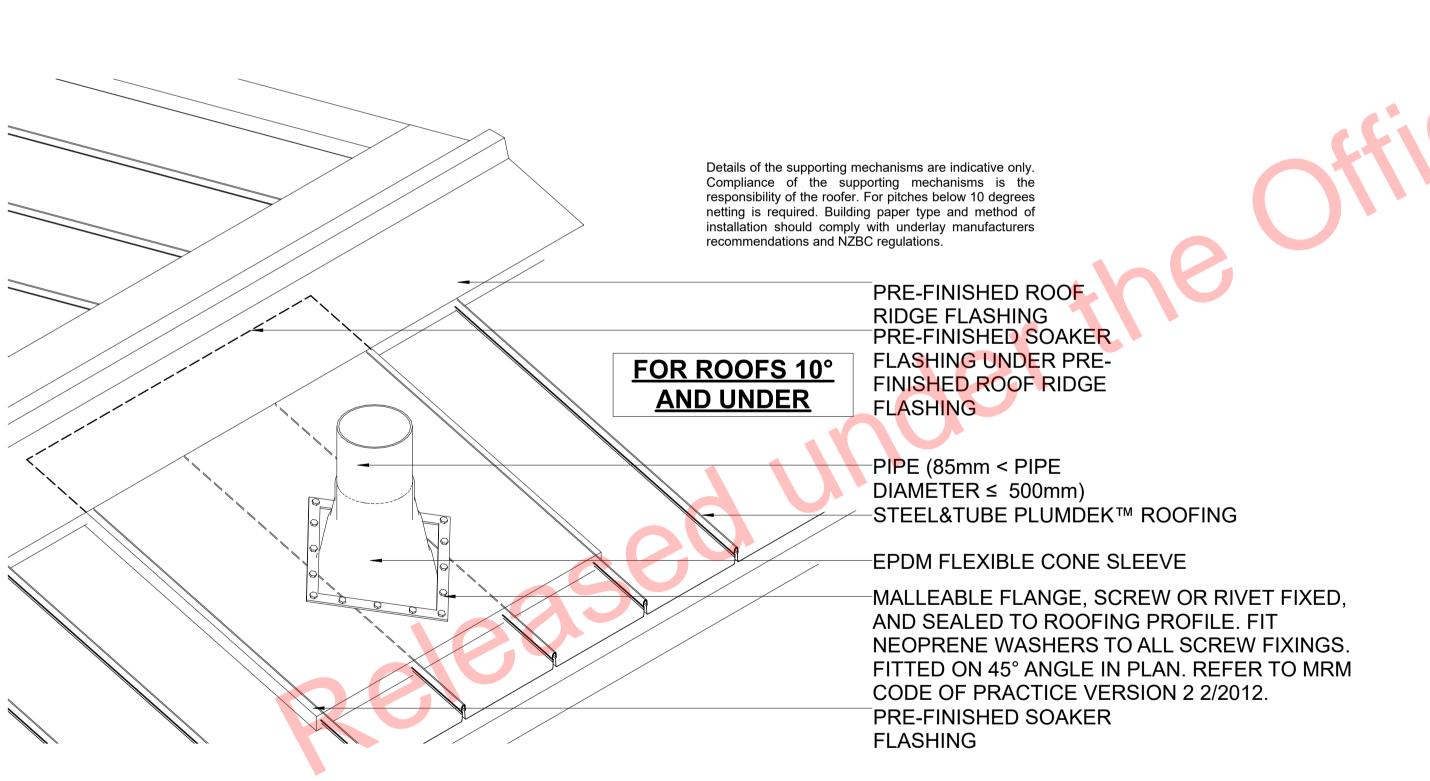- 124, 125

Roof Penetration Detail 1:10

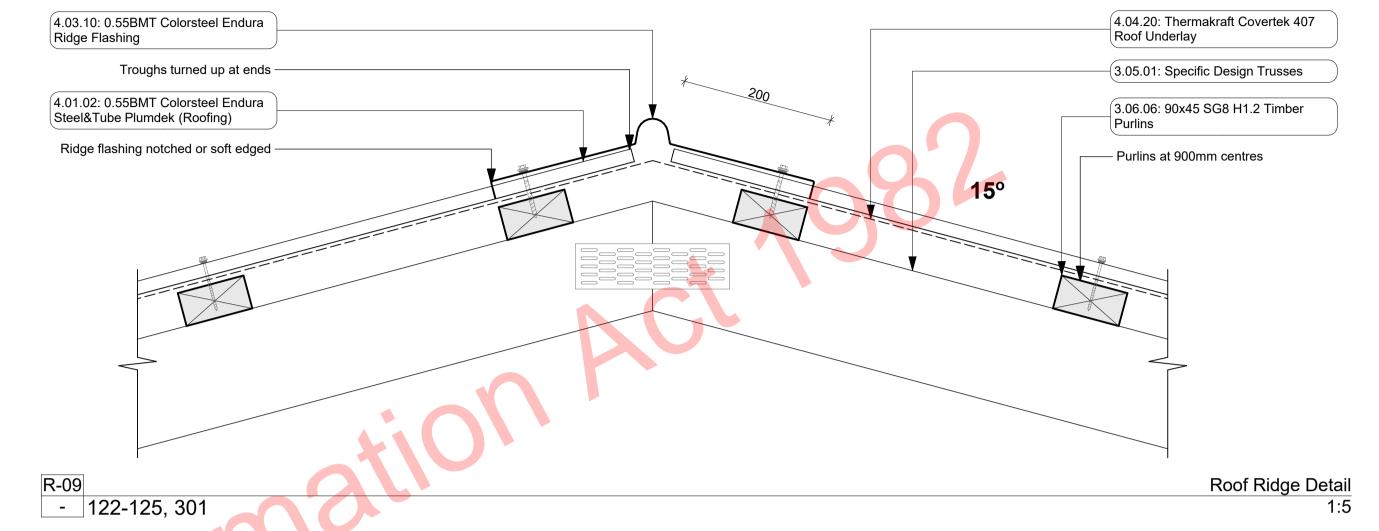

STRUCTURE

3.04.05 External Framed Walls - 90mm

Generally construct with 90x45 SG8 KD H1.2 framing with studs on Hi and Dri packers at crs as per setout plans and nogs @ 600crs to NZS3604.2011 unless noted otherwise. Ensure all insulation within framing where applicable, is secured into place with DanBand straps in accordance with the requirements of E2/AS1. Nog for all fittings, fixtures, linings, bracing panels and trims. DPC (malthoid) between bottom plate and conc. slab and fixed with M12 bolts @ 900crs. Refer to the Structural Layouts for the bracing requirements. 6mm RAB to exterior face of walls.

3.05.01 Specific Design Trusses

Specific design trusses @ centres and fixings as noted on the truss manufacturer plans and specifications. Truss treatment to be H1.2 minimum, unless noted otherwise. Refer to manufacturers truss design for details. Trusses shown on architectural are indicative only. all truss information is to be referred to truss manufacturer documents. Building Contractor to ensure all heel heights and roof steps are correct.

3.06.06 90x45 SG8 H1.2 Timber Purlins

90x45 SG8 H1.2 treated purlins @ 900mm crs to roof areas, fixed to framing with 1/10g self drilling screw 80mm long fixing as per NZS 3604.

ENCLOSURE

4.01.02 0.55BMT Colorsteel Endura Steel&Tube Plumdek (Roofing) 0.55BMT Colorsteel Endura Steel&Tube Plumdek roofing system on roofing underlay on 90x45 battens at max 900 crs at pitch as per roof plans, sections and elevations. Install strictly as per manufacturer's specifications and details.

4.02.05 Steel&Tube Square Plumbline Gutter

Steel&Tube Square Plumbline Coloursteel Endura Gutter on internal brackets [as per manufacturers specification] on steel fascia. Install strictly as per manufacturer's specifications and details. Brackets and gutter to be finished to match roofing.

4.02.39 Timber Pre-primed Fascia 250mm 25mm x250mm Pre-primed paint finish Fascia finished to match

roofing. Install strictly as per manufacturer's specifications and details. Refer details for height. 4.03.06 0.55BMT Colorsteel Endura Eave Flashing

0.55BMT Colorsteel Endura Eave Flashing purpose made to

match roofing pitch and profile as per E2/AS1 for roof pitches less than 10deg. Installed in accordance with E2/AS1. Turn-down lowend terminations to form drip edge. Seperate all timber members to steel members with a layer of DPC. Prefinished to match roofing.

4.03.10 0.55BMT Colorsteel Endura Ridge Flashing

0.55BMT Colorsteel Endura Ridge Flashing purpose made to match roofing pitch and profile. Ensure flashing cover over roof cladding to be min. 200mm. Flashing edge notched to fit over roofing profile. Seperate all timber members to steel members with a layer of DPC. Prefinished to match roofing.

4.04.20 Thermakraft Covertek 407 Roof Underlay

Thermakraft Covertek 407 self supporting roof underlay fixed over purlins. Install strictly as per manufacturer's specifications and details. Where roof pitches require, ensure support mesh is installed in conjunction with roofing paper.

4.05.08 Midland NZ Brick Veneer

Midland NZ brick veneer with 50mm cavity with RAB on timber framed walls, to NZS 3604 : 2011. Provide weep holes @800mm max centres and 10mm ventilation gap between top of brick and soffit lining. Wall ties and fixings in accordance with NZS 4210: 2001. Standard range motar, colour to match brick. The 2 storey brick cladding system used on this building must be completed to 'Design Note TB1' refer to Midland Brick for Design Note TB1. Install strictly as per manufacturer's specifications and details.

4.05.22 6mm James Hardie (RAB)

6mm thick James Hardie Rigid Air Barrier RAB board fixed in accordance with manufacturer's specifications and details. Use only in areas where fire rating is required on a timber framing system inconjunction with Gib Fyreline. Refer to architectural details. Seal vertical joints with sealing tape and horizontal joints with James Hardie proprietary RAB flashings. Install strictly as per manufacturer's specifications and details. Refer to Fire report and

4.05.25 4.5mm JH Eclipsa Soffit Lining

4.5mm James Hardie Eclipsa soffit lining on 45 x 90 (unless specifically sized for specific depth. Refer to architectural details) H1.2 timber framing @ max 600mm crs. Paint finish with uPVC jointers @600crs. Install strictly as per manufacturer's specifications and details.

4.07.01 R2.2 Wall Insulation

Autex Greenstuff R2.2 Wall insulation (90mm), or similar with equivalent R-value, installed as per manufacturer's specifications and instructions.

4.07.02 R3.2 Ceiling Insulation

Autex Greenstuff R3.2 ceiling insulation (200mm), or similar with equivalent R-value, installed as per manufacturer's specifications and instructions. Ensure 25mm clearance between top of insulation and underside of roofing.

INTERIOR

5.01.01 10mm Gib Board Lining

10mm Gib Board lining fixed horizontally or vertically over selected framing. Gib stopped to level 4min. finish for painting. Square stopped to ceiling. Install strictly as per manufacturer's specifications and details. Refer to engineer drawings for bracing locations. 5113G

5.02.01 13mm Gib Ceiling Lining

13mm Gib Ceiling lining fixed to Suspended Rondo or DONN metal grid system @ 600crs. Gib stopped to level 4, finish for painting. Square stopped at wall. Install strictly as per manufacturer's specifications and details. 5113G



sheet title:

date plotted:

scale:

job n#: date created:

Roof Details

drawn: **KN** checked: **JM** dwg n#:

NOTE: Drawings are ½ scale @ A3


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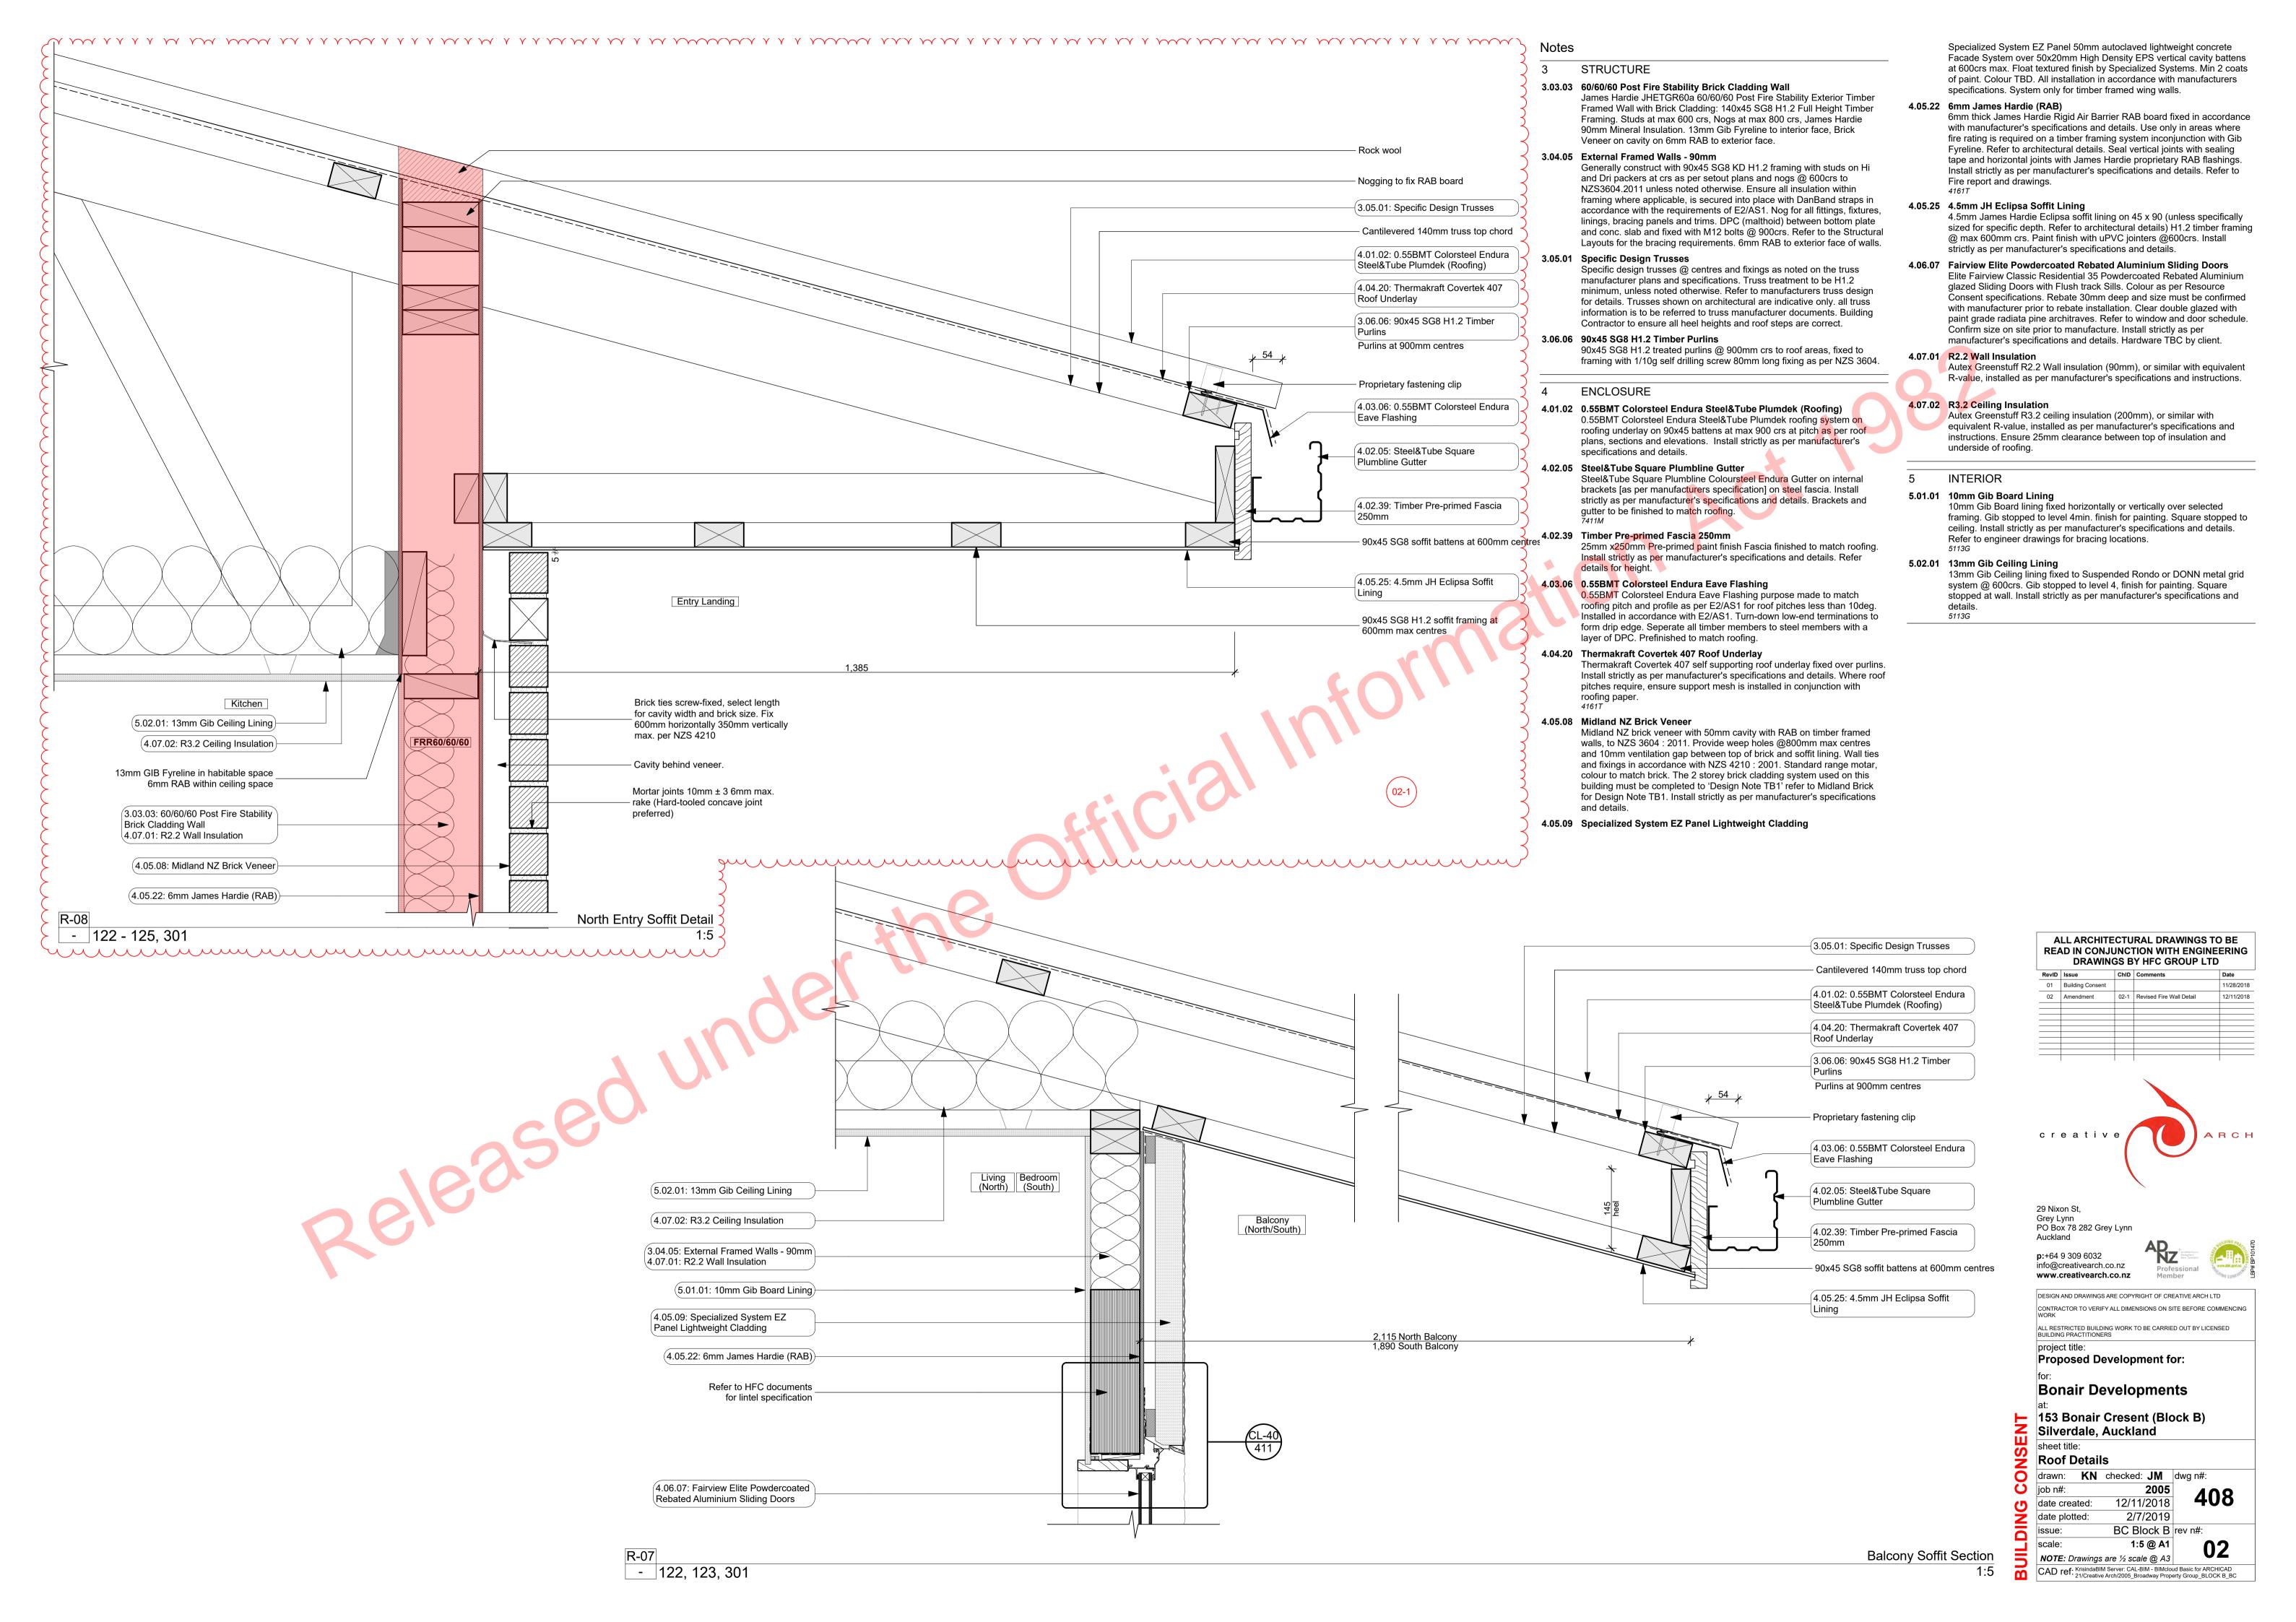
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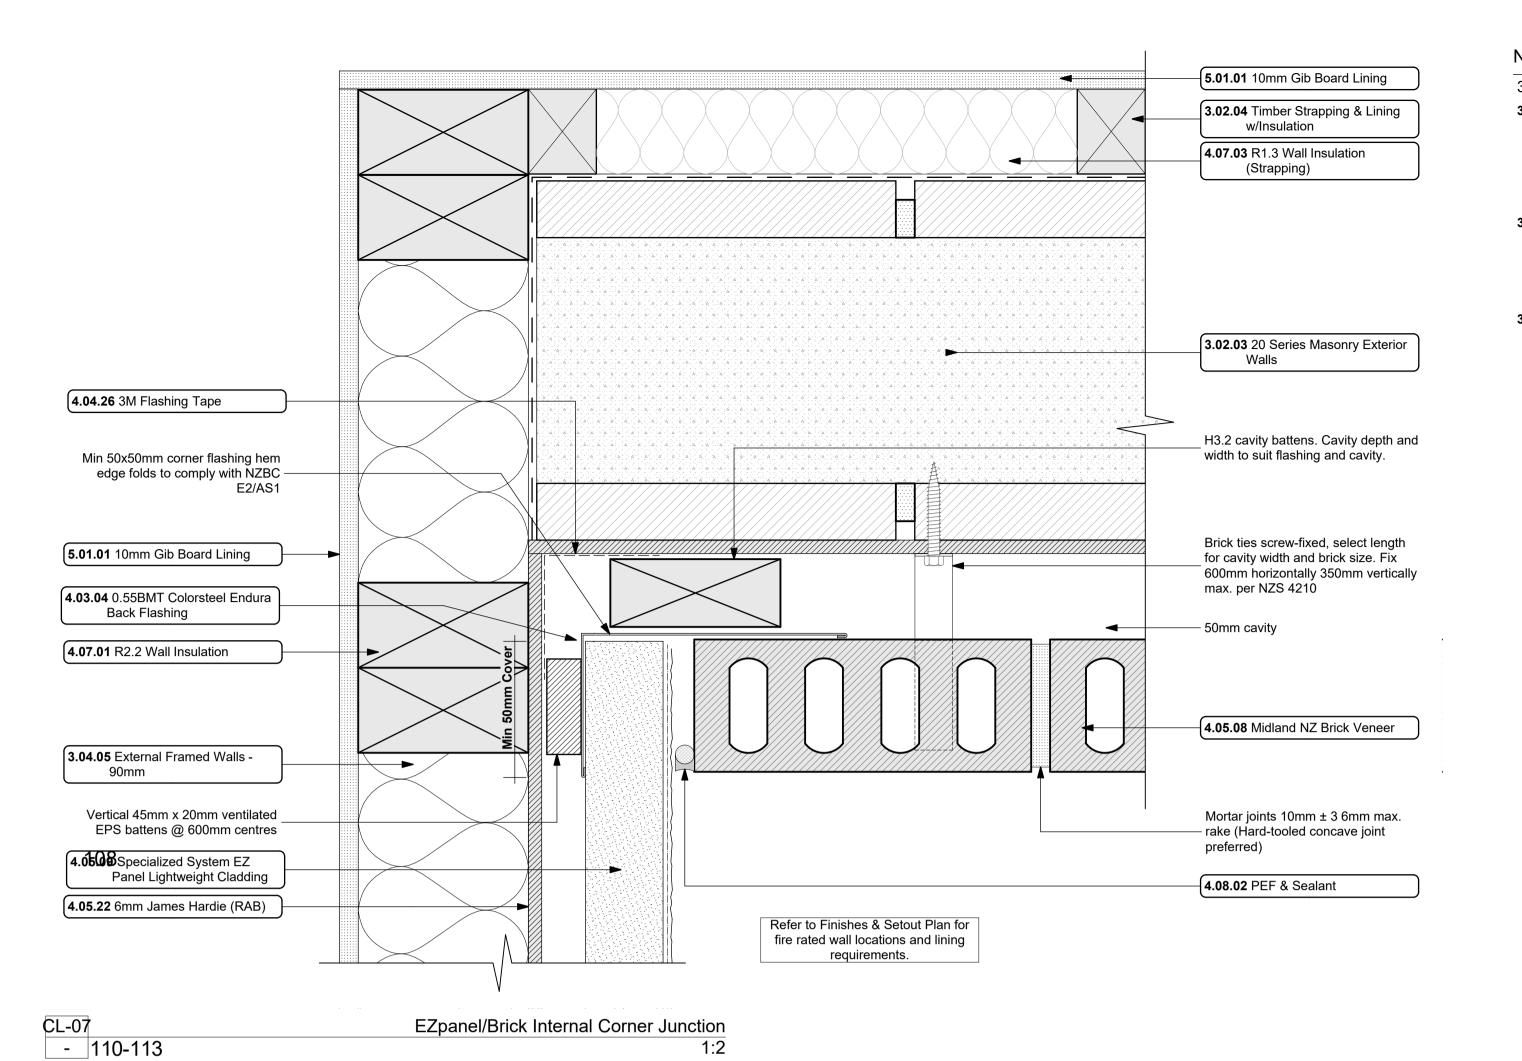
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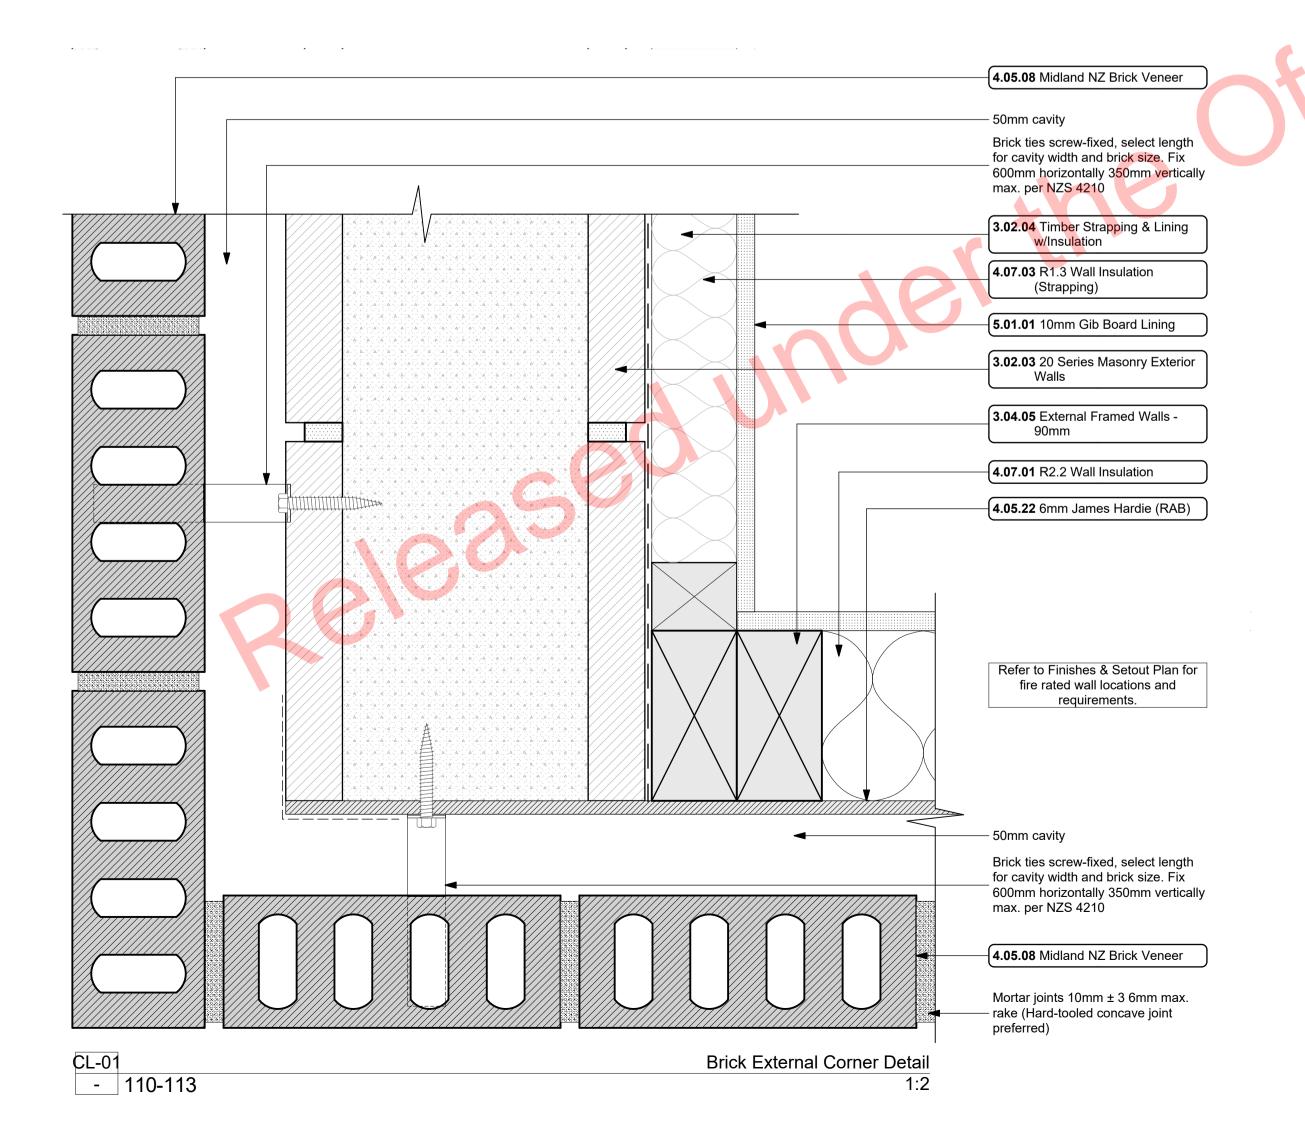
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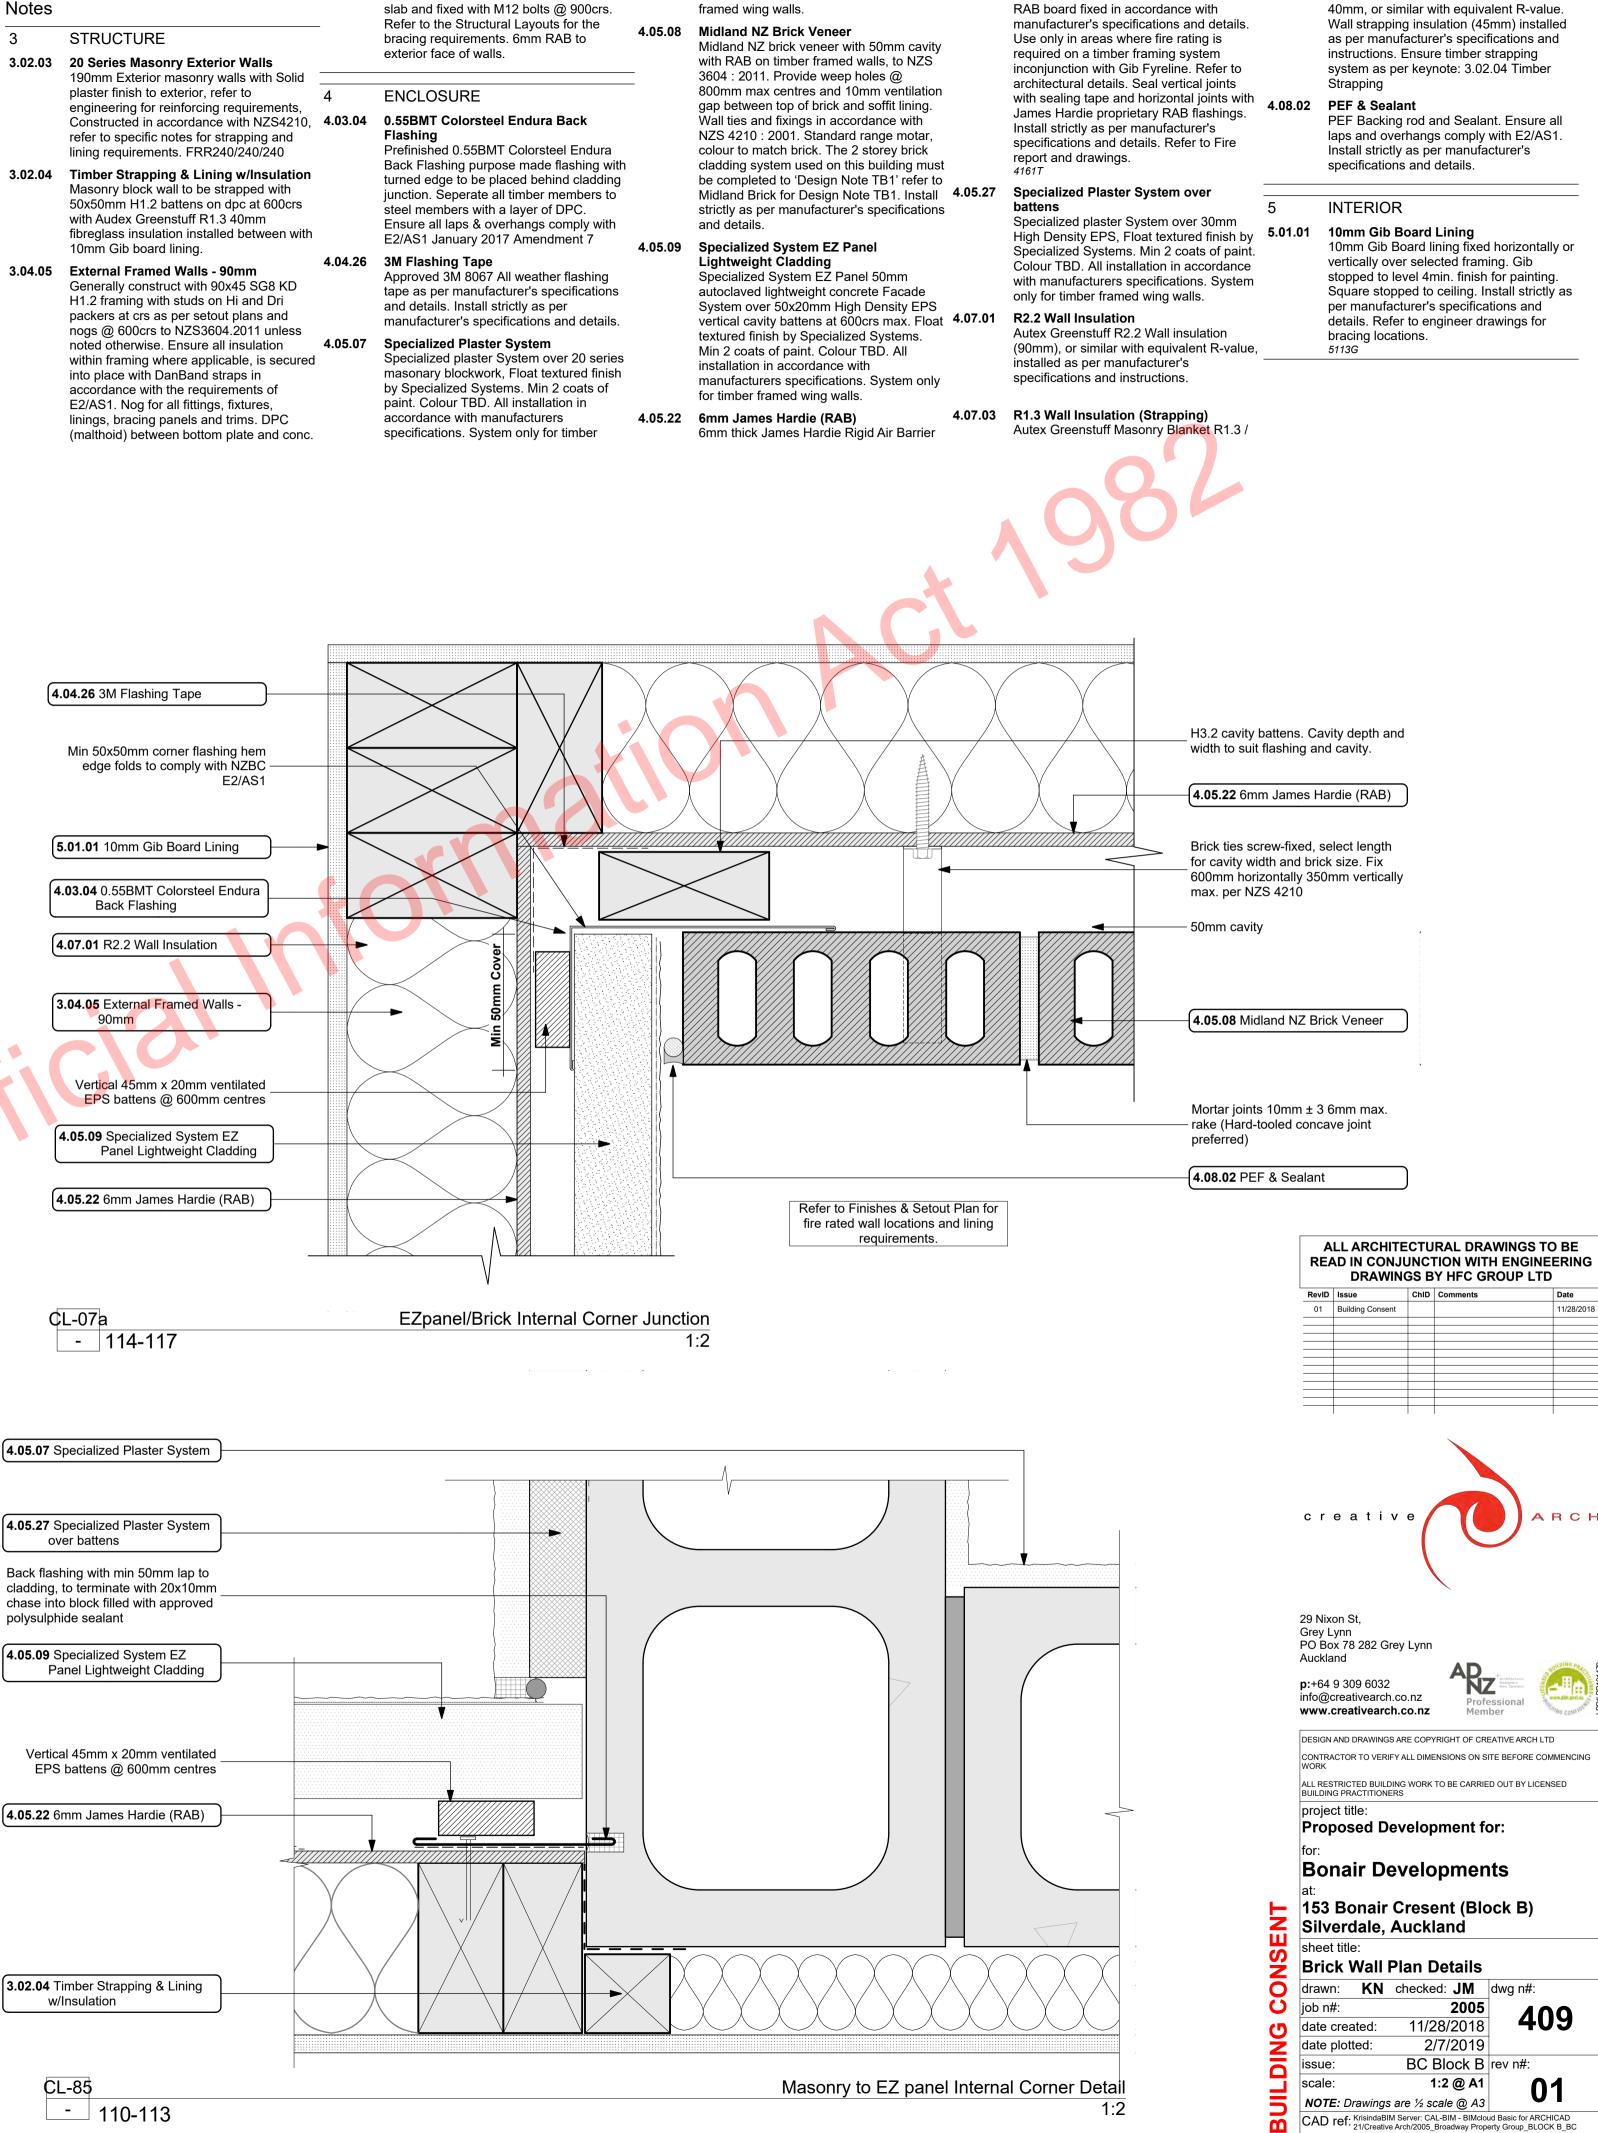
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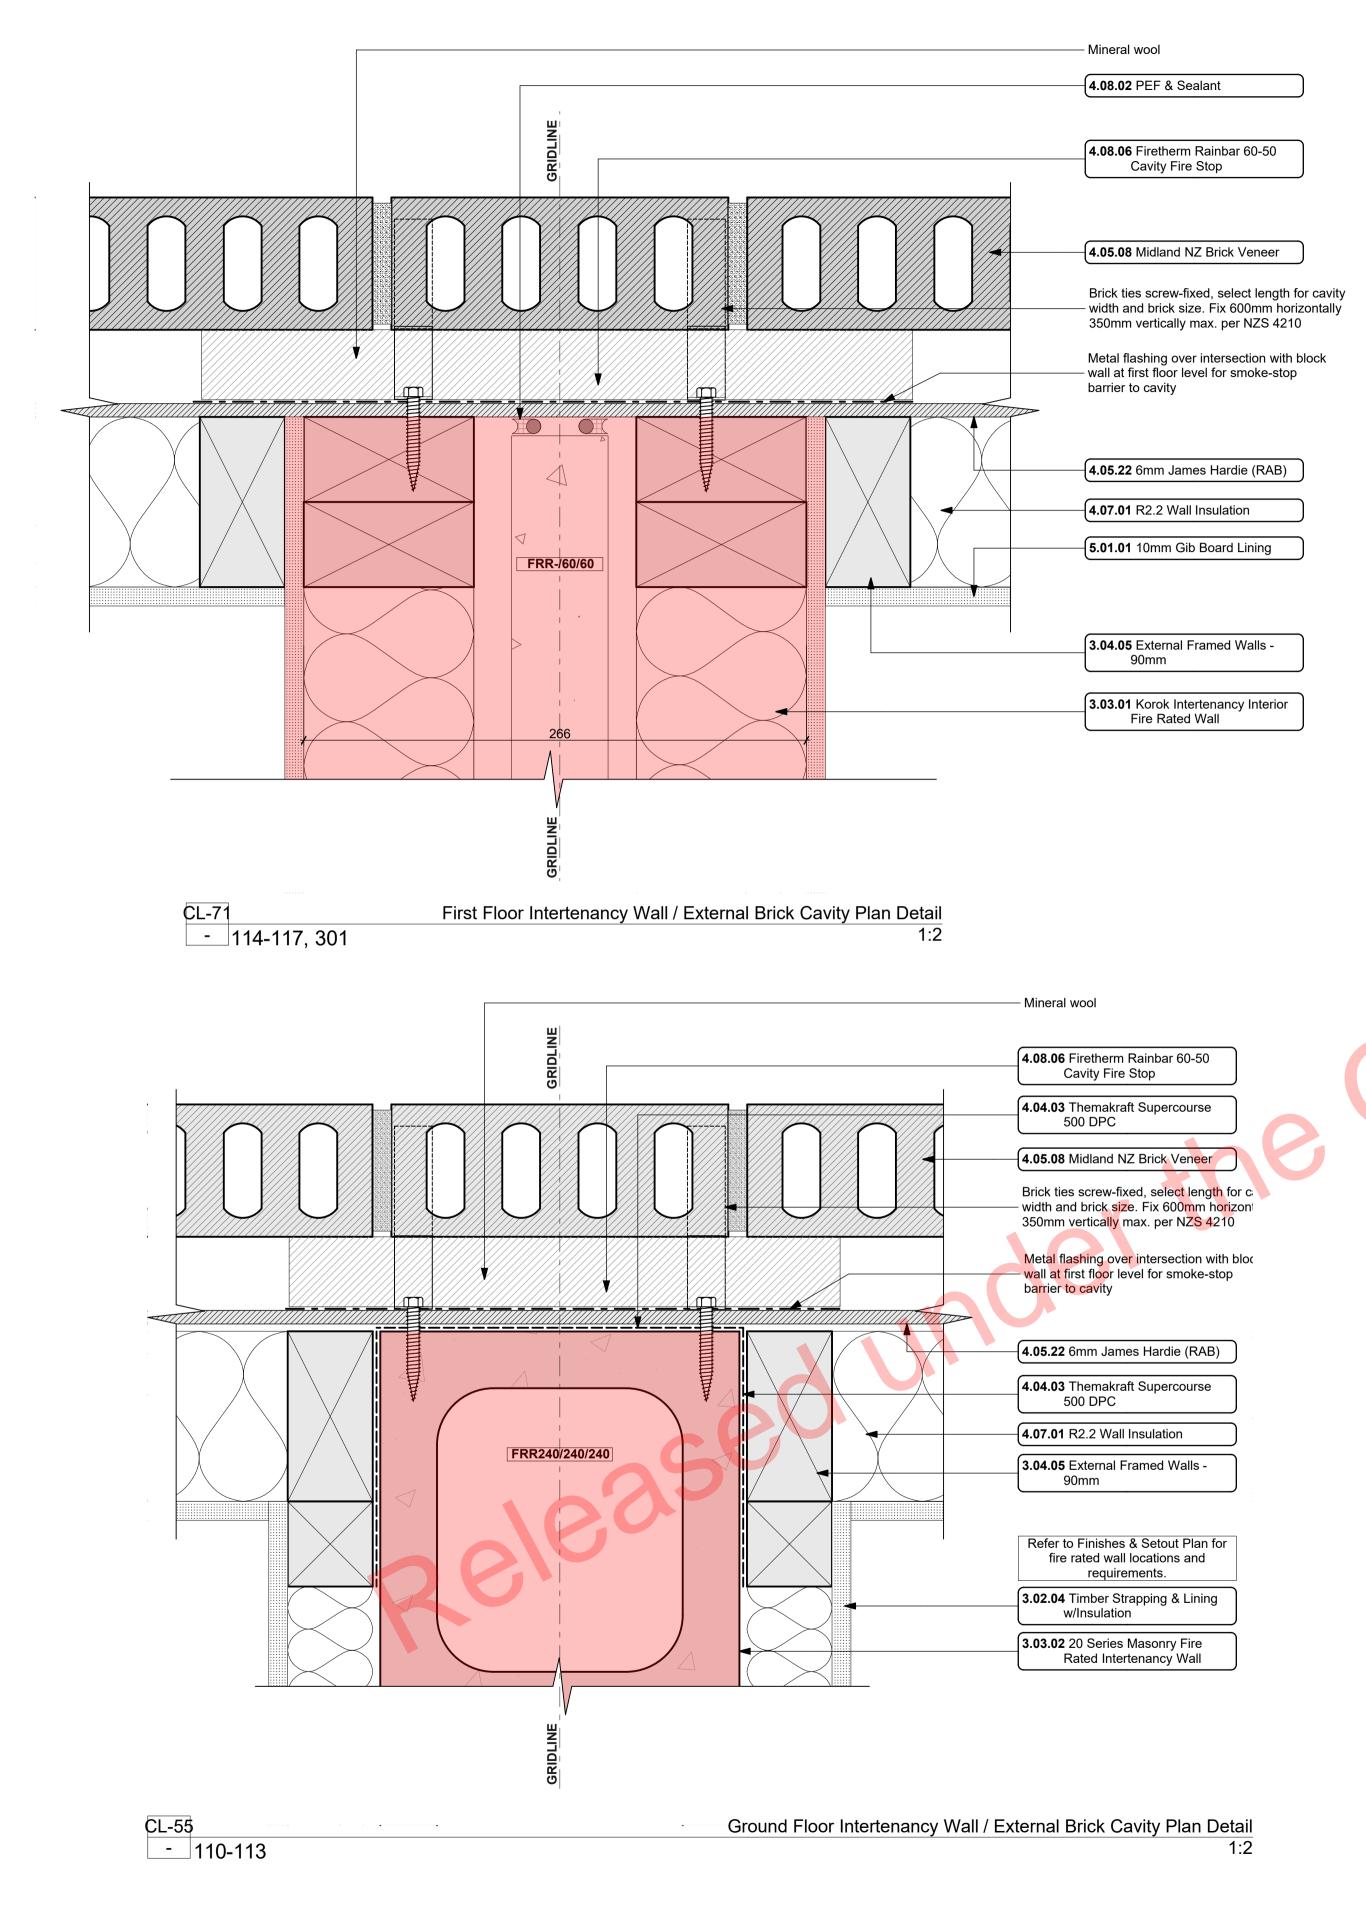










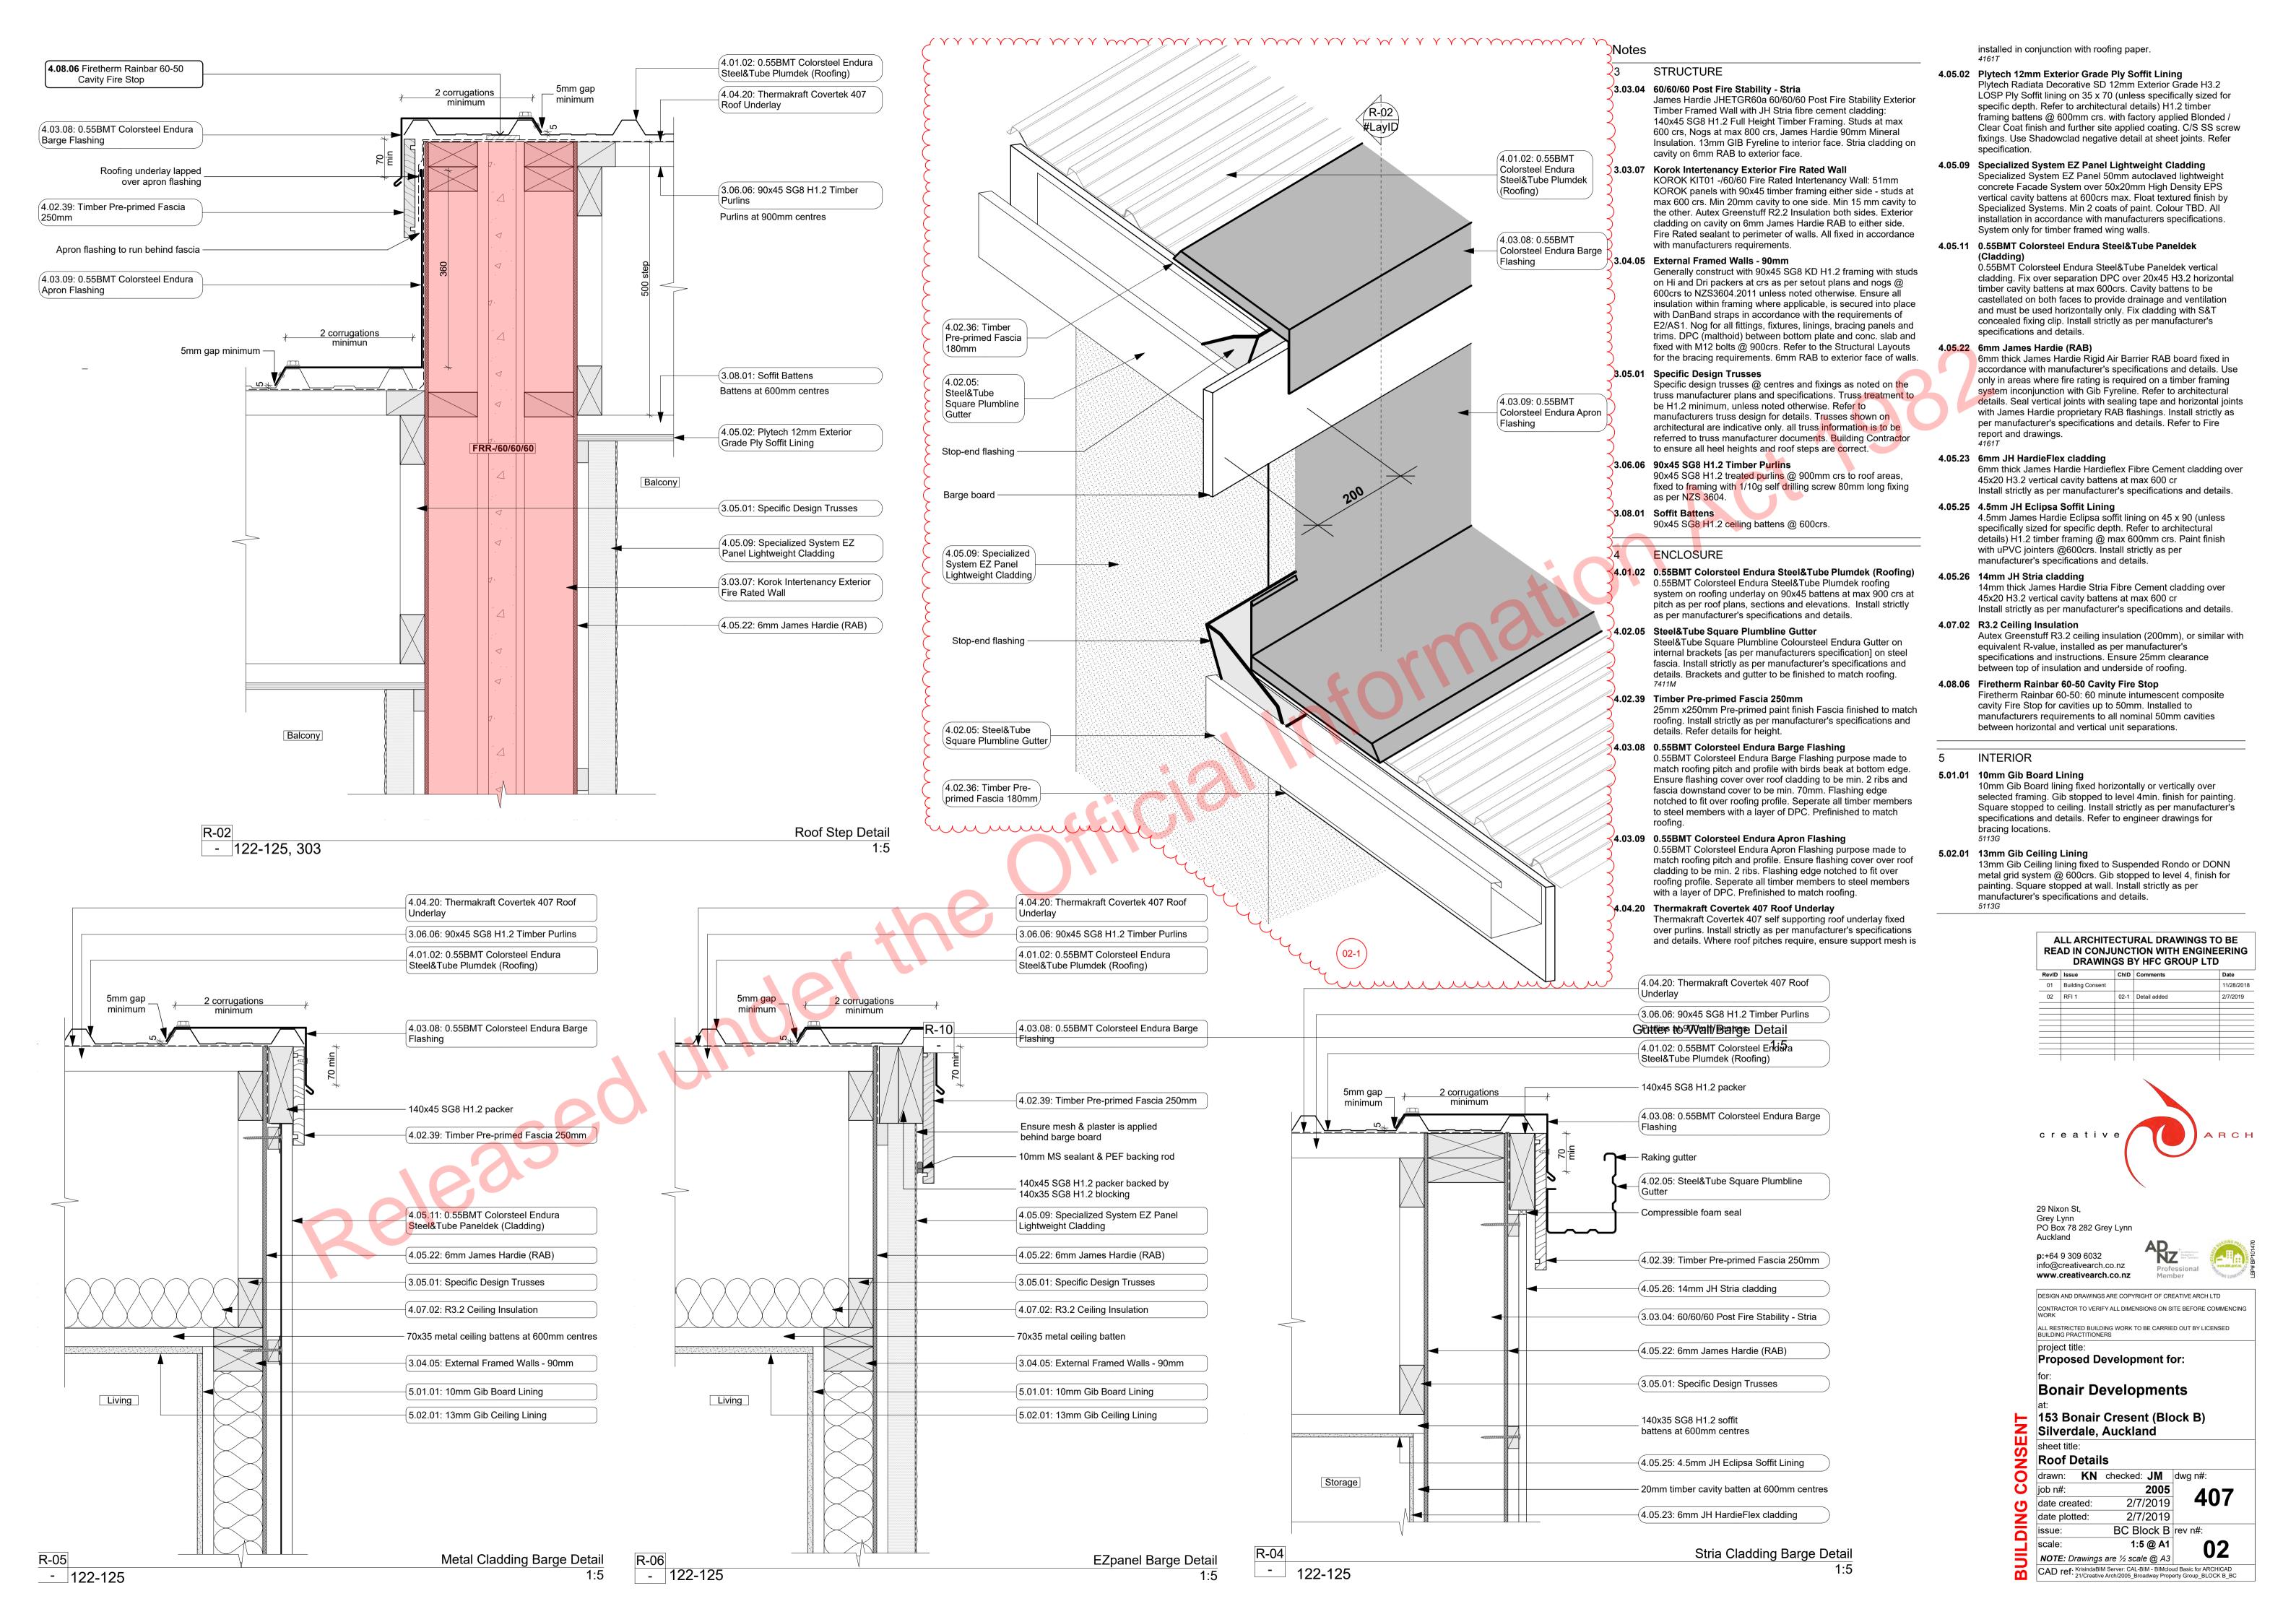

STRUCTURE

Notes

3.02.04 Timber Strapping & Lining w/Insulation Masonry block wall to be strapped with 50x50mm H1.2 battens on dpc at 600crs with Audex Greenstuff R1.3 40mm fibreglass insulation installed between with 10mm Gib board lining.

3.03.01 Korok Intertenancy Interior Fire Rated Wall KOROK KIT01 -/60/60 Fire Rated Intertenancy Wall: 51mm KOROK panels with 90x45 timber framing either side - studs at max 600 crs. 20mm cavity to one side. 15 mm cavity to the other. Audex Greenstuff R2.2 Insulation both sides. 10mm Gib Standard Plasterboard either side. Use 6mm RAB in lieu of Gib in ceiling cavity. Fire Rated sealant to perimeter of walls. All fixed in accordance with manufacturers requirements.

3.03.02 20 Series Masonry Fire Rated Intertenancy Wall FRR240/240/240 - 190 mm thick Fire Rated intertenancy wall. Installed to Structural Engineers Details. 10mm Paint Finish Gib on 50x50mm H1.2 timber strapping with R1.3 Insulation to either side. Fire Rated sealant to perimeter.

3.04.05 External Framed Walls - 90mm Generally construct with 90x45 SG8 KD H1.2 framing with studs on Hi and Dri packers at crs as per setout plans and nogs @ 600crs to NZS3604.2011 unless noted otherwise. Ensure all insulation within framing where applicable, is secured into place with DanBand straps in accordance with the requirements of E2/AS1. Nog for all fittings, fixtures, linings, bracing panels and trims. DPC (malthoid) between bottom plate and conc. slab and fixed with M12 bolts @ 900crs. Refer to the Structural Layouts for the bracing requirements. 6mm

RAB to exterior face of walls.

4.04.03 Themakraft Supercourse 500 DPC Thermakraft Supercourse 500 DPC between concrete/concrete masonry /aluminium and timber members. Install strictly as per manufacturer's

ENCLOSURE

specifications and details.

4.04.26 3M Flashing Tape Approved 3M 8067 All weather flashing tape as per manufacturer's specifications and details. Install strictly as per manufacturer's specifications and details.

4.05.08 Midland NZ Brick Veneer Midland NZ brick veneer with 50mm cavity with RAB on timber framed walls, to NZS 3604 : 2011. Provide weep holes @800mm max centres and 10mm ventilation gap between top of brick and soffit lining. Wall ties and fixings in accordance with NZS 4210: 2001. Standard range motar, colour to match brick. The 2 storey brick cladding system used on this building must be completed to 'Design Note TB1' refer to Midland Brick for Design Note TB1. Install strictly as per manufacturer's specifications and details.

4.05.22 6mm James Hardie (RAB) 6mm thick James Hardie Rigid Air Barrier RAB board fixed in accordance with manufacturer's specifications and details. Use only in areas where fire rating is required on a timber framing system inconjunction with Gib Fyreline. Refer to architectural details. Seal vertical joints with sealing tape and horizontal joints with James Hardie proprietary RAB flashings. Install strictly as per manufacturer's specifications and details. Refer to Fire report and drawings.

4.06.08 Fairview Elite Powdercoat Aluminium Windows Elite Fairview Classic Residential 35 Powdercoated Aluminium Windows. Colour as per Resource Consent

specifications. Double glazed with paint grade radiata pine architraves. Obscure glass to bathrooms, wc's and ensuites. Refer to window and door schedule. Confirm size on site prior to manufacture. Install strictly as per manufacturer's specifications and details. Hardware TBC by client.

4.07.01 R2.2 Wall Insulation

4.08.02 PEF & Sealant

Autex Greenstuff R2.2 Wall insulation (90mm), or similar with equivalent R-value, installed as per manufacturer's specifications and instructions.

PEF Backing rod and Sealant. Ensure all laps and overhangs comply with E2/AS1. Install strictly as per


manufacturer's specifications and details


4.08.06 Firetherm Rainbar 60-50 Cavity Fire Stop Firetherm Rainbar 60-50: 60 minute intumescent composite cavity Fire Stop for cavities up to 50mm. Installed to manufacturers requirements to all nominal 50mm cavities between horizontal and vertical unit separations.


INTERIOR

5.01.01 10mm Gib Board Lining

10mm Gib Board lining fixed horizontally or vertically over selected framing. Gib stopped to level 4min. finish for painting. Square stopped to ceiling. Install strictly as per manufacturer's specifications and details. Refer to engineer drawings for bracing locations.

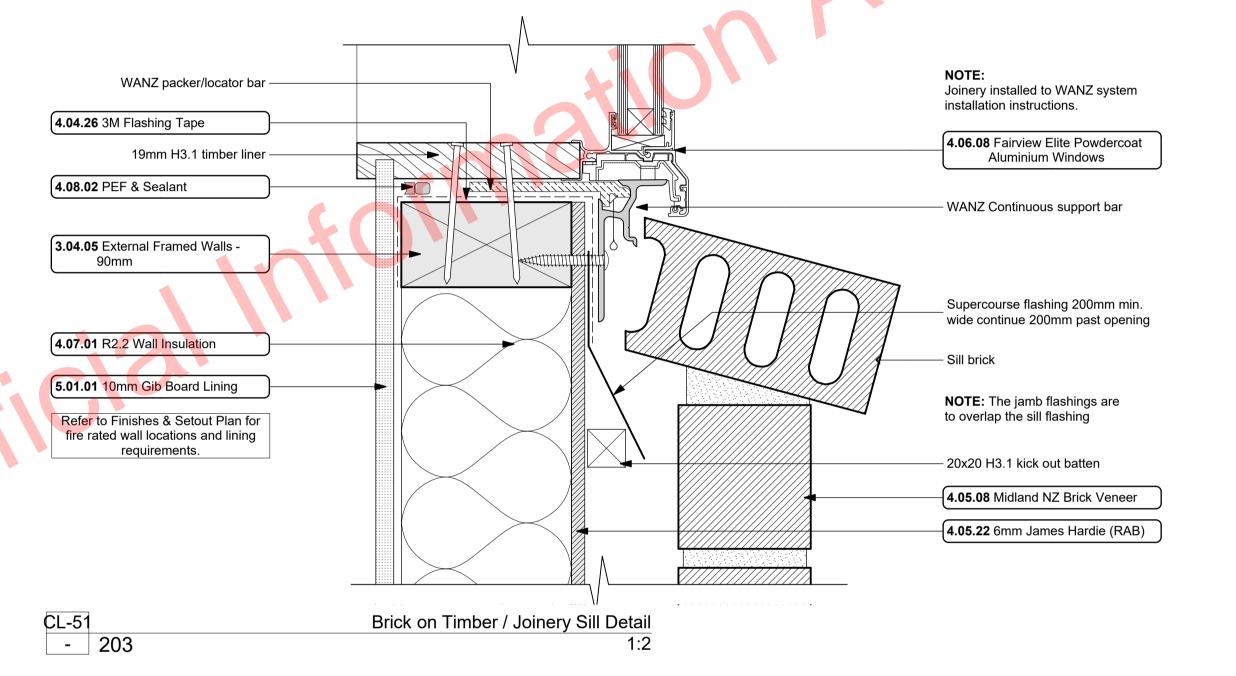

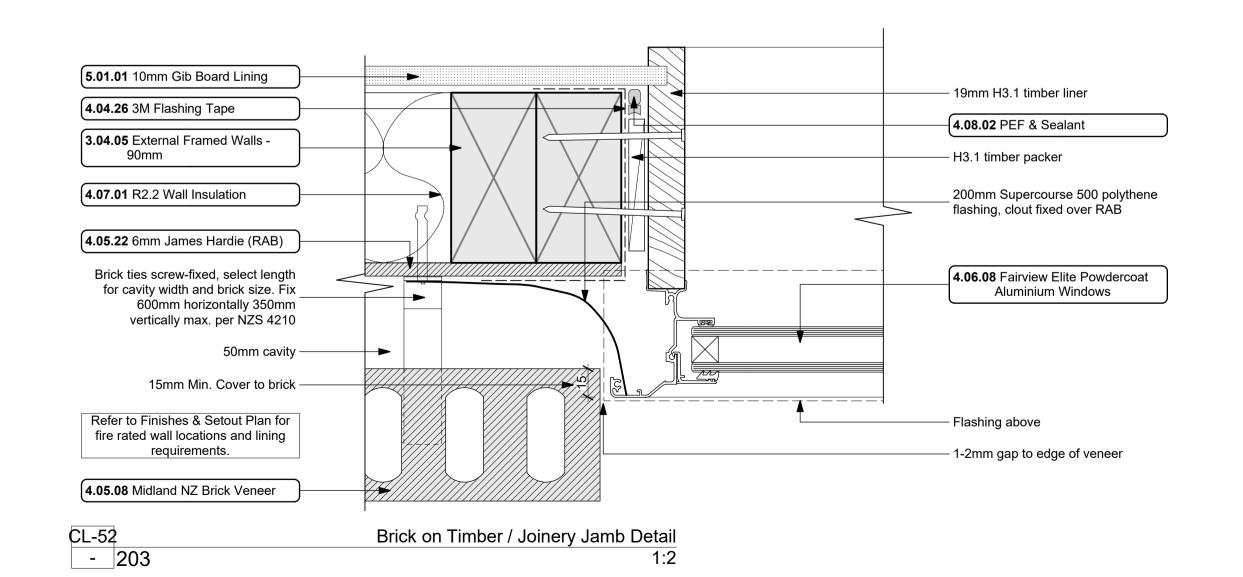

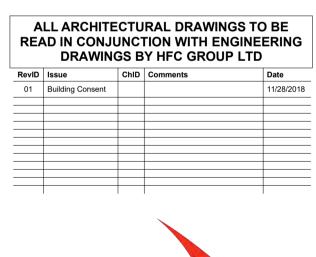



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project title:

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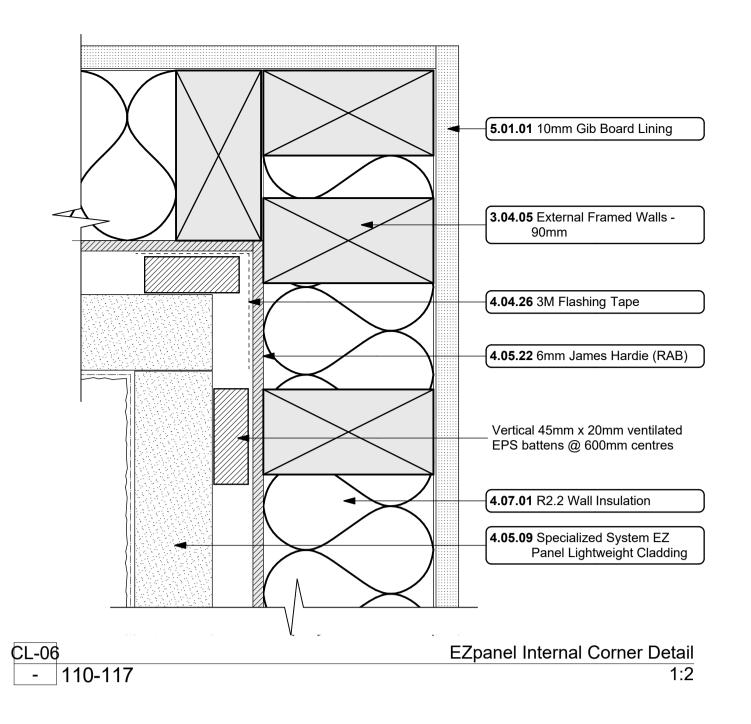
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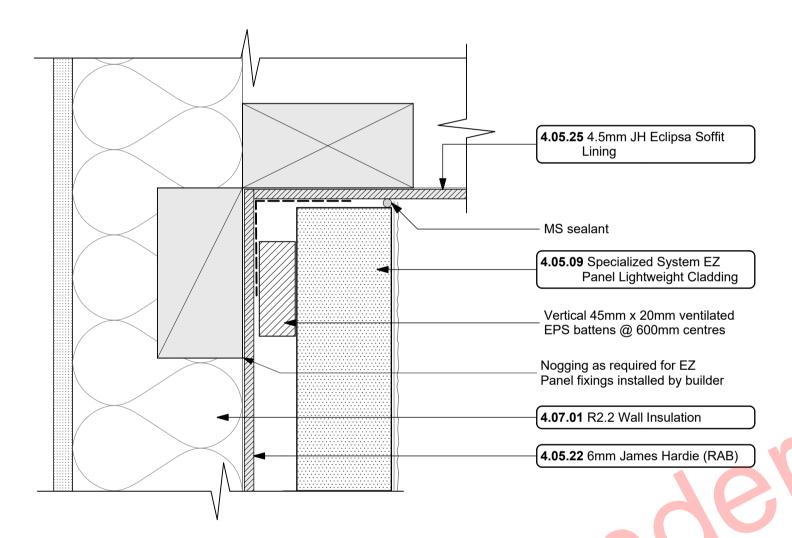
 153 Bonair Cresent (Block B) Silverdale, Auckland

sheet title: **Brick Wall Standard Details** drawn: KN checked: JM dwg n#: 2005 11/28/2018 date created: 2/7/2019 BC Block B rev n#:


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1:2 @ A1 NOTE: Drawings are ½ scale @ A3






EZpanel / Soffit Lining Detail

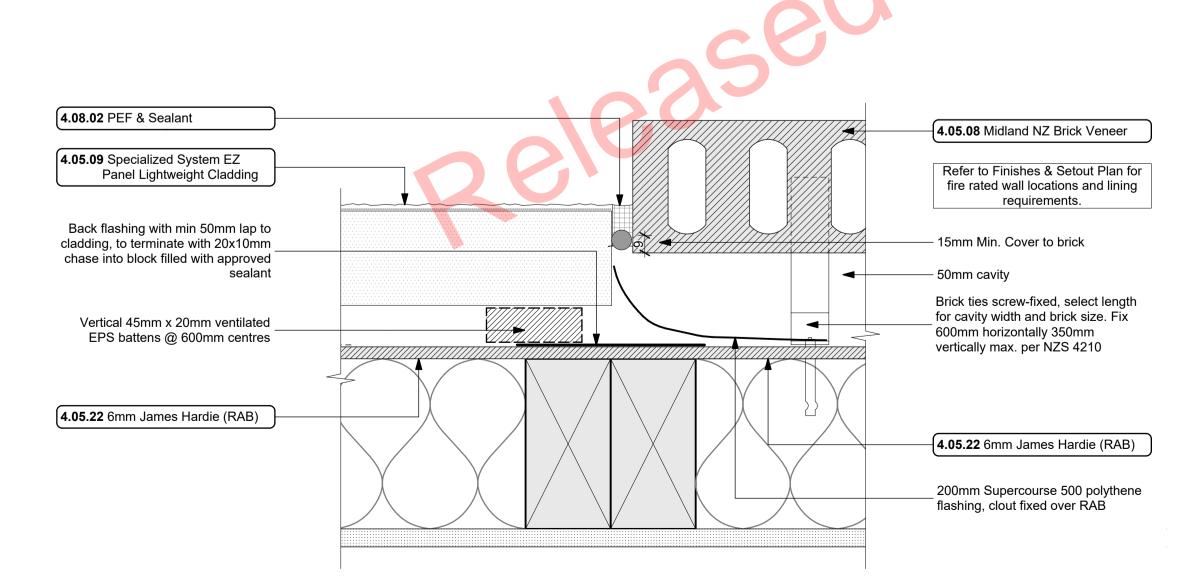

___typical detail

CL-84 Brick to EZ panel recess - 203 1:2

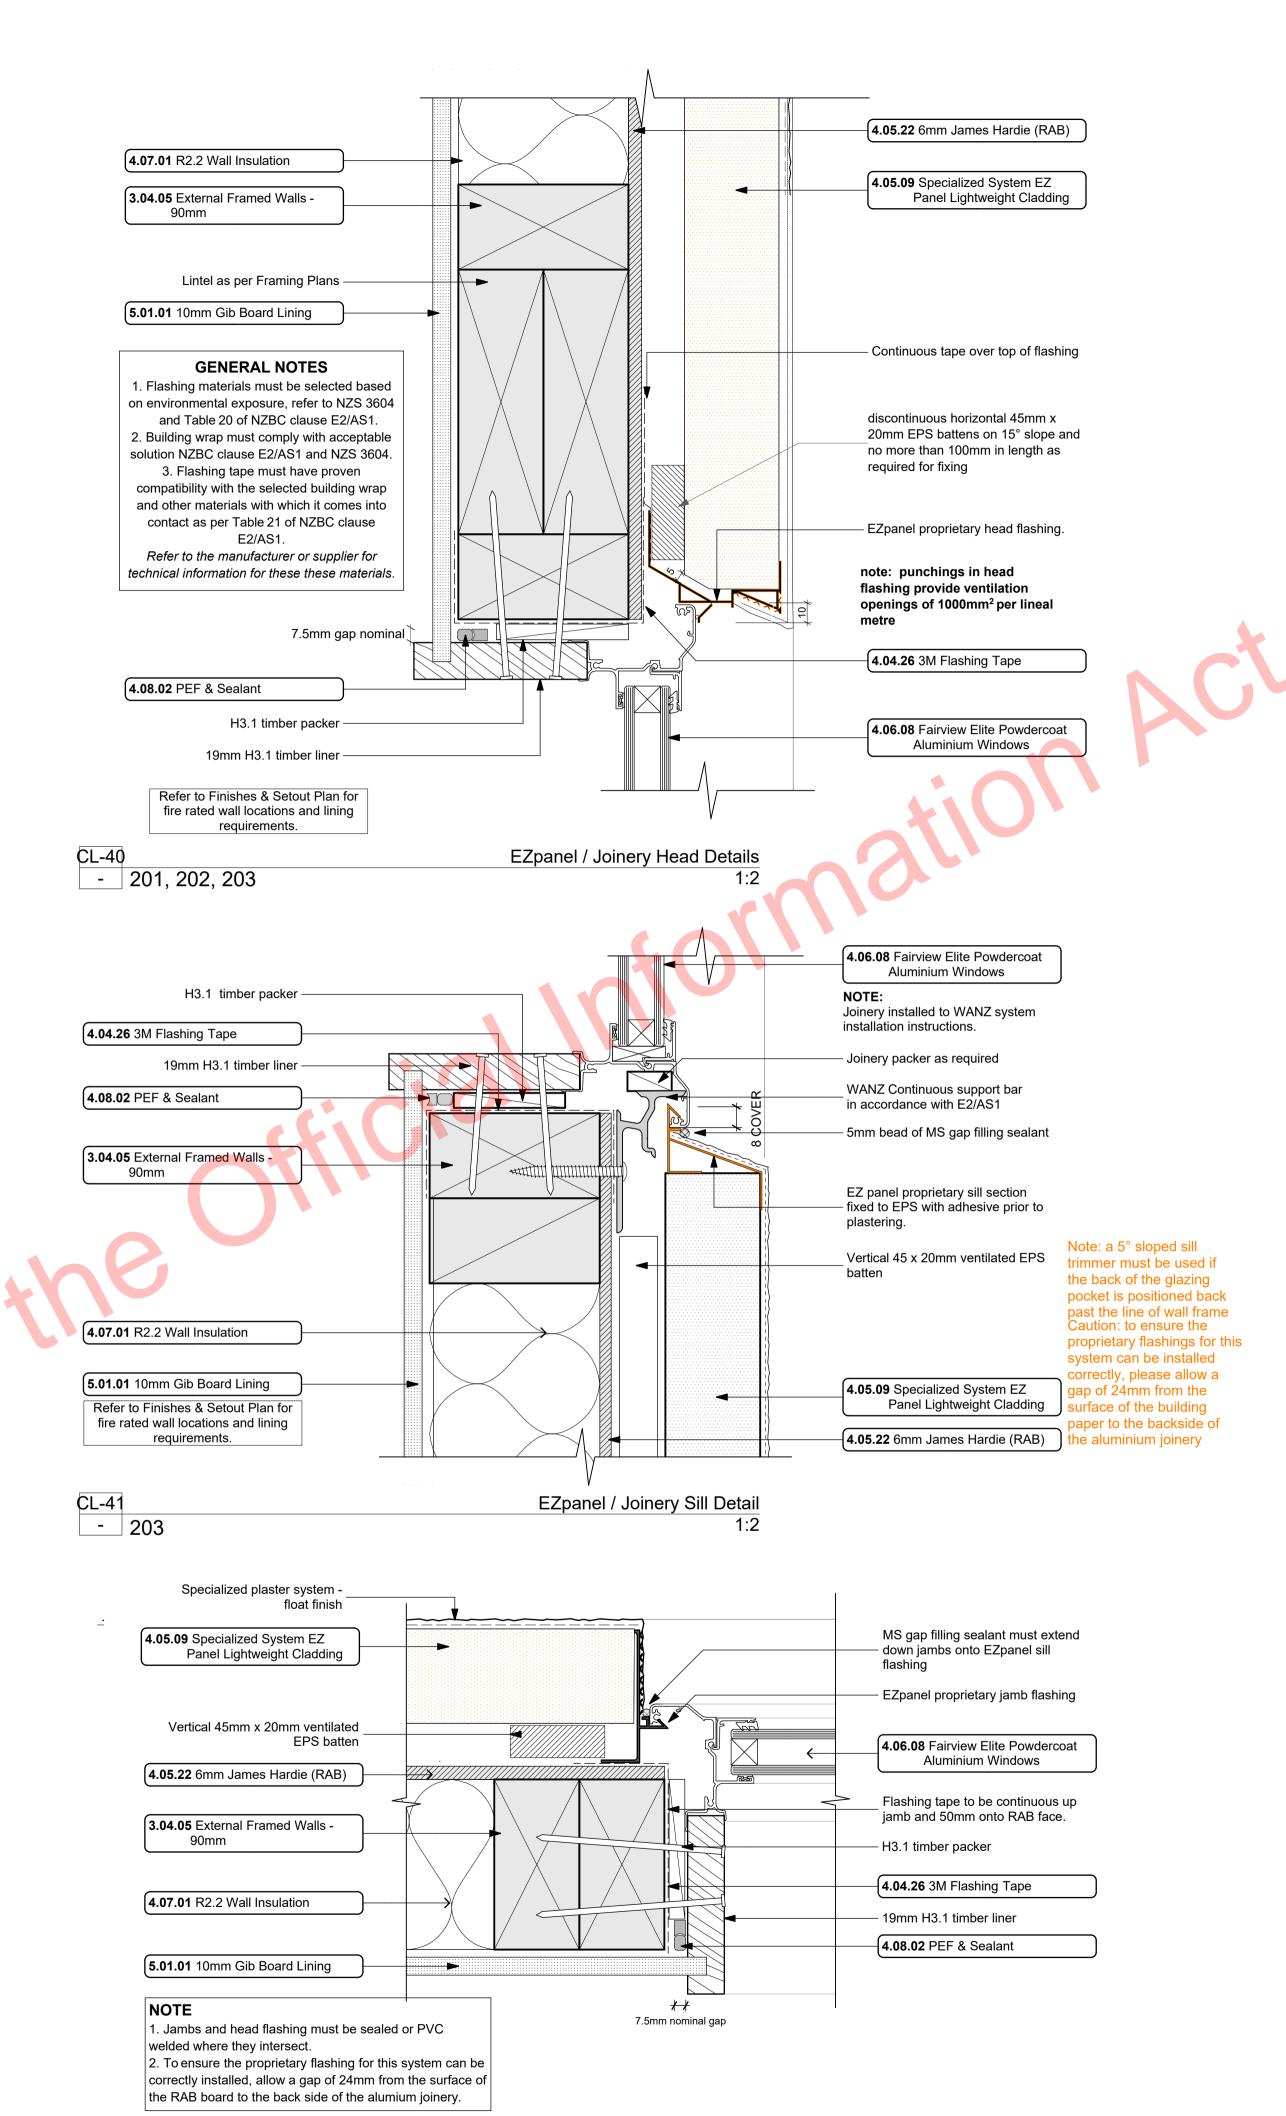

EZpanel / Joinery Jamb Detail

Notes

STRUCTURE

3.04.05 External Framed Walls - 90mm Generally construct with 90x45 SG8 KD H1.2 framing with studs on Hi and Dri packers at crs as per setout plans and nogs @ 600crs to NZS3604.2011 unless noted otherwise. Ensure all insulation within framing where applicable, is secured into place with DanBand straps in accordance with the requirements of E2/AS1. Nog for all fittings, fixtures, linings, bracing finish with uPVC jointers @600crs. panels and trims. DPC (malthoid) Install strictly as per manufacturer's between bottom plate and conc. slab specifications and details. and fixed with M12 bolts @ 900crs. Refer to the Structural Layouts for the bracing requirements. 6mm RAB to exterior face of walls.

ENCLOSURE

4.04.26 3M Flashing Tape Approved 3M 8067 All weather flashing tape as per manufacturer's specifications and details. Install strictly as per manufacturer's

specifications and details. 4.05.08 Midland NZ Brick Veneer Midland NZ brick veneer with 50mm cavity with RAB on timber framed walls, to NZS 3604: 2011. Provide weep holes @800mm max centres and 10mm ventilation gap between top of brick and soffit lining. Wall ties and fixings in accordance with NZS 4210: 2001. Standard range motar, colour to match brick. The 2 storey brick cladding system used on this building must be completed to 'Design Note TB1' refer to Midland Brick for Design Note TB1. Install strictly as per manufacturer's specifications and

4.05.09 Specialized System EZ Panel

Lightweight Cladding Specialized System EZ Panel 50mm autoclaved lightweight concrete Facade System over 50x20mm High Density EPS vertical cavity battens at 600crs max. Float textured finish by Specialized Systems. Min 2 coats of paint. Colour TBD. All installation in accordance with manufacturers specifications. System only for timber framed wing walls. 4.05.22 6mm James Hardie (RAB)

a timber framing system inconjunction

6mm thick James Hardie Rigid Air Barrier RAB board fixed in accordance with manufacturer's specifications and details. Use only in areas where fire rating is required on

with Gib Fyreline. Refer to

architectural details. Seal vertical joints with sealing tape and horizontal joints with James Hardie proprietary RAB flashings. Install strictly as per manufacturer's specifications and details. Refer to Fire report and

4.05.25 4.5mm JH Eclipsa Soffit Lining 4.5mm James Hardie Eclipsa soffit lining on 45 x 90 (unless specifically sized for specific depth. Refer to architectural details) H1.2 timber framing @ max 600mm crs. Paint

4.06.08 Fairview Elite Powdercoat **Aluminium Windows**

Elite Fairview Classic Residential 35 Powdercoated Aluminium Windows. Colour as per Resource Consent specifications. Double glazed with paint grade radiata pine architraves. Obscure glass to bathrooms, wc's and ensuites. Refer to window and door schedule. Confirm size on site prior to manufacture. Install strictly as per manufacturer's specifications and details. Hardware TBC by client.

4.07.01 R2.2 Wall Insulation Autex Greenstuff R2.2 Wall insulation

(90mm), or similar with equivalent Rvalue, installed as per manufacturer's specifications and instructions.

4.08.02 PEF & Sealant


PEF Backing rod and Sealant. Ensure all laps and overhangs comply with E2/AS1. Install strictly as per manufacturer's specifications and details.

INTERIOR

5.01.01 10mm Gib Board Lining

10mm Gib Board lining fixed horizontally or vertically over selected framing. Gib stopped to level 4min. finish for painting. Square stopped to ceiling. Install strictly as per manufacturer's specifications and details. Refer to engineer drawings for bracing locations.

ALL ARCHITECTURAL DRAWINGS TO BE READ IN CONJUNCTION WITH ENGINEERING DRAWINGS BY HFC GROUP LTD

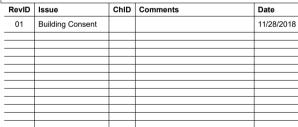



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Bonair Developments


 153 Bonair Cresent (Block B) Silverdale, Auckland

sheet title: **EZ Panel Details** date created:

drawn: KN checked: JM dwg n#: 2005 11/28/2018 2/7/2019 BC Block B rev n#:

1:2 @ A1 NOTE: Drawings are ½ scale @ A3

CAD ref: KrisindaBIM Server: CAL-BIM - BIMcloud Basic for ARCHICAD 21/Creative Arch/2005_Broadway Property Group_BLOCK B_BC

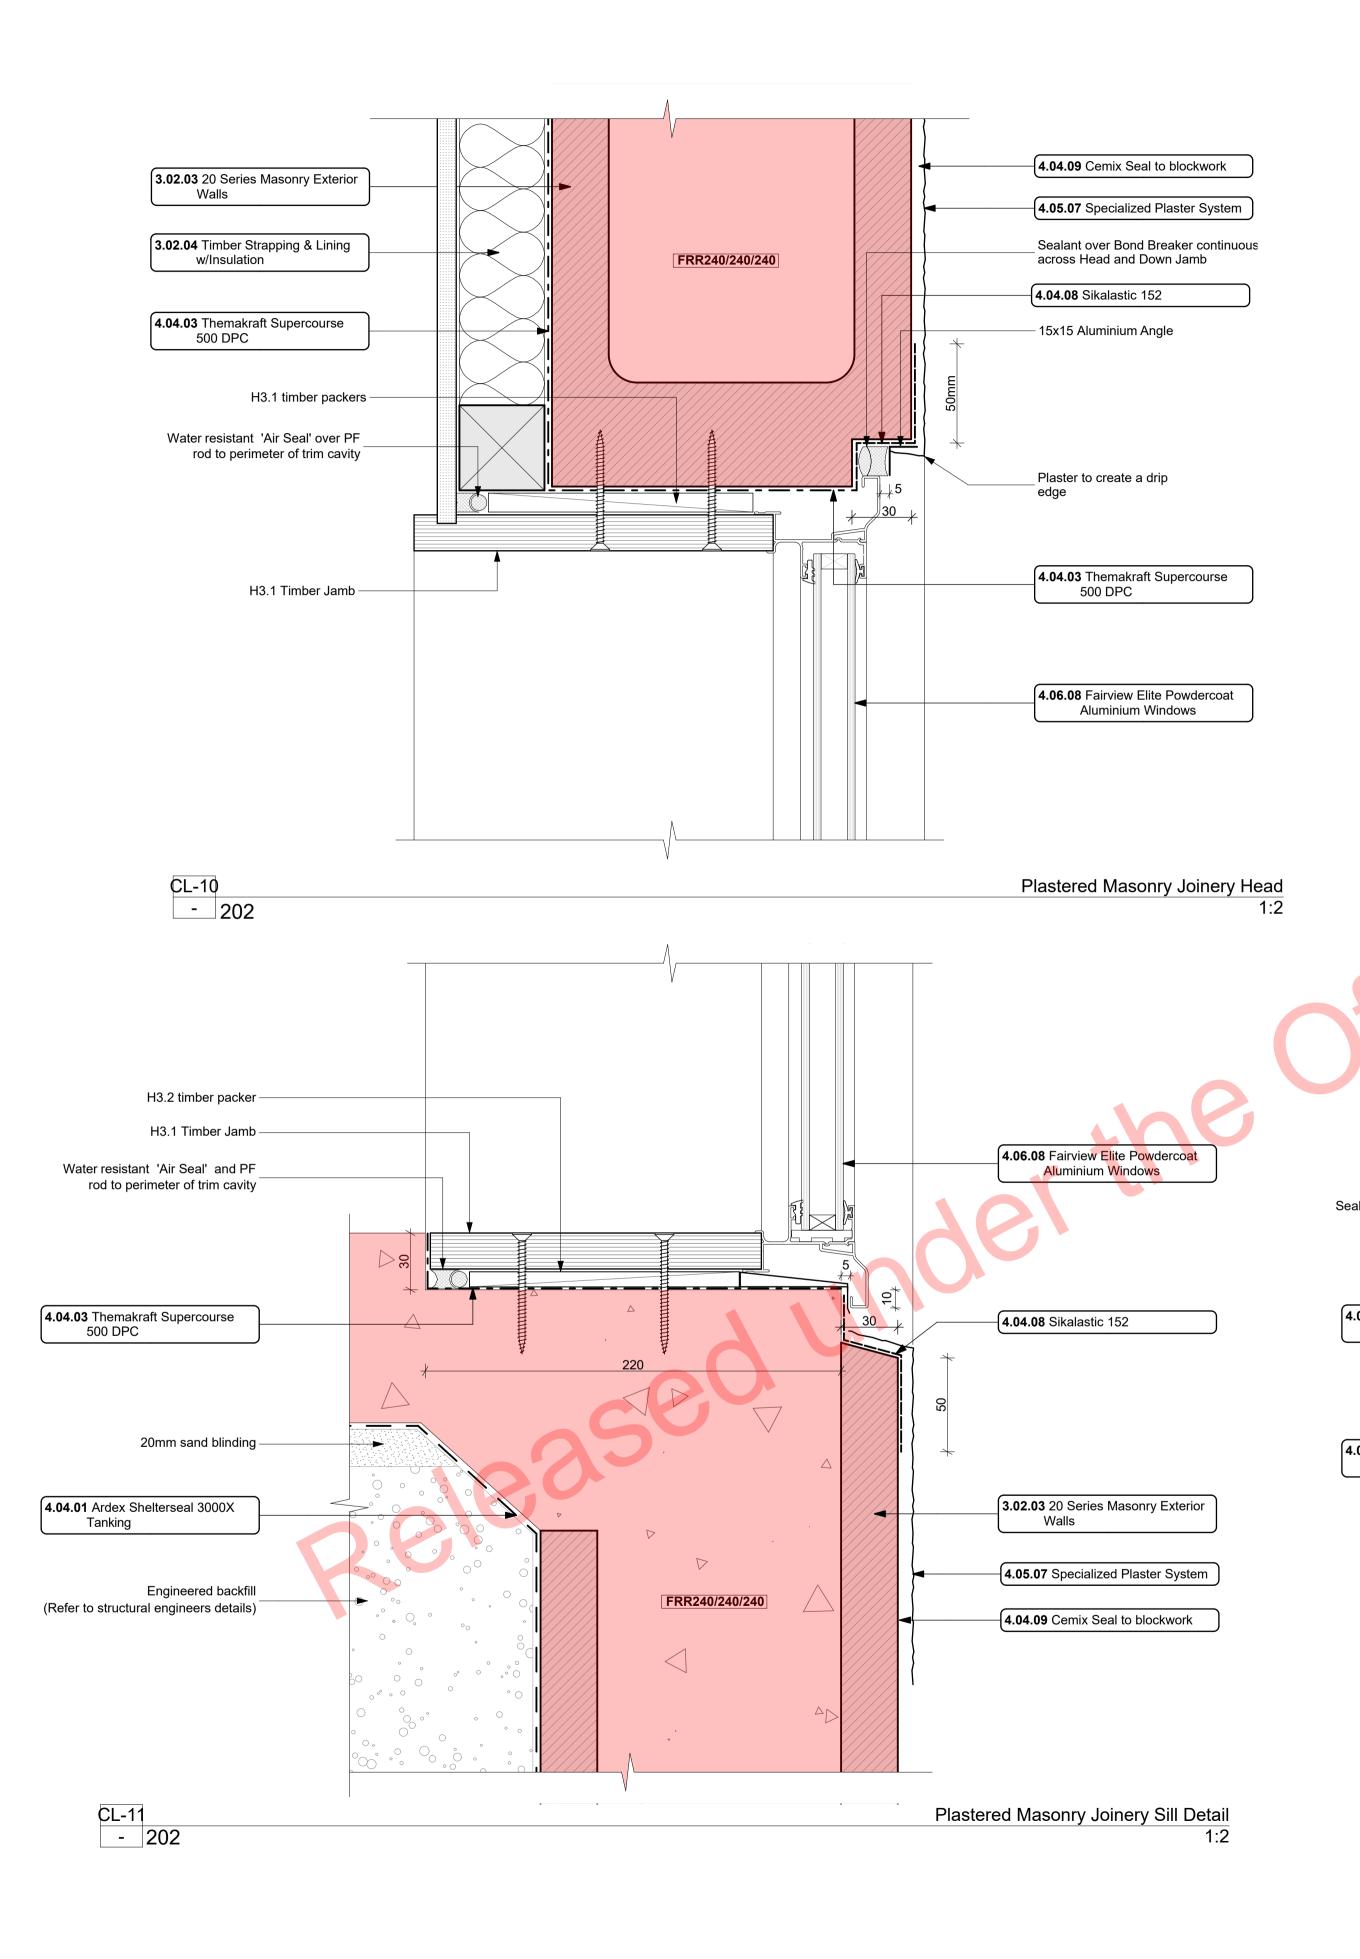

4.04.09 Cemix Seal to blockwork Cemix Brick and Block Sealer Applied to block face prior to lining with brick cladding. All in accordance with 3.02.03 20 Series Masonry Exterior Walls manufacturers requirements.

190mm Exterior masonry walls with Specialized plaster System over 20 series masonary blockwork, Float textured finish by Specialized accordance with NZS4210, refer to specific notes for strapping and lining TBD. All installation in accordance with manufacturers specifications. System only for timber framed wing

4.06.08 Fairview Elite Powdercoat with 50x50mm H1.2 battens on dpc at **Aluminium Windows** 600crs with Audex Greenstuff R1.3 40mm fibreglass insulation installed between with 10mm Gib board lining. 4.04.01 Ardex Shelterseal 3000X Tanking

Notes

STRUCTURE

engineering for reinforcing

3.02.04 Timber Strapping & Lining

w/Insulation

ENCLOSURE

requirements, Constructed in

requirements. FRR240/240/240

Masonry block wall to be strapped

Ardex Shelterseal 3000X pe and stick

Tanking installed strictly as per

foundations, retaining walls etc

manufacturers specifications and

details to below ground applications -


500 DPC

Solid plaster finish to exterior, refer to 4.05.07 Specialized Plaster System Systems. Min 2 coats of paint. Colour

> Elite Fairview Classic Residential 35 Powdercoated Aluminium Windows. Colour as per Resource Consent specifications. Double glazed with paint grade radiata pine architraves. Obscure glass to bathrooms, wc's and ensuites. Refer to window and door schedule. Confirm size on site prior to manufacture. Install strictly as per manufacturer's specifications and details. Hardware TBC by client.

4.04.08 Sikalastic 152 15x15 Aluminium Angle 4.04.09 Cemix Seal to blockwork Sealant over Bond Breaker continuous across Head and Down Jamb . 50mm 4.05.07 Specialized Plaster System **4.06.08** Fairview Elite Powdercoat **Aluminium Windows 4.04.03** Themakraft Supercourse FRR240/240/240 H3.1 Timber Jamb **3.02.03** 20 Series Masonry Exterior Walls Timber packers Water resistant 'Air Seal' over PF **3.02.04** Timber Strapping & Lining rod to perimeter of trim cavity w/Insulation Plastered Masonry Joinery Jamb Detail



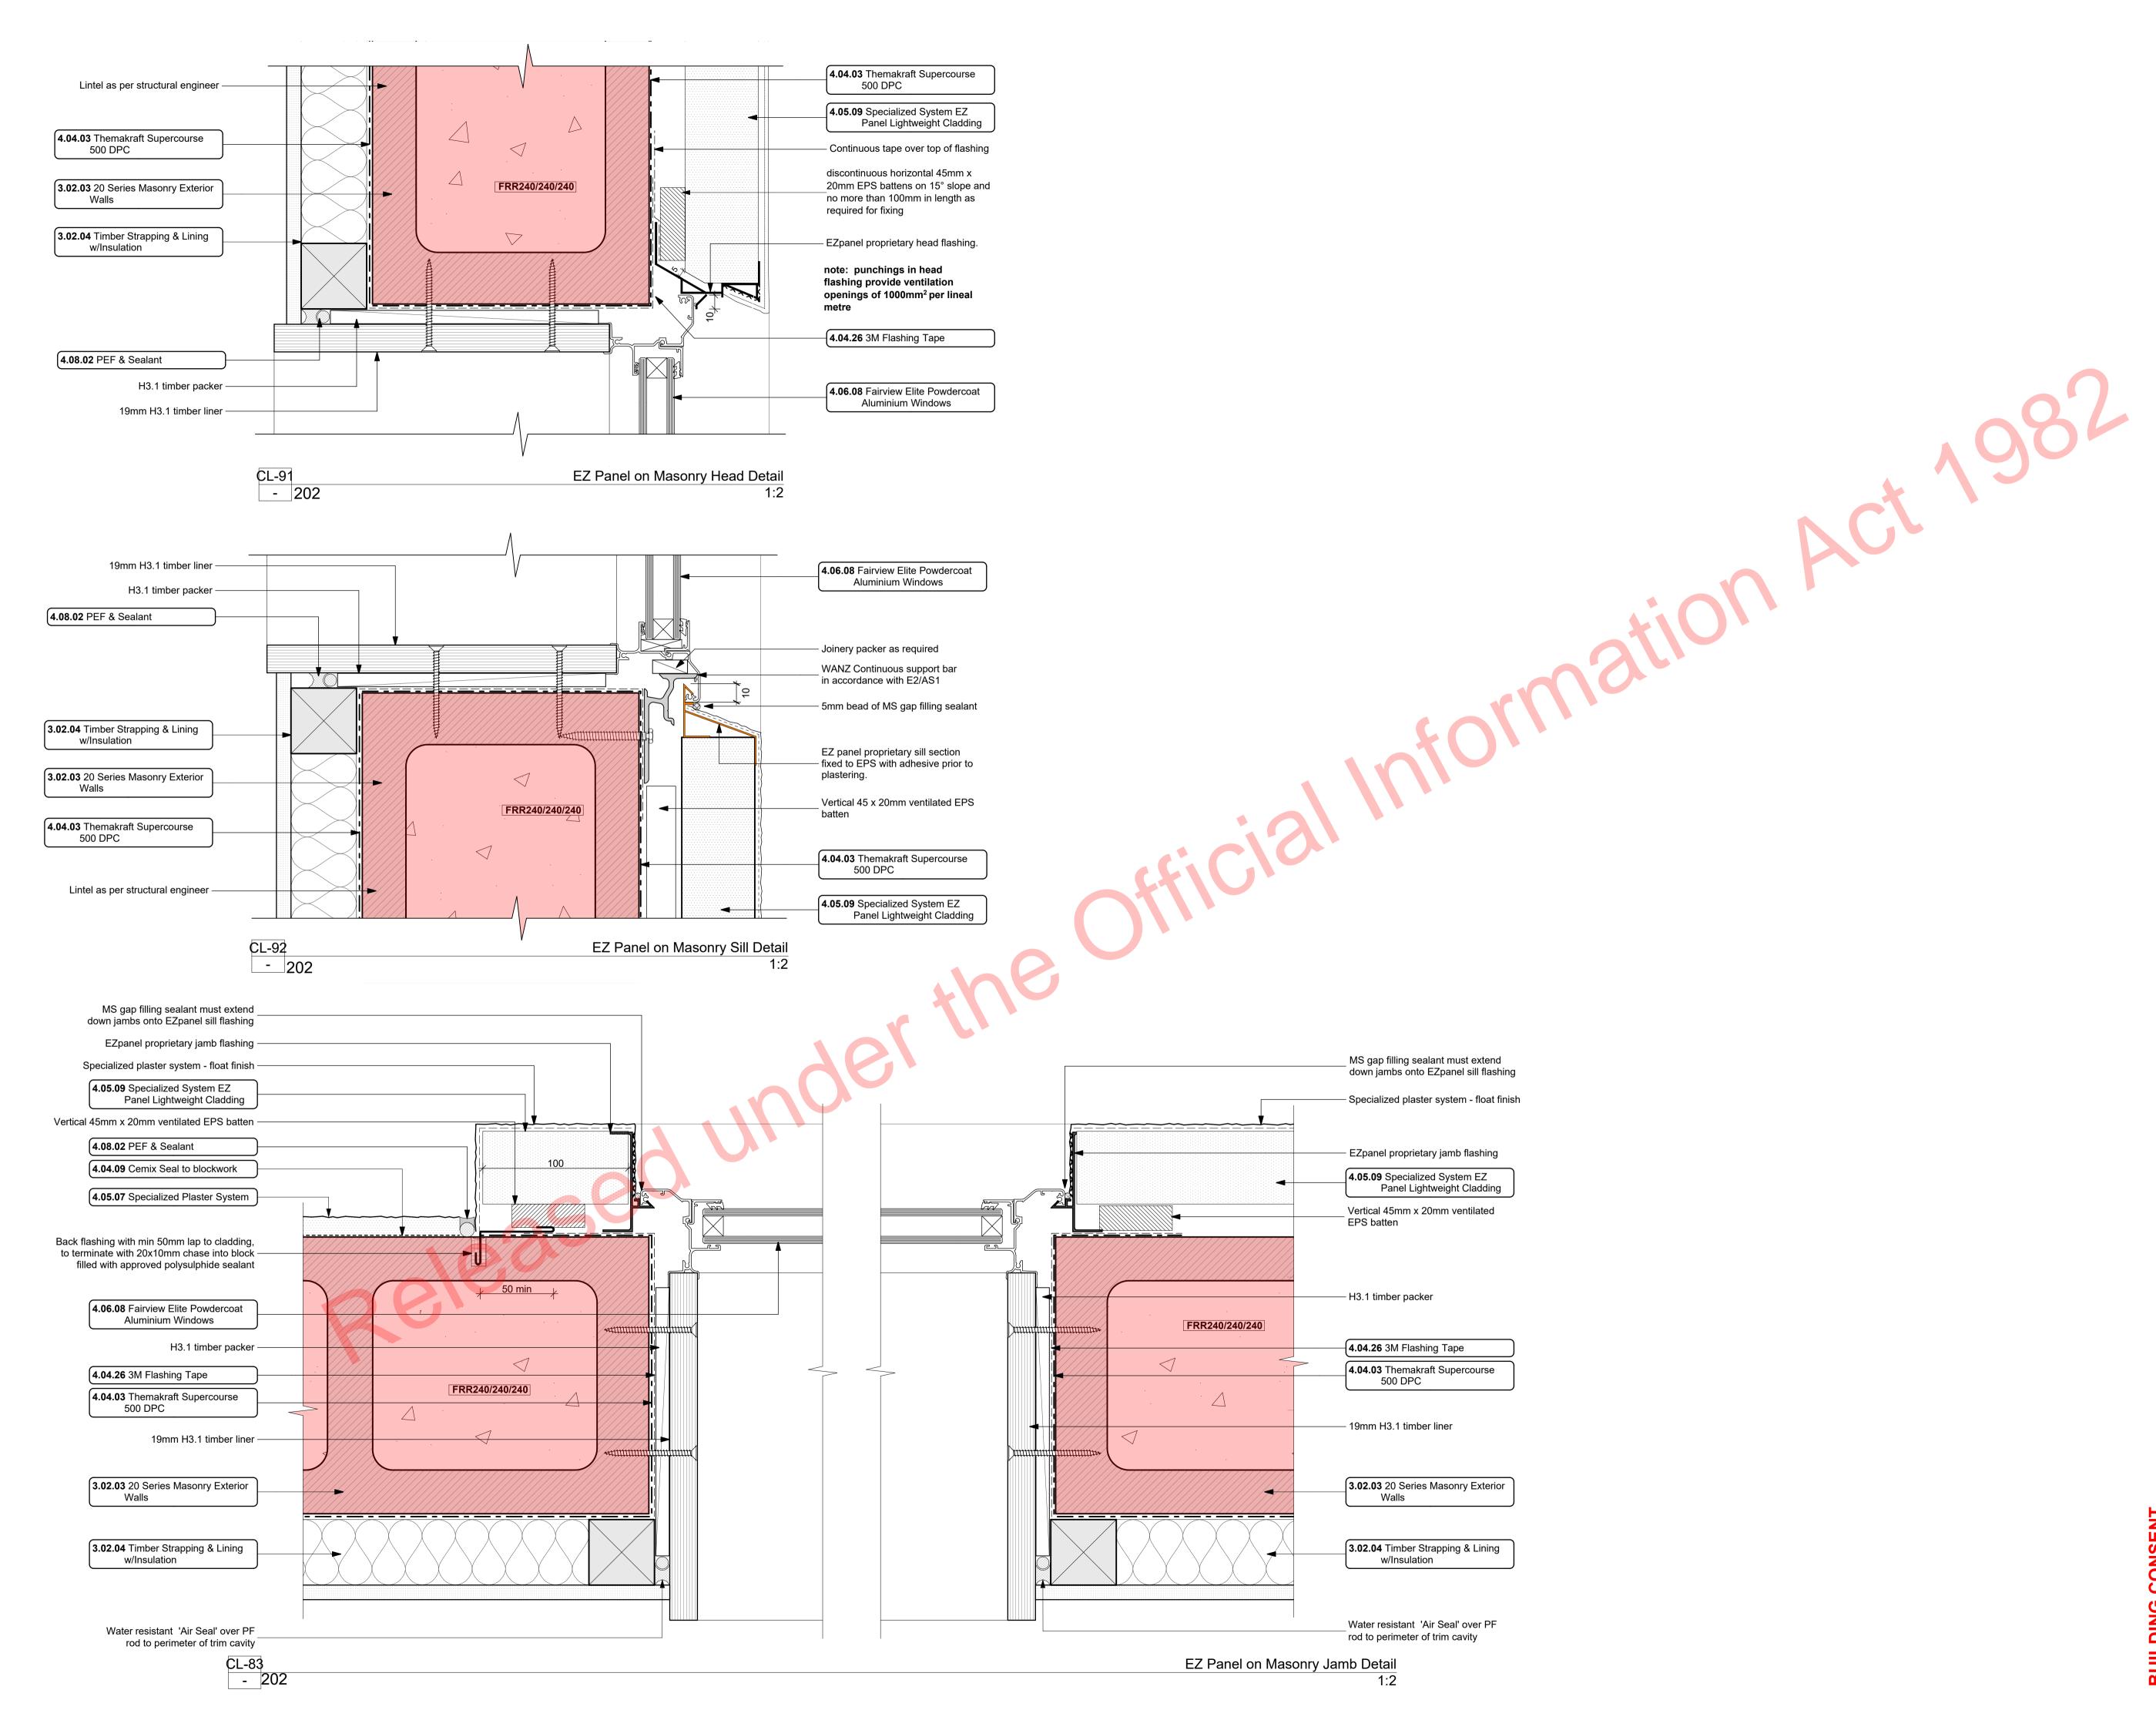

4.04.03

3 STRUCTURE

3.02.03

20 Series Masonry Exterior Walls
190mm Exterior masonry walls with
Solid plaster finish to exterior, refer to
engineering for reinforcing
requirements, Constructed in
accordance with NZS4210, refer to

requirements, Constructed in accordance with NZS4210, refer to specific notes for strapping and lining requirements. FRR240/240/240

Timber Strapping & Lining w/Insulation
Masonry block wall to be strapped with 50x50mm H1.2 battens on dpc at 600crs with Audex Greenstuff R1.3 40mm fibreglass insulation installed between with 10mm Gib board lining.

ENCLOSURE

Themakraft Supercourse 500 DPC
Thermakraft Supercourse 500 DPC
between concrete/concrete masonry
/aluminium and timber members.
Install strictly as per manufacturer's
specifications and details.

.04.09 Cemix Seal to blockwork
Cemix Brick and Block Sealer Applied
to block face prior to lining with brick
cladding. All in accordance with

cladding. All in accordance with manufacturers requirements.

4.04.26 3M Flashing Tape

Approved 3M 8067 All weather flashing tape as per manufacturer's specifications and details. Install strictly as per manufacturer's specifications and details.

Specialized Plaster System
Specialized plaster System over 20
series masonary blockwork, Float
textured finish by Specialized
Systems. Min 2 coats of paint. Colour
TBD. All installation in accordance
with manufacturers specifications.
System only for timber framed wing

4.05.09 Specialized System EZ Panel
Lightweight Cladding
Specialized System EZ Panel 50mm
autoclaved lightweight concrete
Facade System over 50x20mm High
Density EPS vertical cavity battens at
600crs max. Float textured finish by
Specialized Systems. Min 2 coats of
paint. Colour TBD. All installation in
accordance with manufacturers

framed wing walls.


4.06.08

Fairview Elite Powdercoat
Aluminium Windows
Elite Fairview Classic Residential 35
Powdercoated Aluminium Windows.
Colour as per Resource Consent
specifications. Double glazed with
paint grade radiata pine architraves.
Obscure glass to bathrooms, wc's and
ensuites. Refer to window and door
schedule. Confirm size on site prior to
manufacture. Install strictly as per
manufacturer's specifications and

details. Hardware TBC by client.

specifications. System only for timber

4.08.02 PEF & Sealant
PEF Backing rod and Sealant. Ensure
all laps and overhangs comply with
E2/AS1. Install strictly as per
manufacturer's specifications and

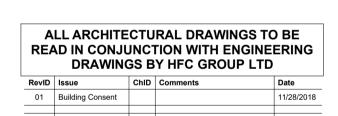





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project title:

Proposed Development for:

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Bonair Developments

at:

153 Bonair Cresent (Block B)
Silverdale, Auckland
sheet title:


Standard Masonry Details
drawn: KN checked: JM dwg n#:
iob n#: 2005


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scale: 1:2 @ A1

NOTE: Drawings are ½ scale @ A3

CAD ref: KrisindaBIM Server: CAL-BIM - BIMcloud Basic for ARCHICAD 21/Creative Arch/2005_Broadway Property Group_BLOCK B_BC




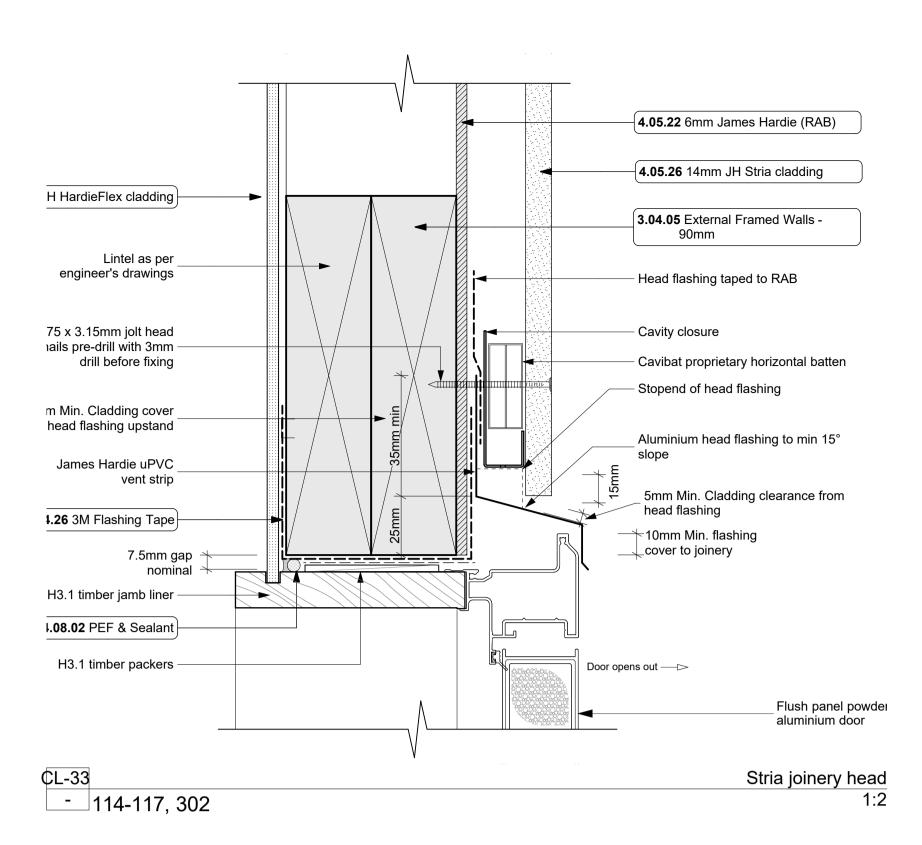


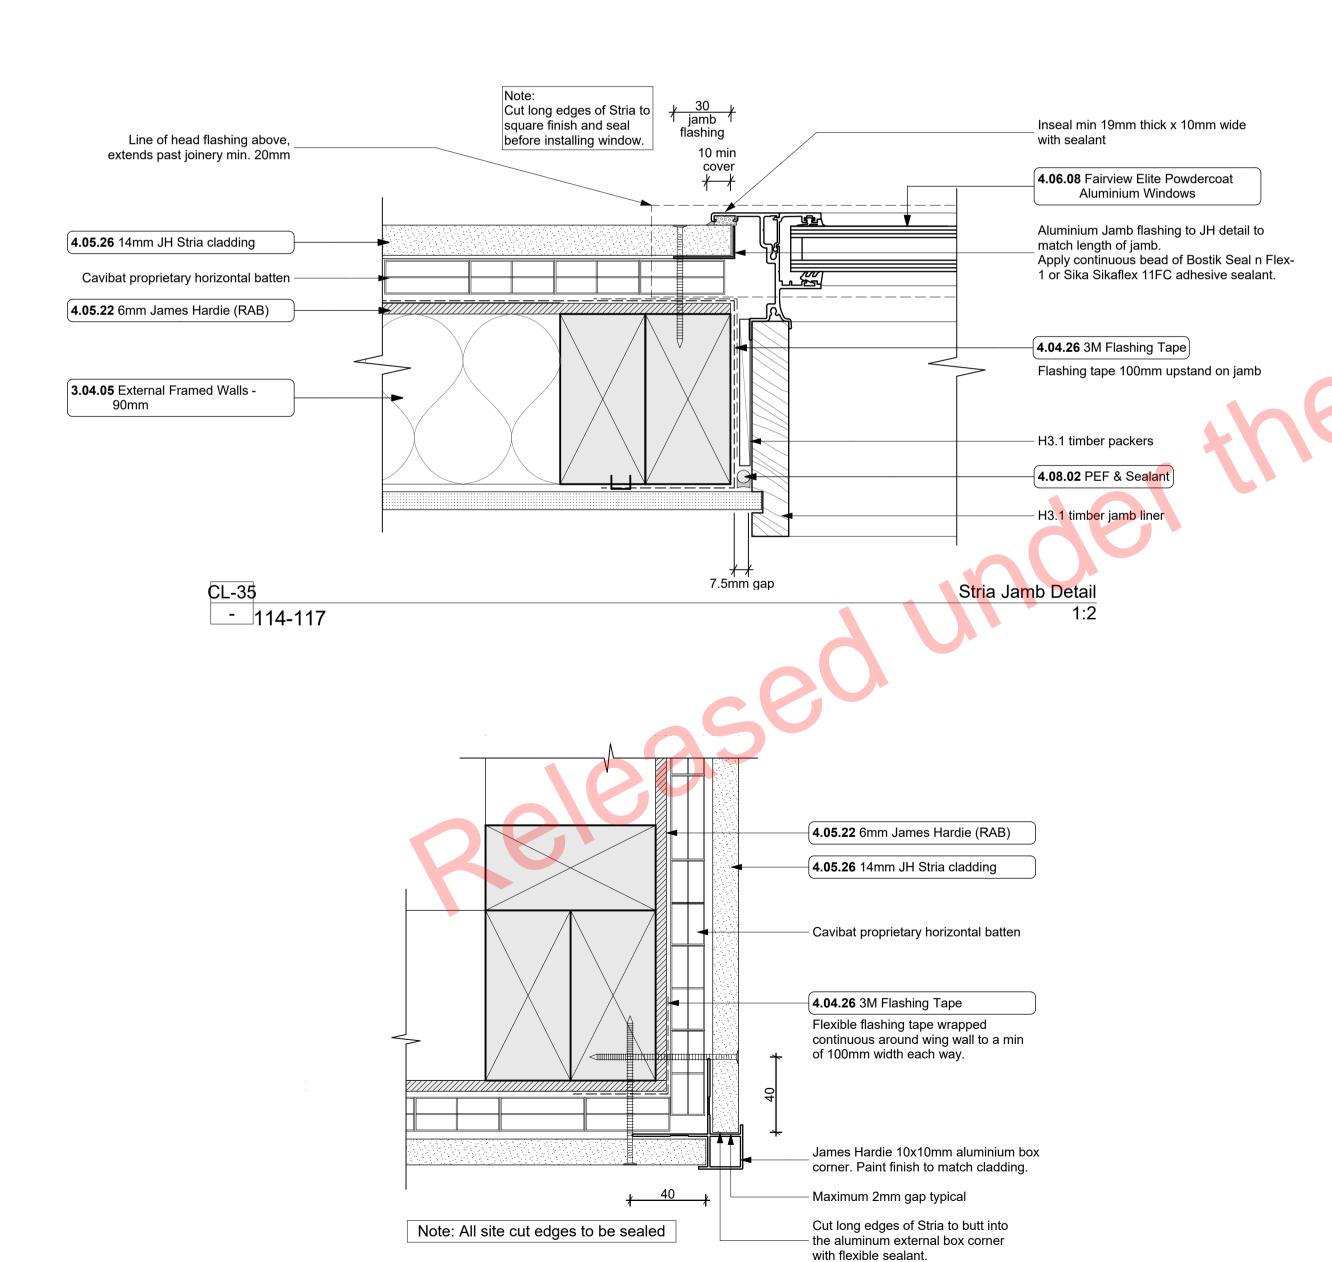Stria External corner

CL-32

_ 114-117

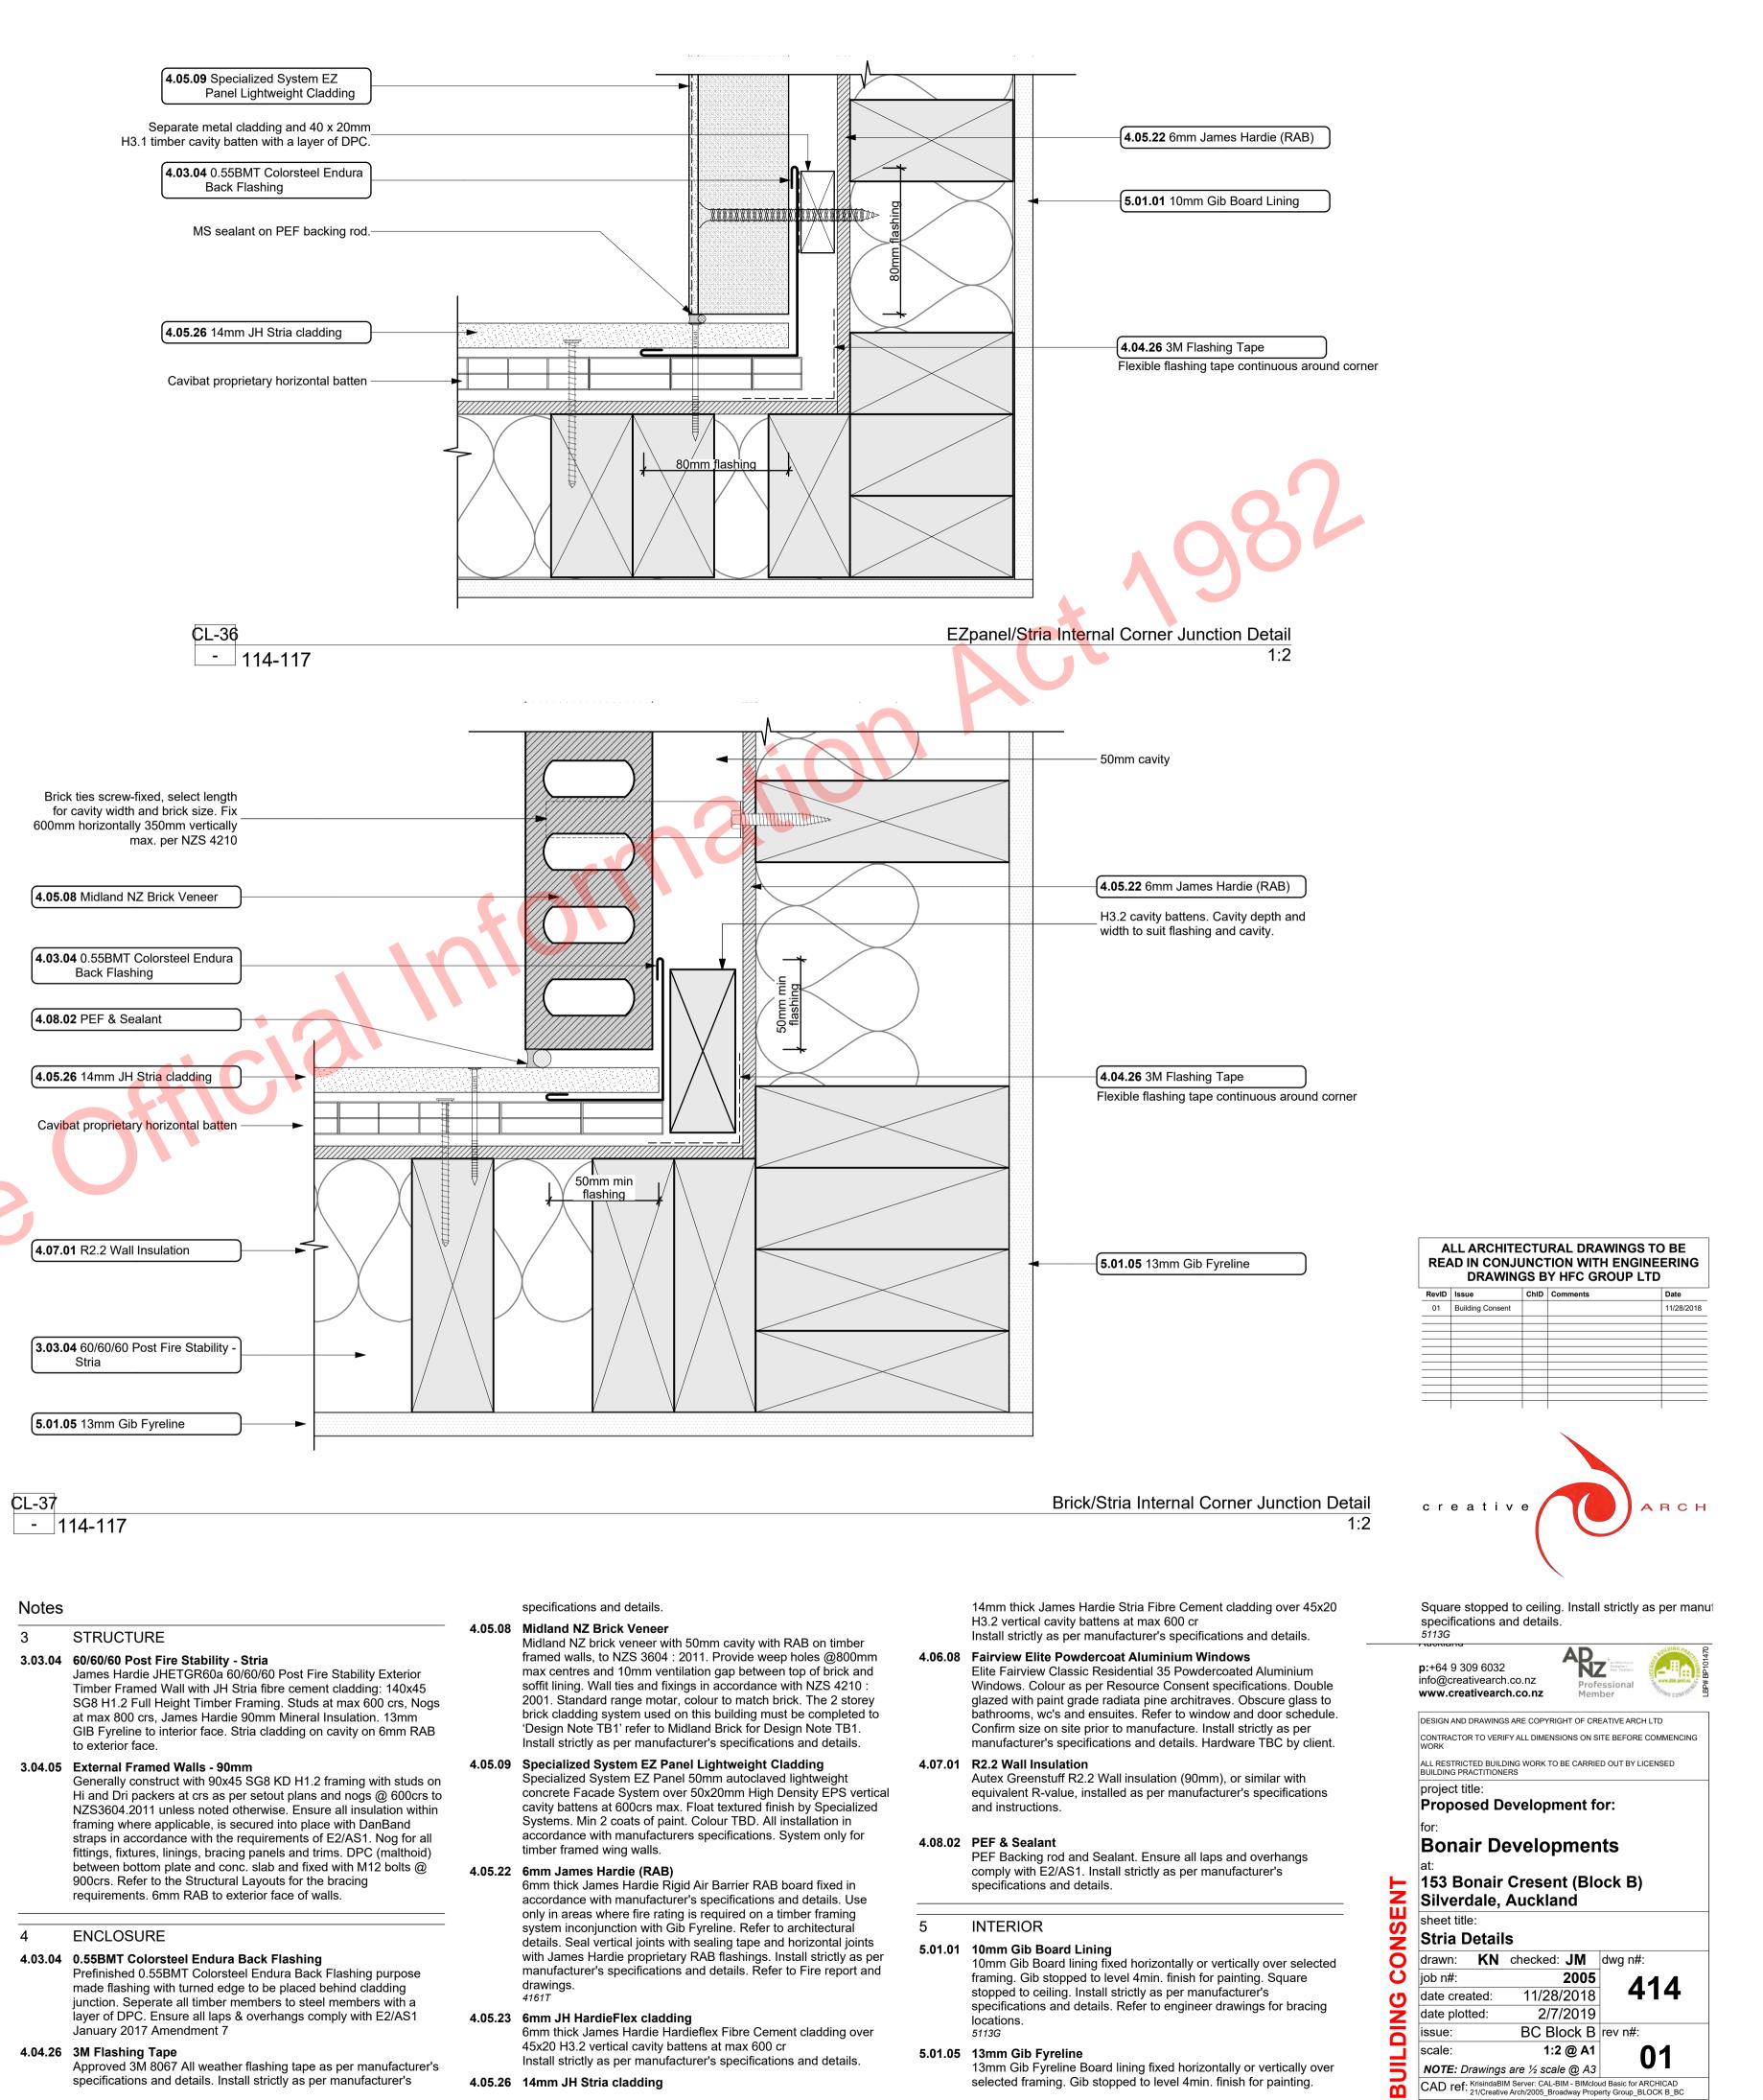

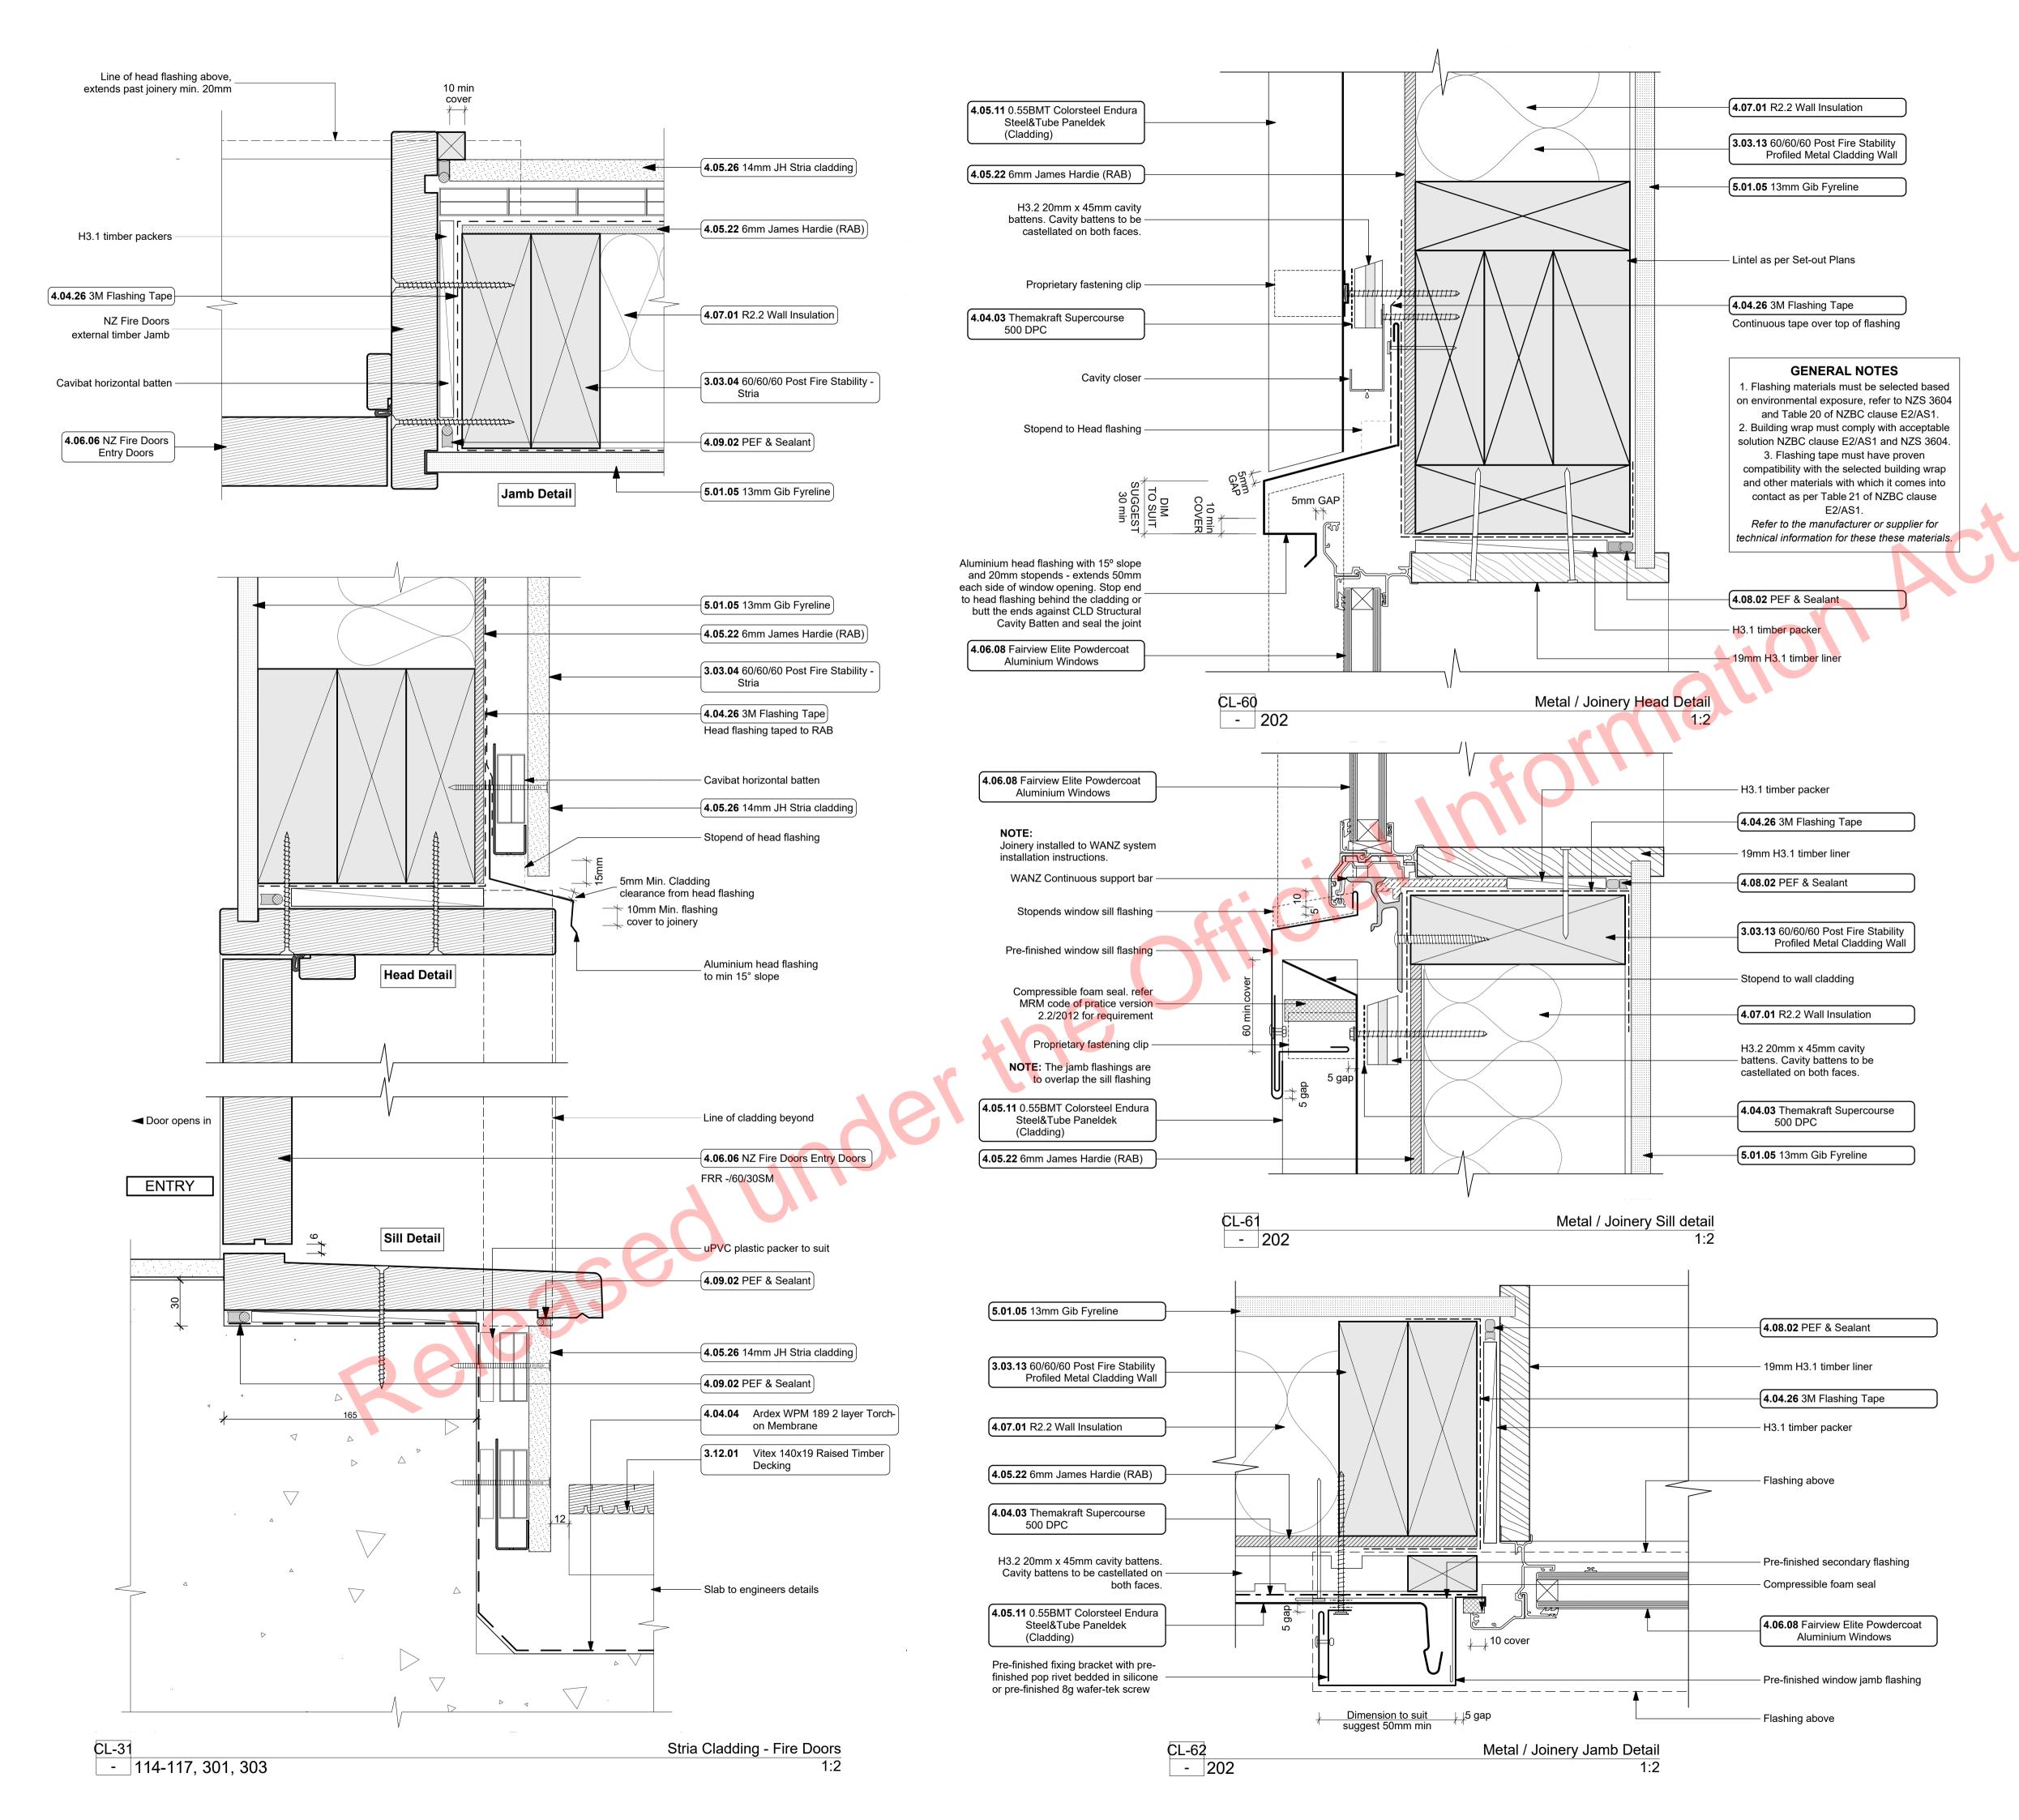

STRUCTURE

3.03.04 60/60/60 Post Fire Stability - Stria

James Hardie JHETGR60a 60/60/60 Post Fire Stability Exterior Timber Framed Wall with JH Stria fibre cement cladding: 140x45 SG8 H1.2 Full Height Timber Framing. Studs at max 600 crs, Nogs at max 800 crs, James Hardie 90mm Mineral Insulation. 13mm GIB Fyreline to interior face. Stria cladding on cavity on 6mm RAB to exterior face.

3.03.13 60/60/60 Post Fire Stability Profiled Metal Cladding Wall

James Hardie JHETGR60a 60/60/60 Post Fire Stability Exterior Timber Framed Wall with Profiled Metal Cladding: 140x45 SG8 H1.2 Full Height Timber Framing. Studs at max 600 crs, Nogs at max 800 crs, James Hardie 90mm Mineral Insulation. 13mm Gib Fyreline to min 800 AFFL, 13mm Standard Gib above to interior face. Profiled Metal cladding on cavity on

6mm RAB to exterior face.

3.12.01 Vitex 140x19 Raised Timber Decking Vitex 140x19 timber decking on raised Outdure Qwickbuild aluminium. Vitex decking system to have 3mm gaps, Selected coating applied to all faces.

ENCLOSURE

4.04.03 Themakraft Supercourse 500 DPC

Thermakraft Supercourse 500 DPC between concrete/concrete masonry /aluminium and timber members. Install strictly as per manufacturer's specifications and details.

4.04.04 Ardex WPM 189 2 layer Torch-on Membrane

Ardex WPM 189 2 layer Torch-on Membrane installed strictly in accordance with manufacturers requirements. Dual Layer system to decks below raised decking

4.04.26 3M Flashing Tape

Approved 3M 8067 All weather flashing tape as per manufacturer's specifications and details. Install strictly as per manufacturer's specifications and details.

4.05.11 0.55BMT Colorsteel Endura Steel&Tube Paneldek (Cladding)
0.55BMT Colorsteel Endura Steel&Tube Paneldek vertical cladding. Fix over separation DPC over 20x45 H3.2 horizontal timber cavity battens at max 600crs. Cavity battens to be castellated on both faces to provide drainage and ventilation and must be used horizontally only. Fix cladding with S&T concealed fixing clip. Install strictly as per manufacturer's specifications and details.

4.05.22 6mm James Hardie (RAB)

6mm thick James Hardie Rigid Air Barrier RAB board fixed in accordance with manufacturer's specifications and details. Use only in areas where fire rating is required on a timber framing system inconjunction with Gib Fyreline. Refer to architectural details. Seal vertical joints with sealing tape and horizontal joints with James Hardie proprietary RAB flashings. Install strictly as per manufacturer's specifications and details. Refer to Fire report and drawings.

4.05.26 14mm JH Stria cladding

14mm thick James Hardie Stria Fibre Cement cladding over 45x20 H3.2 vertical cavity battens at max 600 cr Install strictly as per manufacturer's specifications and details.

4.06.06 NZ Fire Doors Entry Doors

NZ Fire Doors Entry Doors (-/60/30SM) with colour as per Resource Consent specifications. Rebate 30mm deep and size must be confirmed with manufacturer prior to rebate installation. Include paint grade radiata pine architraves. Refer to window and door schedule. Confirm size on site prior to manufacture. Install strictly as per manufacturer's specifications and details. Hardware TBC by client.

4.06.08 Fairview Elite Powdercoat Aluminium Windows

Elite Fairview Classic Residential 35 Powdercoated Aluminium Windows. Colour as per Resource Consent specifications. Double glazed with paint grade radiata pine architraves. Obscure glass to bathrooms, wc's and ensuites. Refer to window and door schedule. Confirm size on site prior to manufacture. Install strictly as per manufacturer's specifications and details. Hardware TBC by client.

4.07.01 R2.2 Wall Insulation


Autex Greenstuff R2.2 Wall insulation (90mm), or similar with equivalent R-value, installed as per manufacturer's specifications and instructions.

4.08.02 PEF & Sealant PEF Backing rod and Sealant. Ensure all laps and overhangs comply with E2/AS1. Install

strictly as per manufacturer's specifications and details. INTERIOR

5.01.05 13mm Gib Fyreline

13mm Gib Fyreline Board lining fixed horizontally or vertically over selected framing. Gib stopped to level 4min. finish for painting. Square stopped to ceiling. Install strictly as per manufacturer's specifications and details.

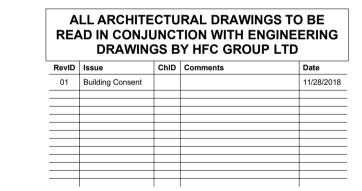



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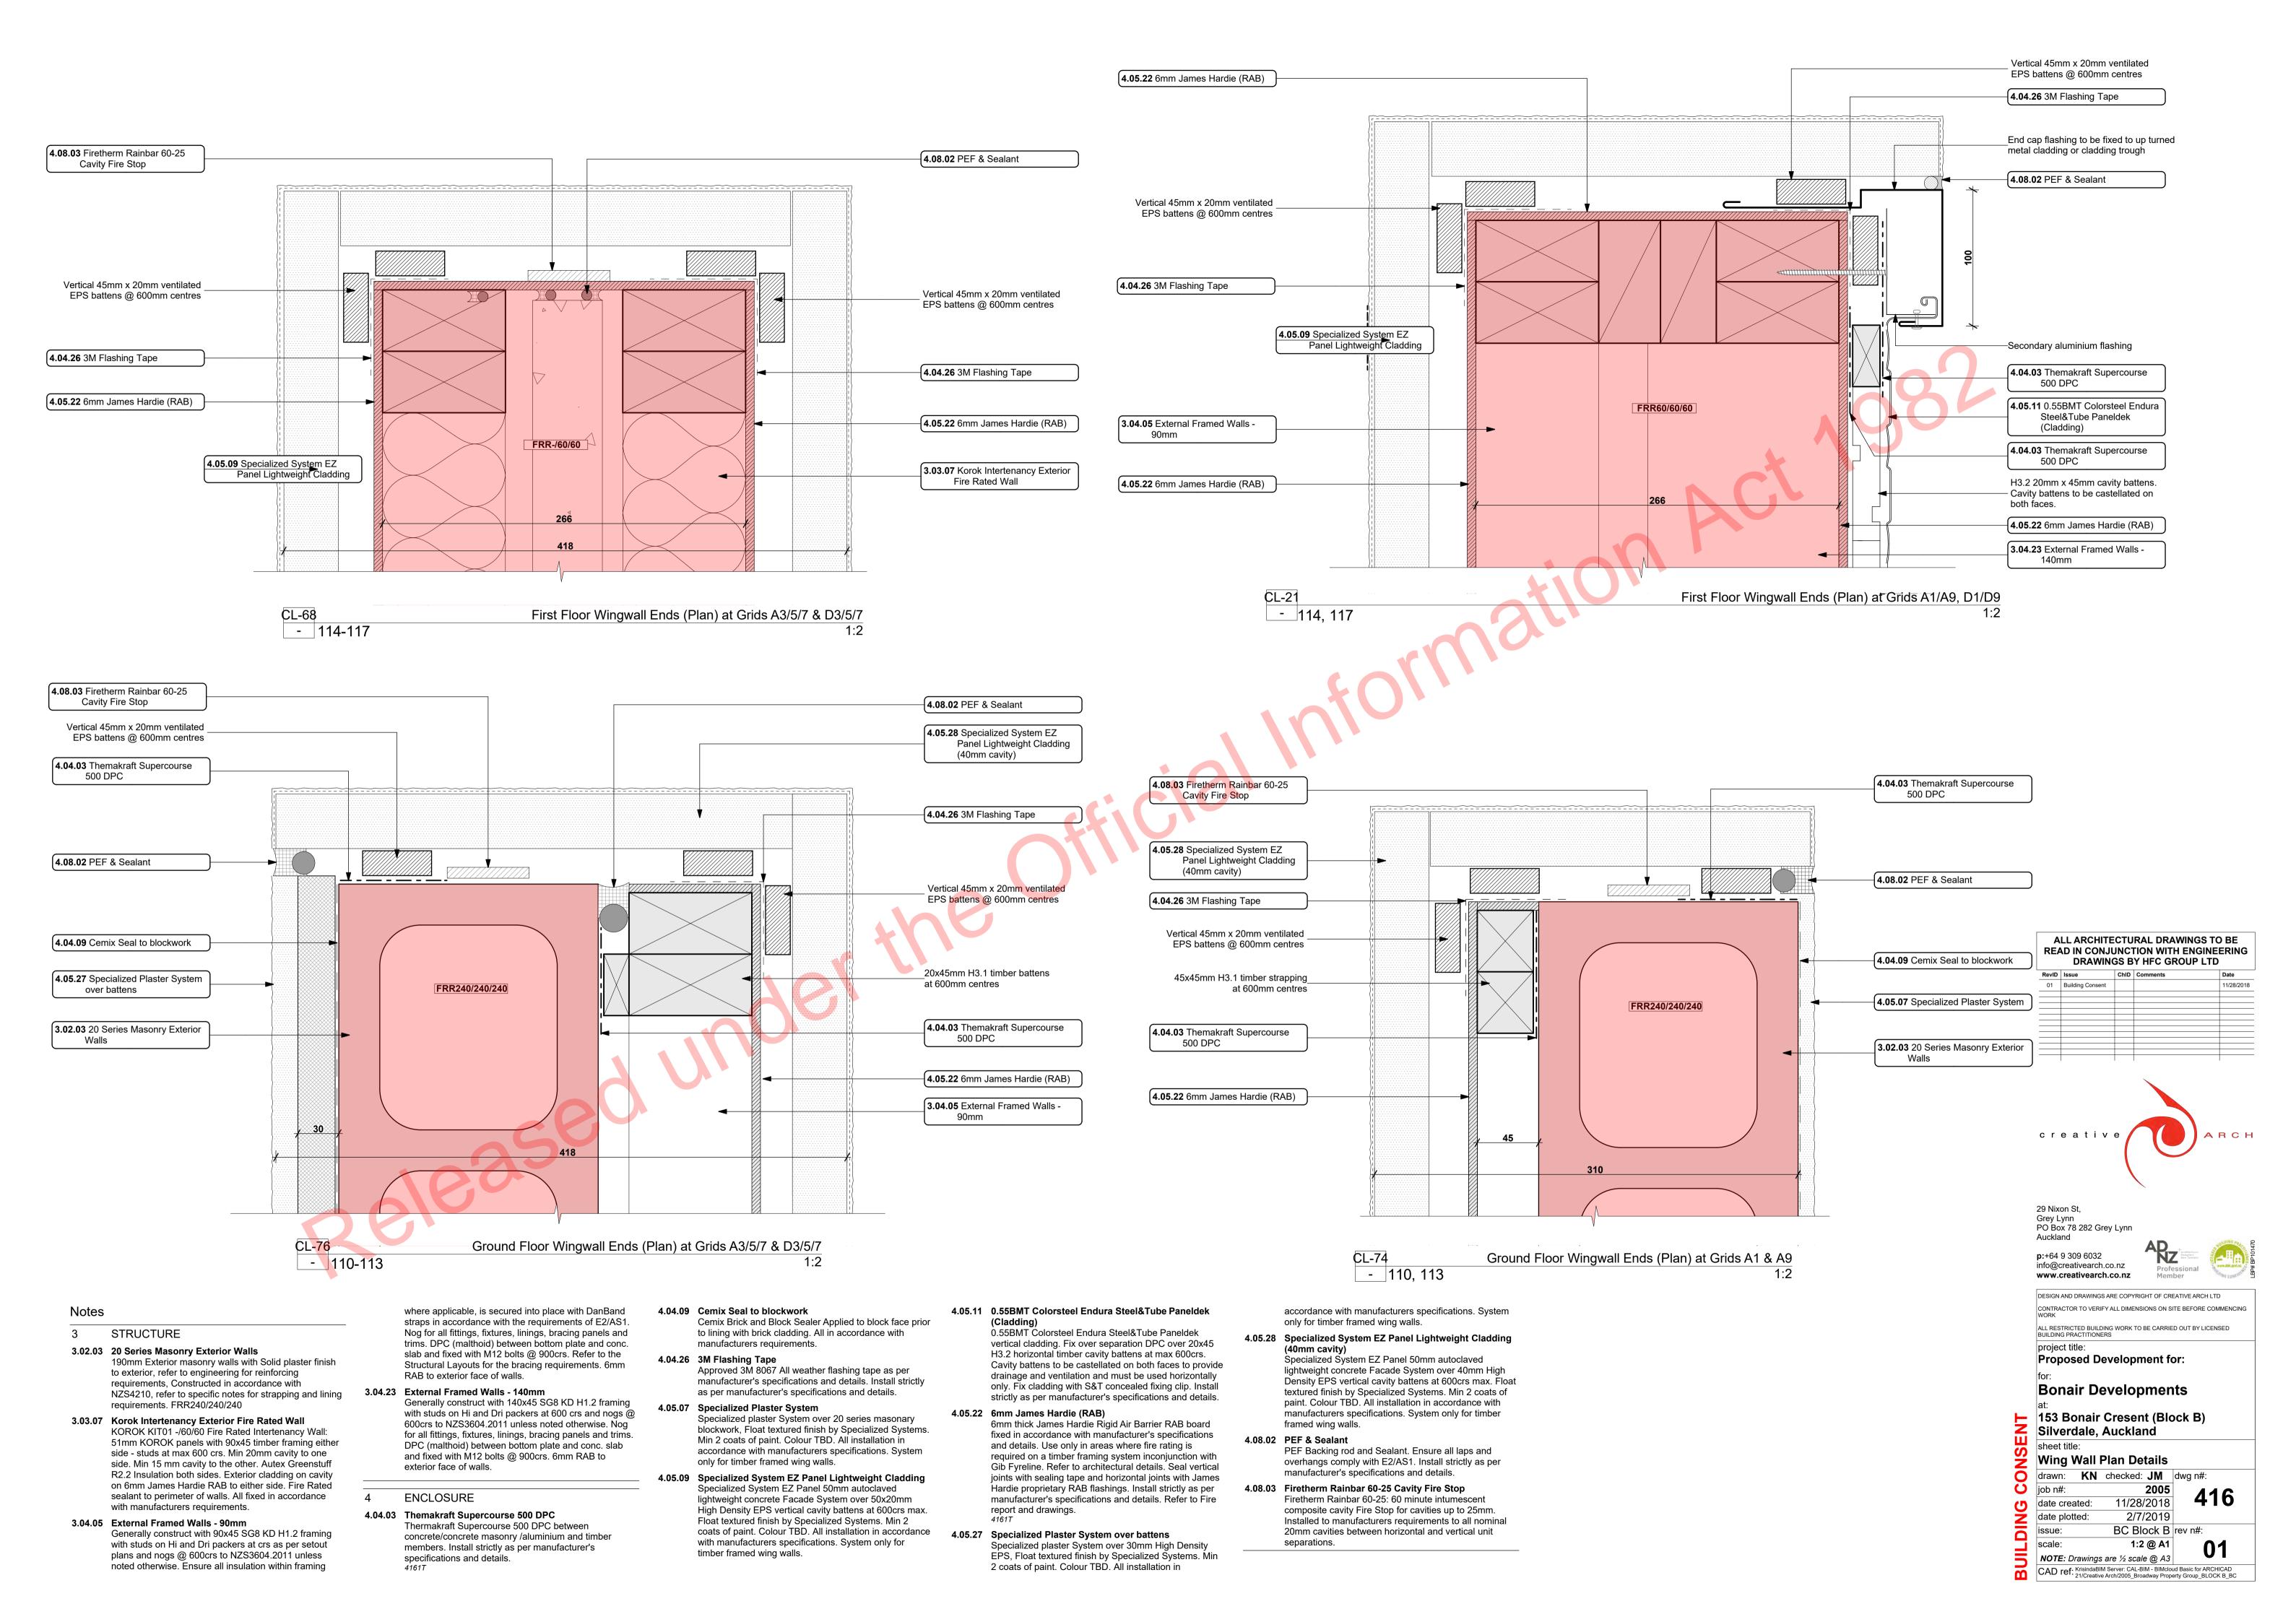
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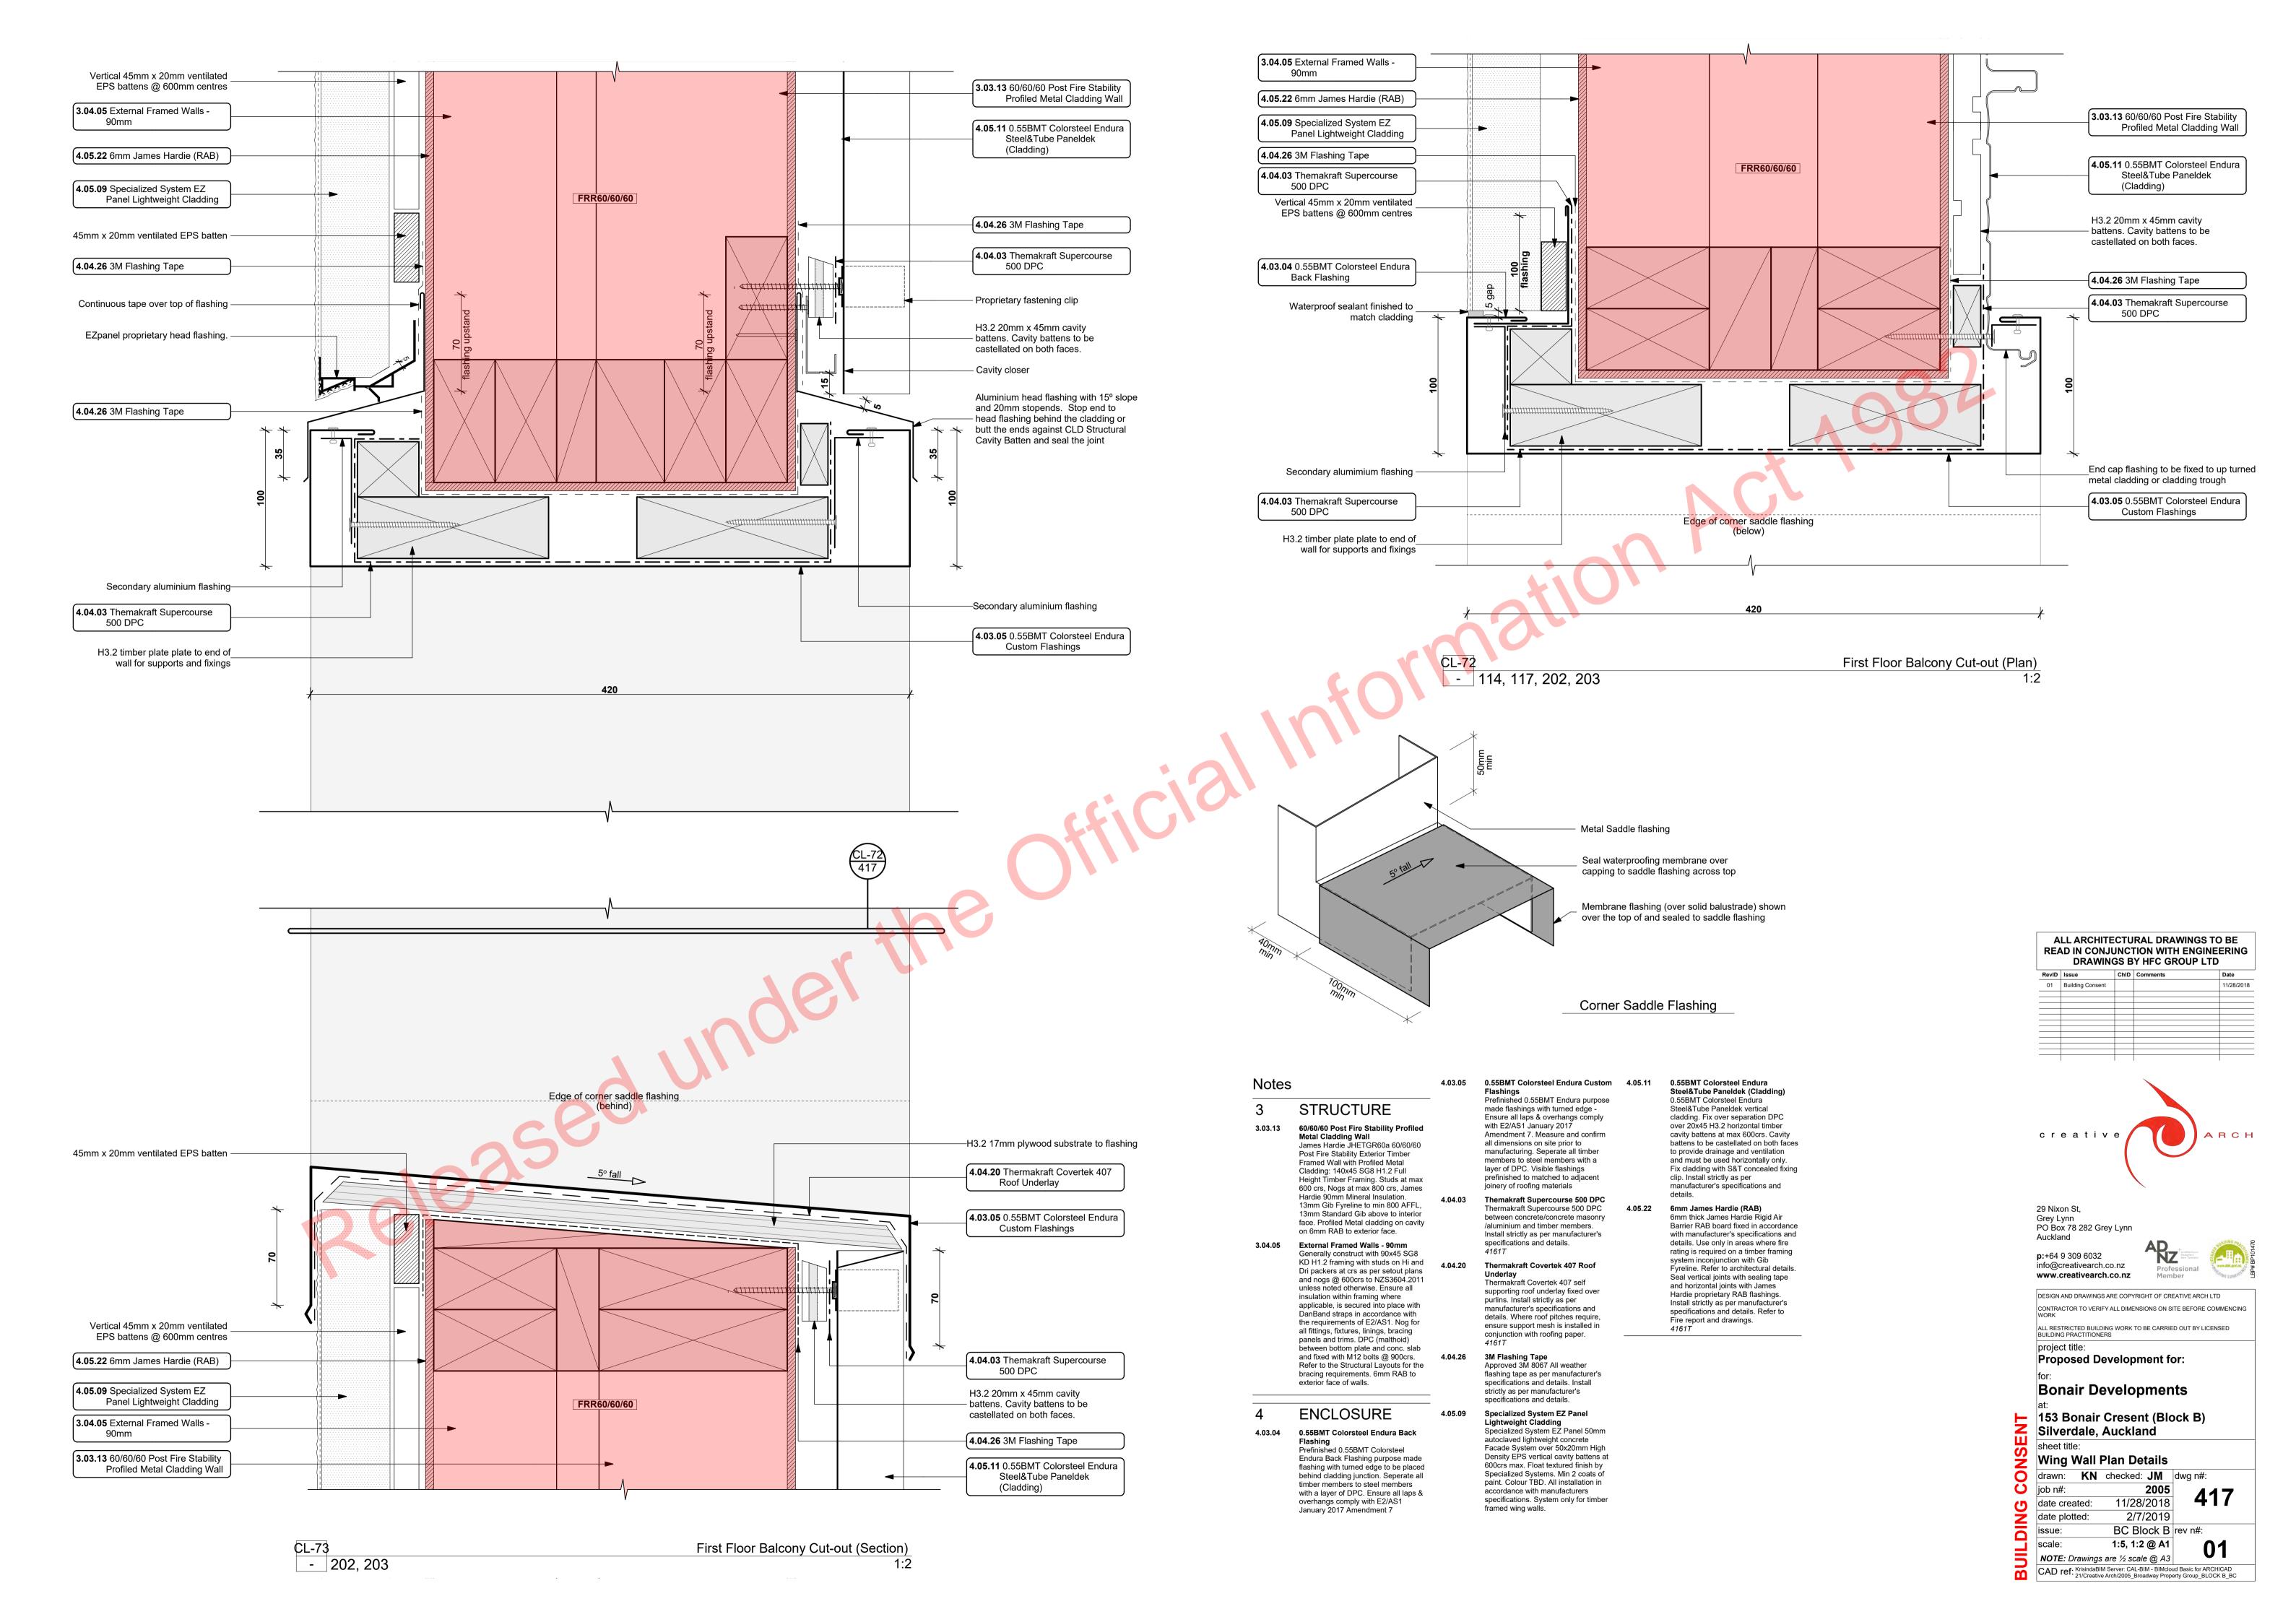
Bonair Developments


 153 Bonair Cresent (Block B) Silverdale, Auckland sheet title: Stria & Metal Cladding Details


drawn: KN checked: JM dwg n#: 2005 11/28/2018 date created: 2/7/2019

BC Block B rev n#: 1:2 @ A1 NOTE: Drawings are ½ scale @ A3 CAD ref: KrisindaBIM Server: CAL-BIM - BIMCloud Basic for ARCHICAD 21/Creative Arch/2005_Broadway Property Group_BLOCK B_BC





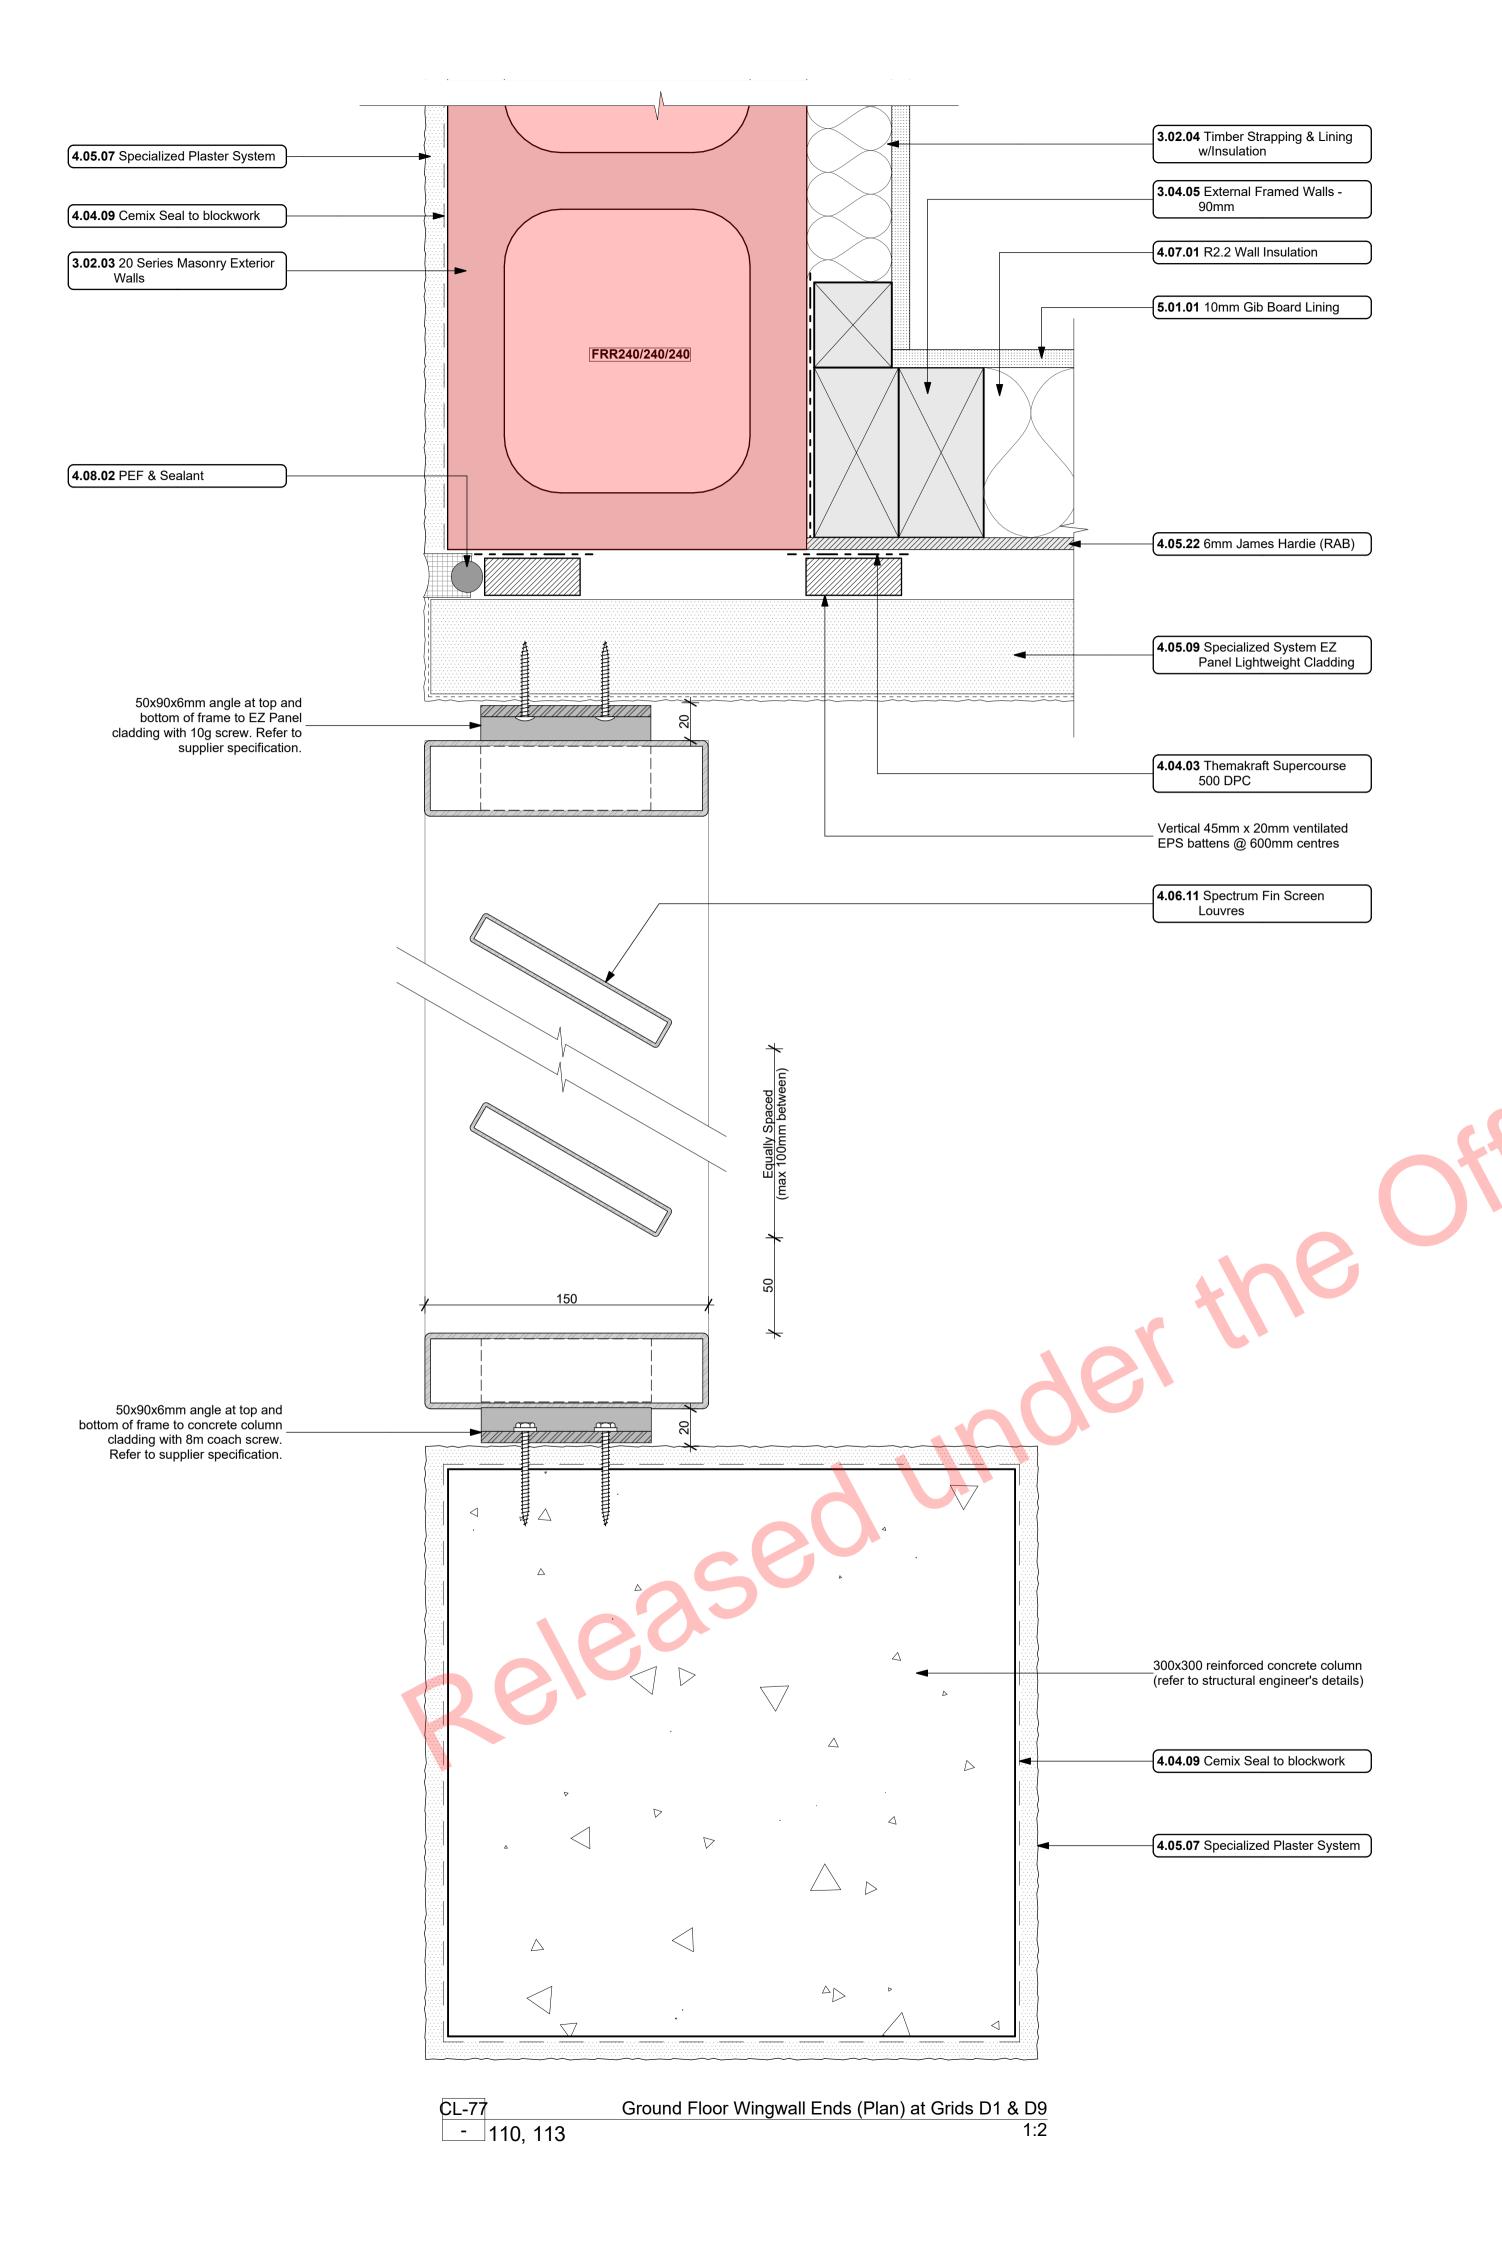

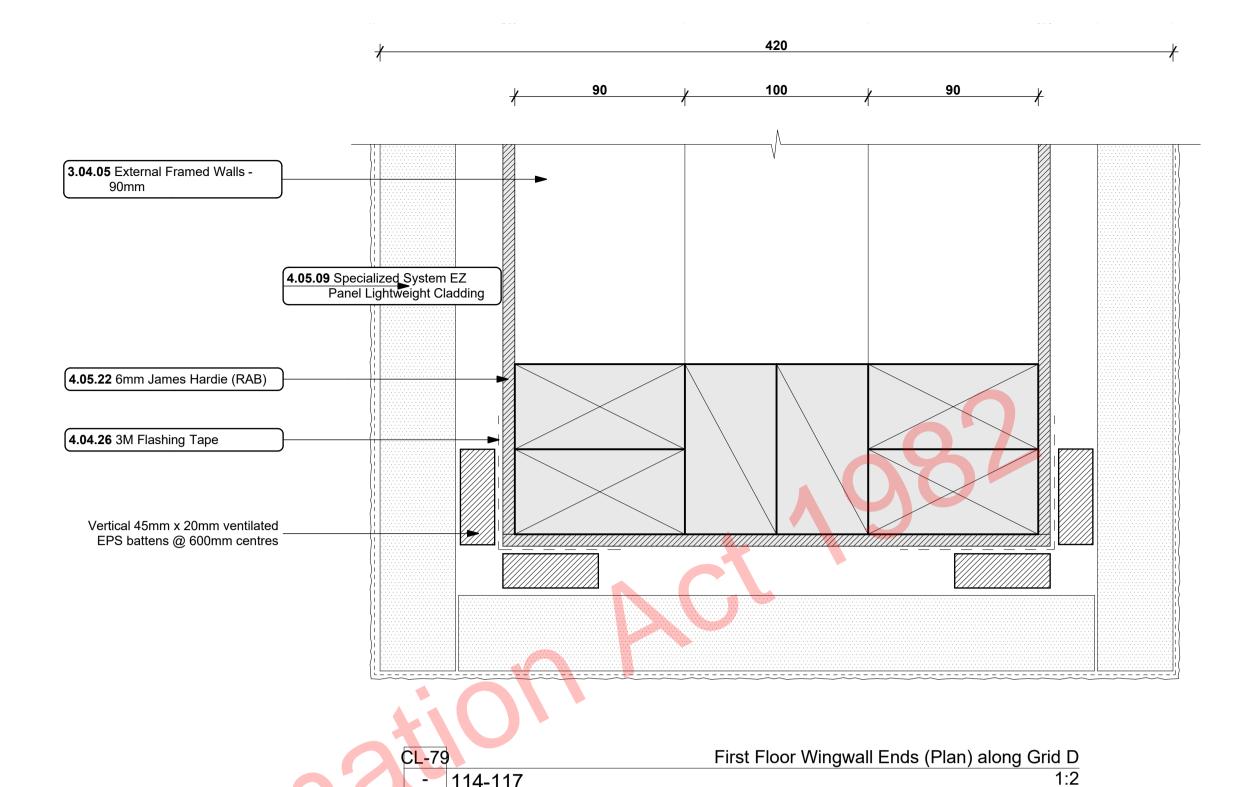

3 STRUCTURE

3.02.03 20 Series Masonry Exterior Walls

190mm Exterior masonry walls with Solid plaster finish to exterior, refer to engineering for reinforcing requirements, Constructed in accordance with NZS4210, refer to specific notes for strapping and lining requirements. FRR240/240/240

3.02.04 Timber Strapping & Lining w/Insulation

Masonry block wall to be strapped with 50x50mm H1.2 battens on dpc at 600crs with Audex Greenstuff R1.3 40mm fibreglass insulation installed between with 10mm Gib board lining.

3.04.05 External Framed Walls - 90mm

Generally construct with 90x45 SG8 KD H1.2 framing with studs on Hi and Dri packers at crs as per setout plans and nogs @ 600crs to NZS3604.2011 unless noted otherwise. Ensure all insulation within framing where applicable, is secured into place with DanBand straps in accordance with the requirements of E2/AS1. Nog for all fittings, fixtures, linings, bracing panels and trims. DPC (malthoid) between bottom plate and conc. slab and fixed with M12 bolts @ 900crs. Refer to the Structural Layouts for the bracing requirements. 6mm RAB to exterior face of walls.

ENCLOSURE

4.04.03 Themakraft Supercourse 500 DPC

Thermakraft Supercourse 500 DPC between concrete/concrete masonry /aluminium and timber members. Install strictly as per manufacturer's specifications and details.

4.04.09 Cemix Seal to blockwork

Cemix Brick and Block Sealer Applied to block face prior to lining with brick cladding. All in accordance with manufacturers requirements.

4.04.26 3M Flashing Tape

Approved 3M 8067 All weather flashing tape as per manufacturer's specifications and details. Install strictly as per manufacturer's specifications and details.

4.05.07 Specialized Plaster System

Specialized plaster System over 20 series masonary blockwork, Float textured finish by Specialized Systems. Min 2 coats of paint. Colour TBD. All installation in accordance with manufacturers specifications. System only for timber framed wing

4.05.09 Specialized System EZ Panel Lightweight Cladding

Specialized System EZ Panel 50mm autoclaved lightweight concrete Facade System over 50x20mm High Density EPS vertical cavity battens at 600crs max. Float textured finish by Specialized Systems. Min 2 coats of paint. Colour TBD. All installation in accordance with manufacturers specifications. System only for timber framed wing

4.05.22 6mm James Hardie (RAB)

6mm thick James Hardie Rigid Air Barrier RAB board fixed in accordance with manufacturer's specifications and details. Use only in areas where fire rating is required on a timber framing system inconjunction with Gib Fyreline. Refer to architectural details. Seal vertical joints with sealing tape and horizontal joints with James Hardie proprietary RAB flashings. Install strictly as per manufacturer's specifications and details. Refer to Fire report and drawings.

4.06.11 Spectrum Fin Screen Louvres

Spectrum 115x17 aluminum RHS fins louvre system fixed to 115x3 Aluminium plate top and bottom fixed to underside of concreet beam / deck edge. Powdercoated finish to match joinery. Install strictly as per manufacturer's specifications and details.

4.07.01 R2.2 Wall Insulation Autex Greenstuff R2.2 Wall insulation (90mm), or similar with equivalent R-value,

installed as per manufacturer's specifications and instructions.


4.08.02 PEF & Sealant

PEF Backing rod and Sealant. Ensure all laps and overhangs comply with E2/AS1. Install strictly as per manufacturer's specifications and details.

INTERIOR

5.01.01 10mm Gib Board Lining

10mm Gib Board lining fixed horizontally or vertically over selected framing. Gib stopped to level 4min. finish for painting. Square stopped to ceiling. Install strictly as per manufacturer's specifications and details. Refer to engineer drawings for bracing locations. 5113G

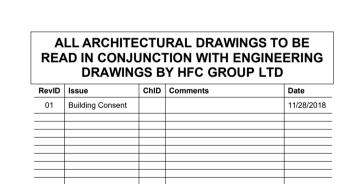



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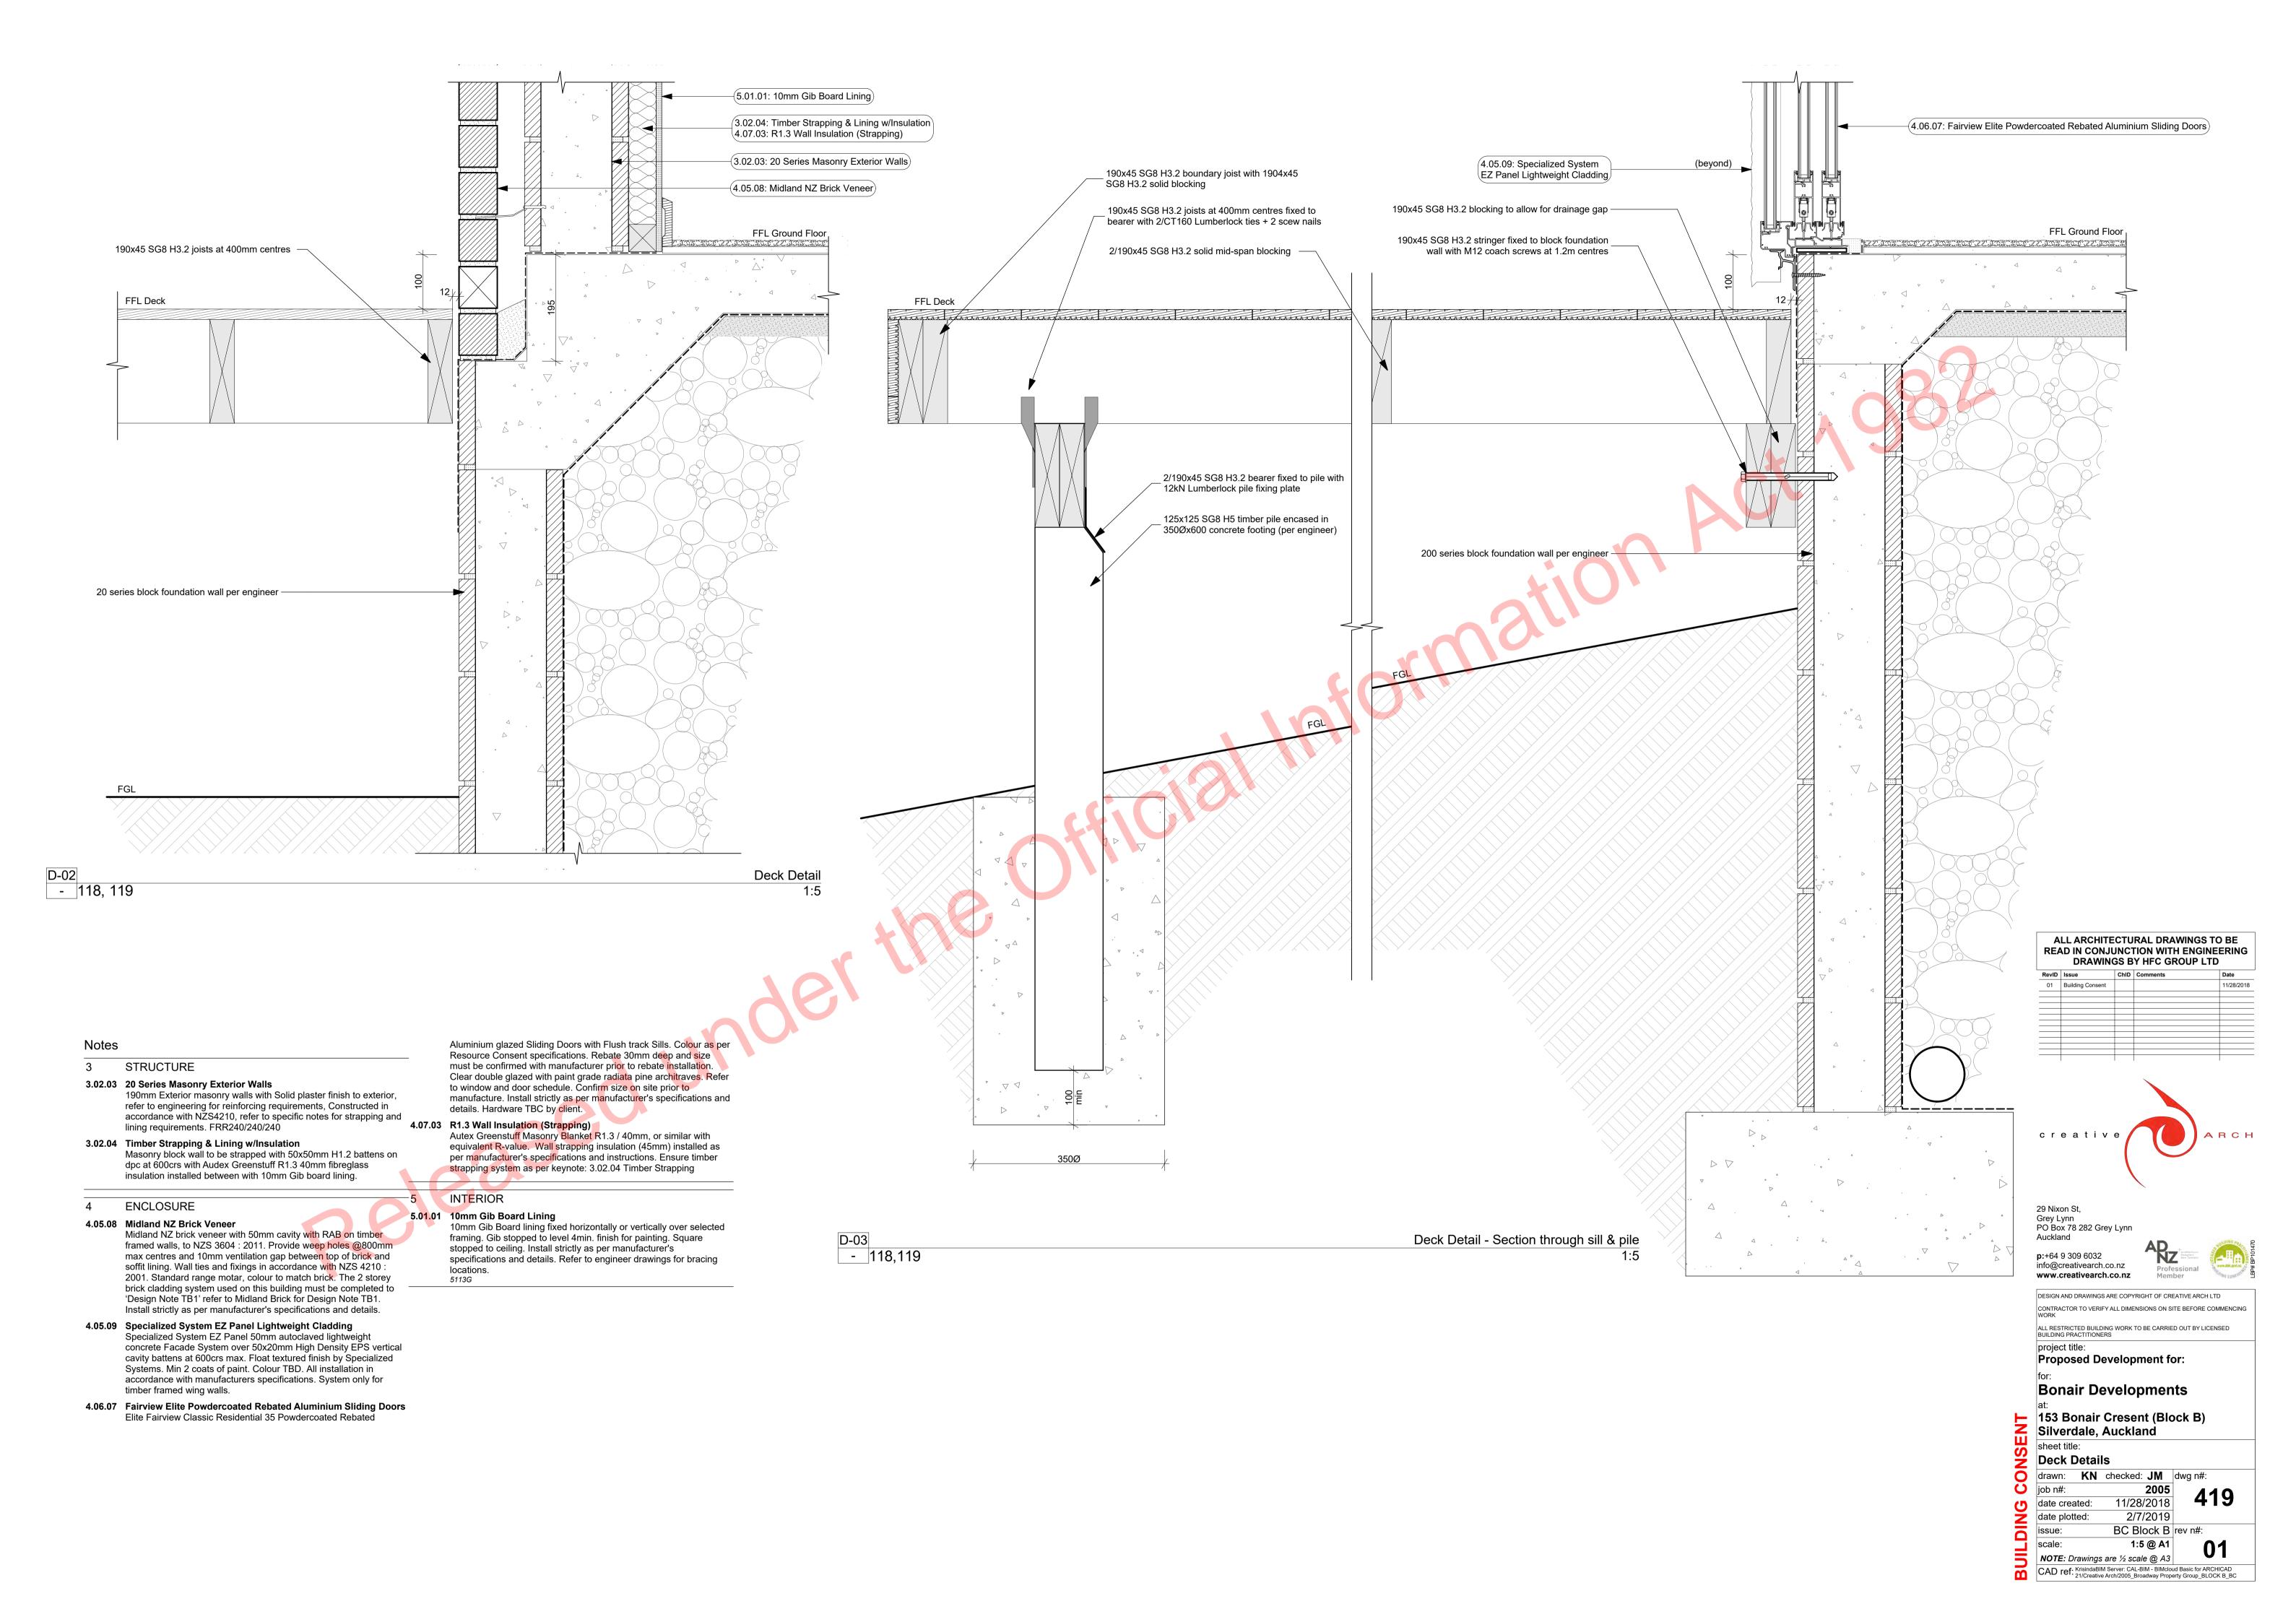
Bonair Developments


153 Bonair Cresent (Block B) Silverdale, Auckland sheet title:


Wing Wall PLan Details drawn: **KN** checked: **JM** dwg n#: date created: 11/28/2018


2/7/2019 BC Block B rev n#: 1:2 @ A1

scale: NOTE: Drawings are ½ scale @ A3 CAD ref. KrisindaBIM Server: CAL-BIM - BIMcloud Basic for ARCHICAD 21/Creative Arch/2005_Broadway Property Group_BLOCK B_BC



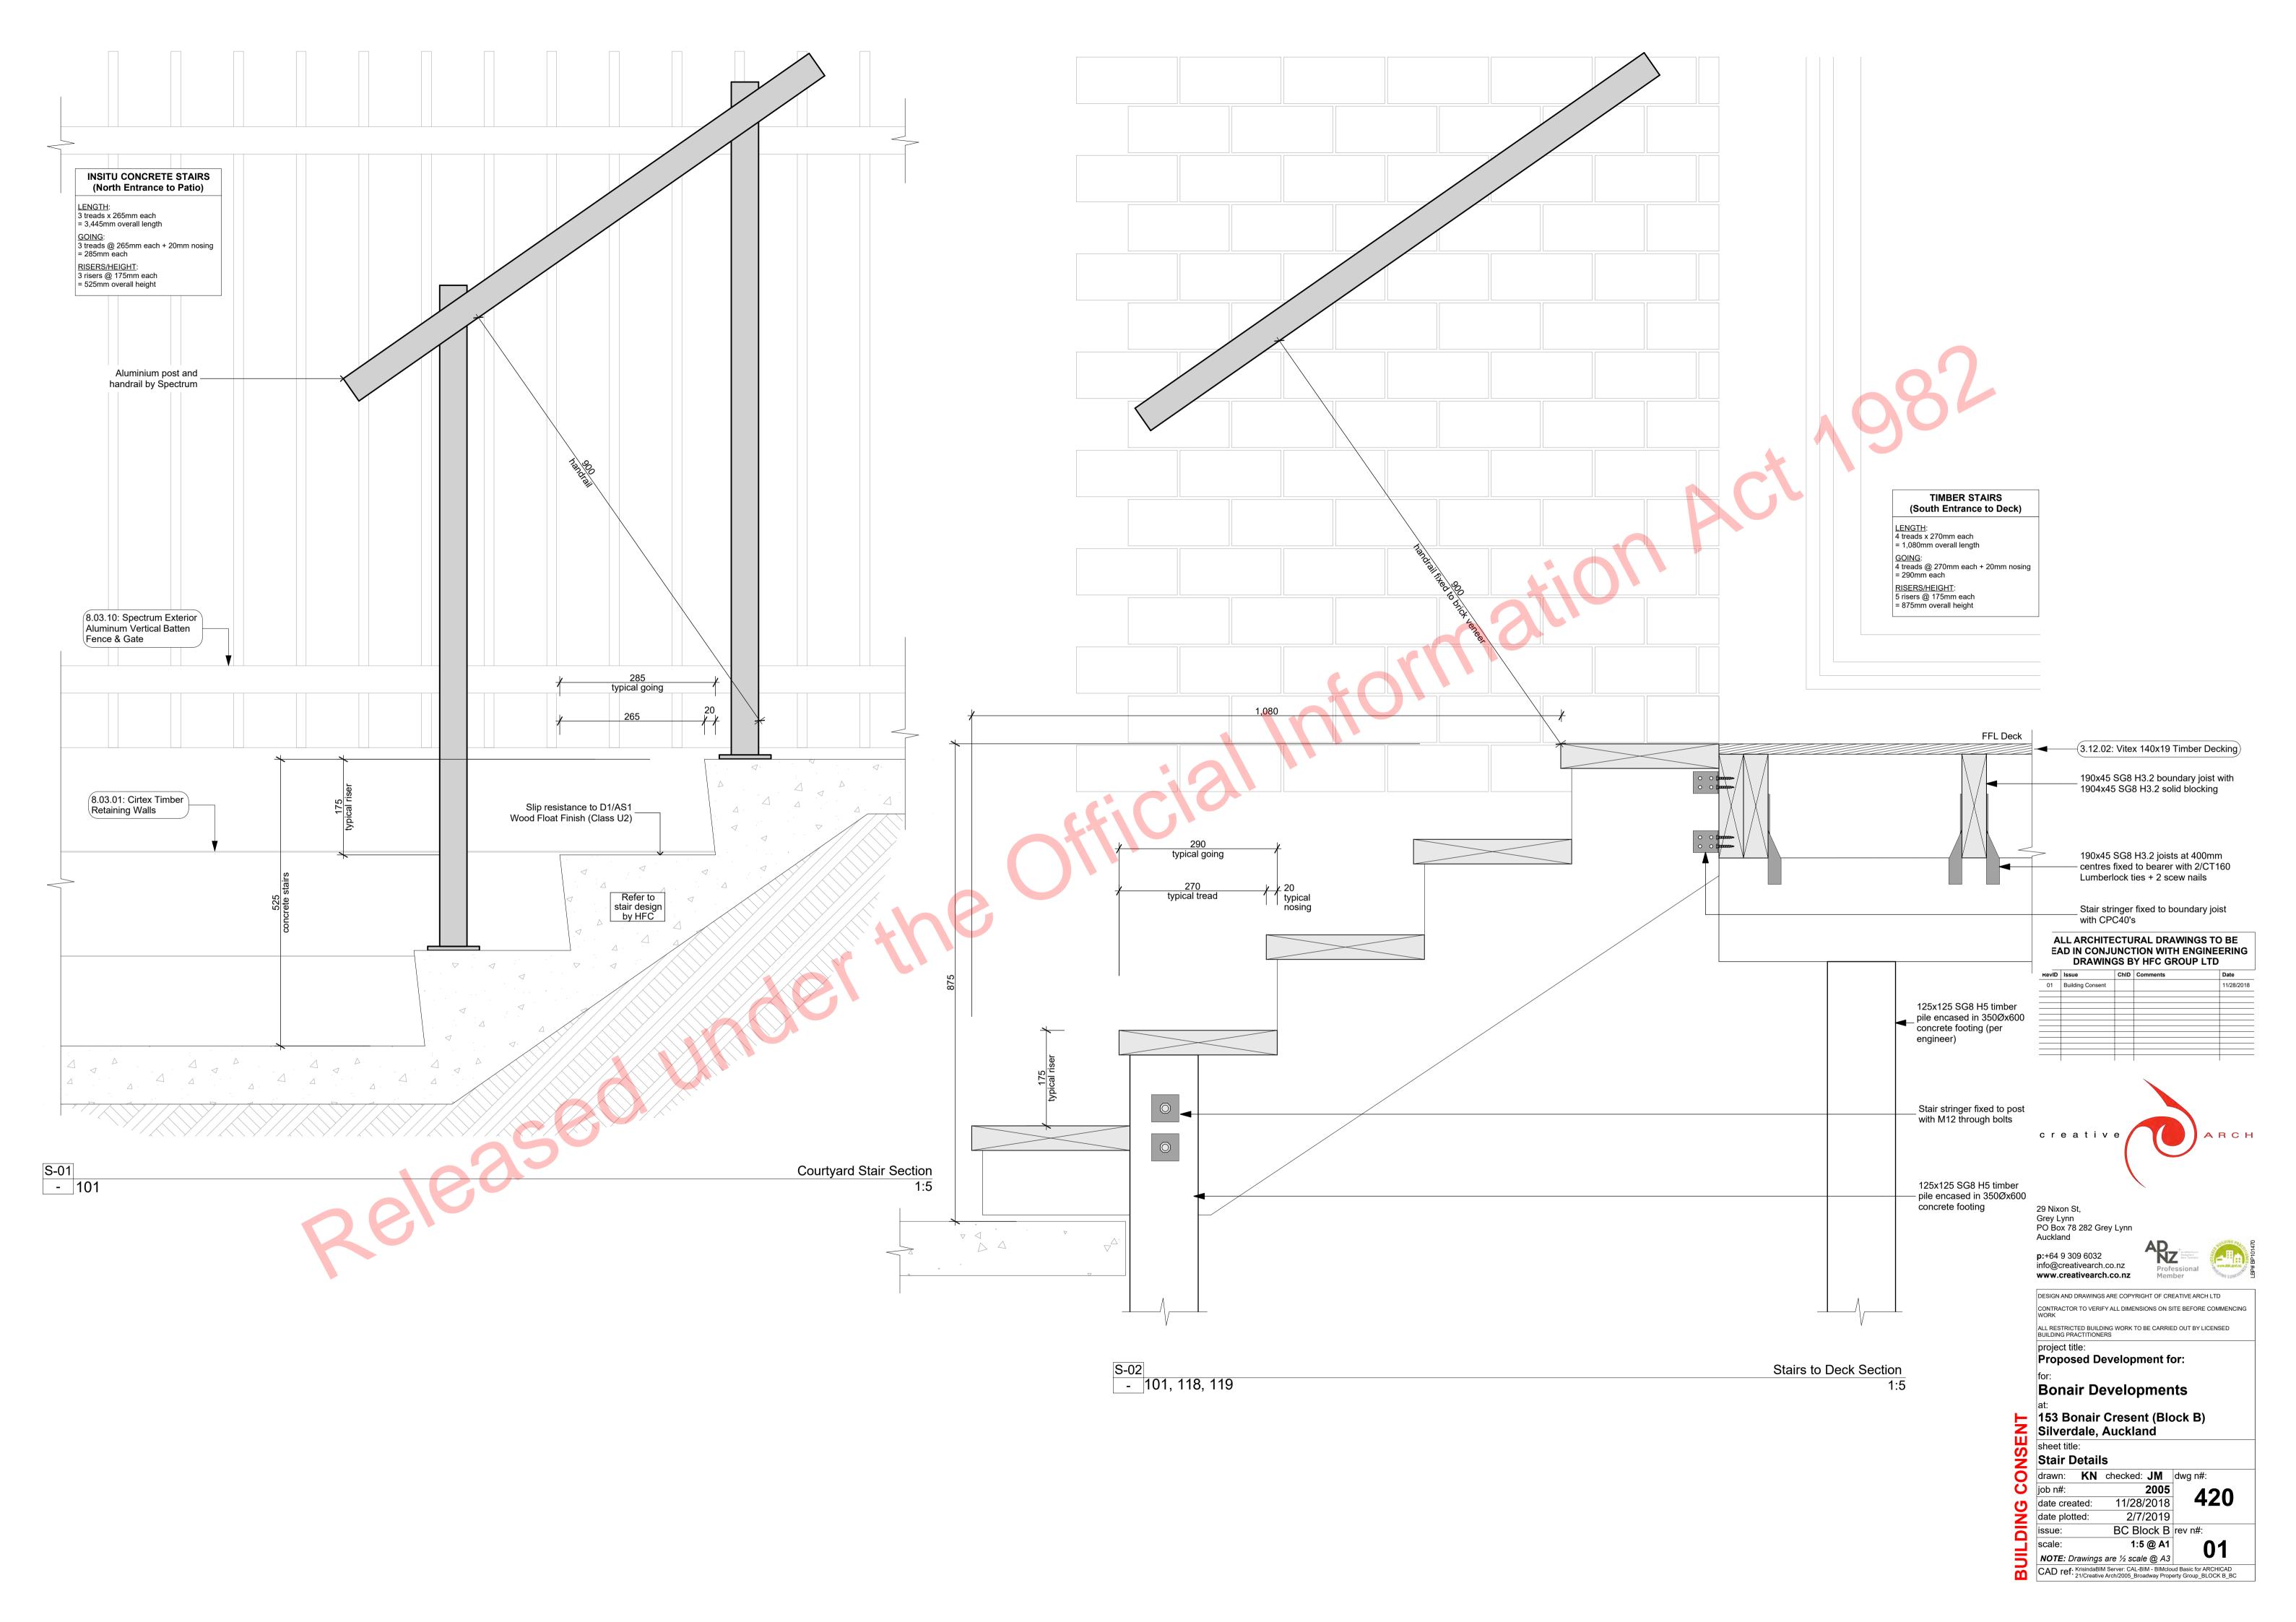

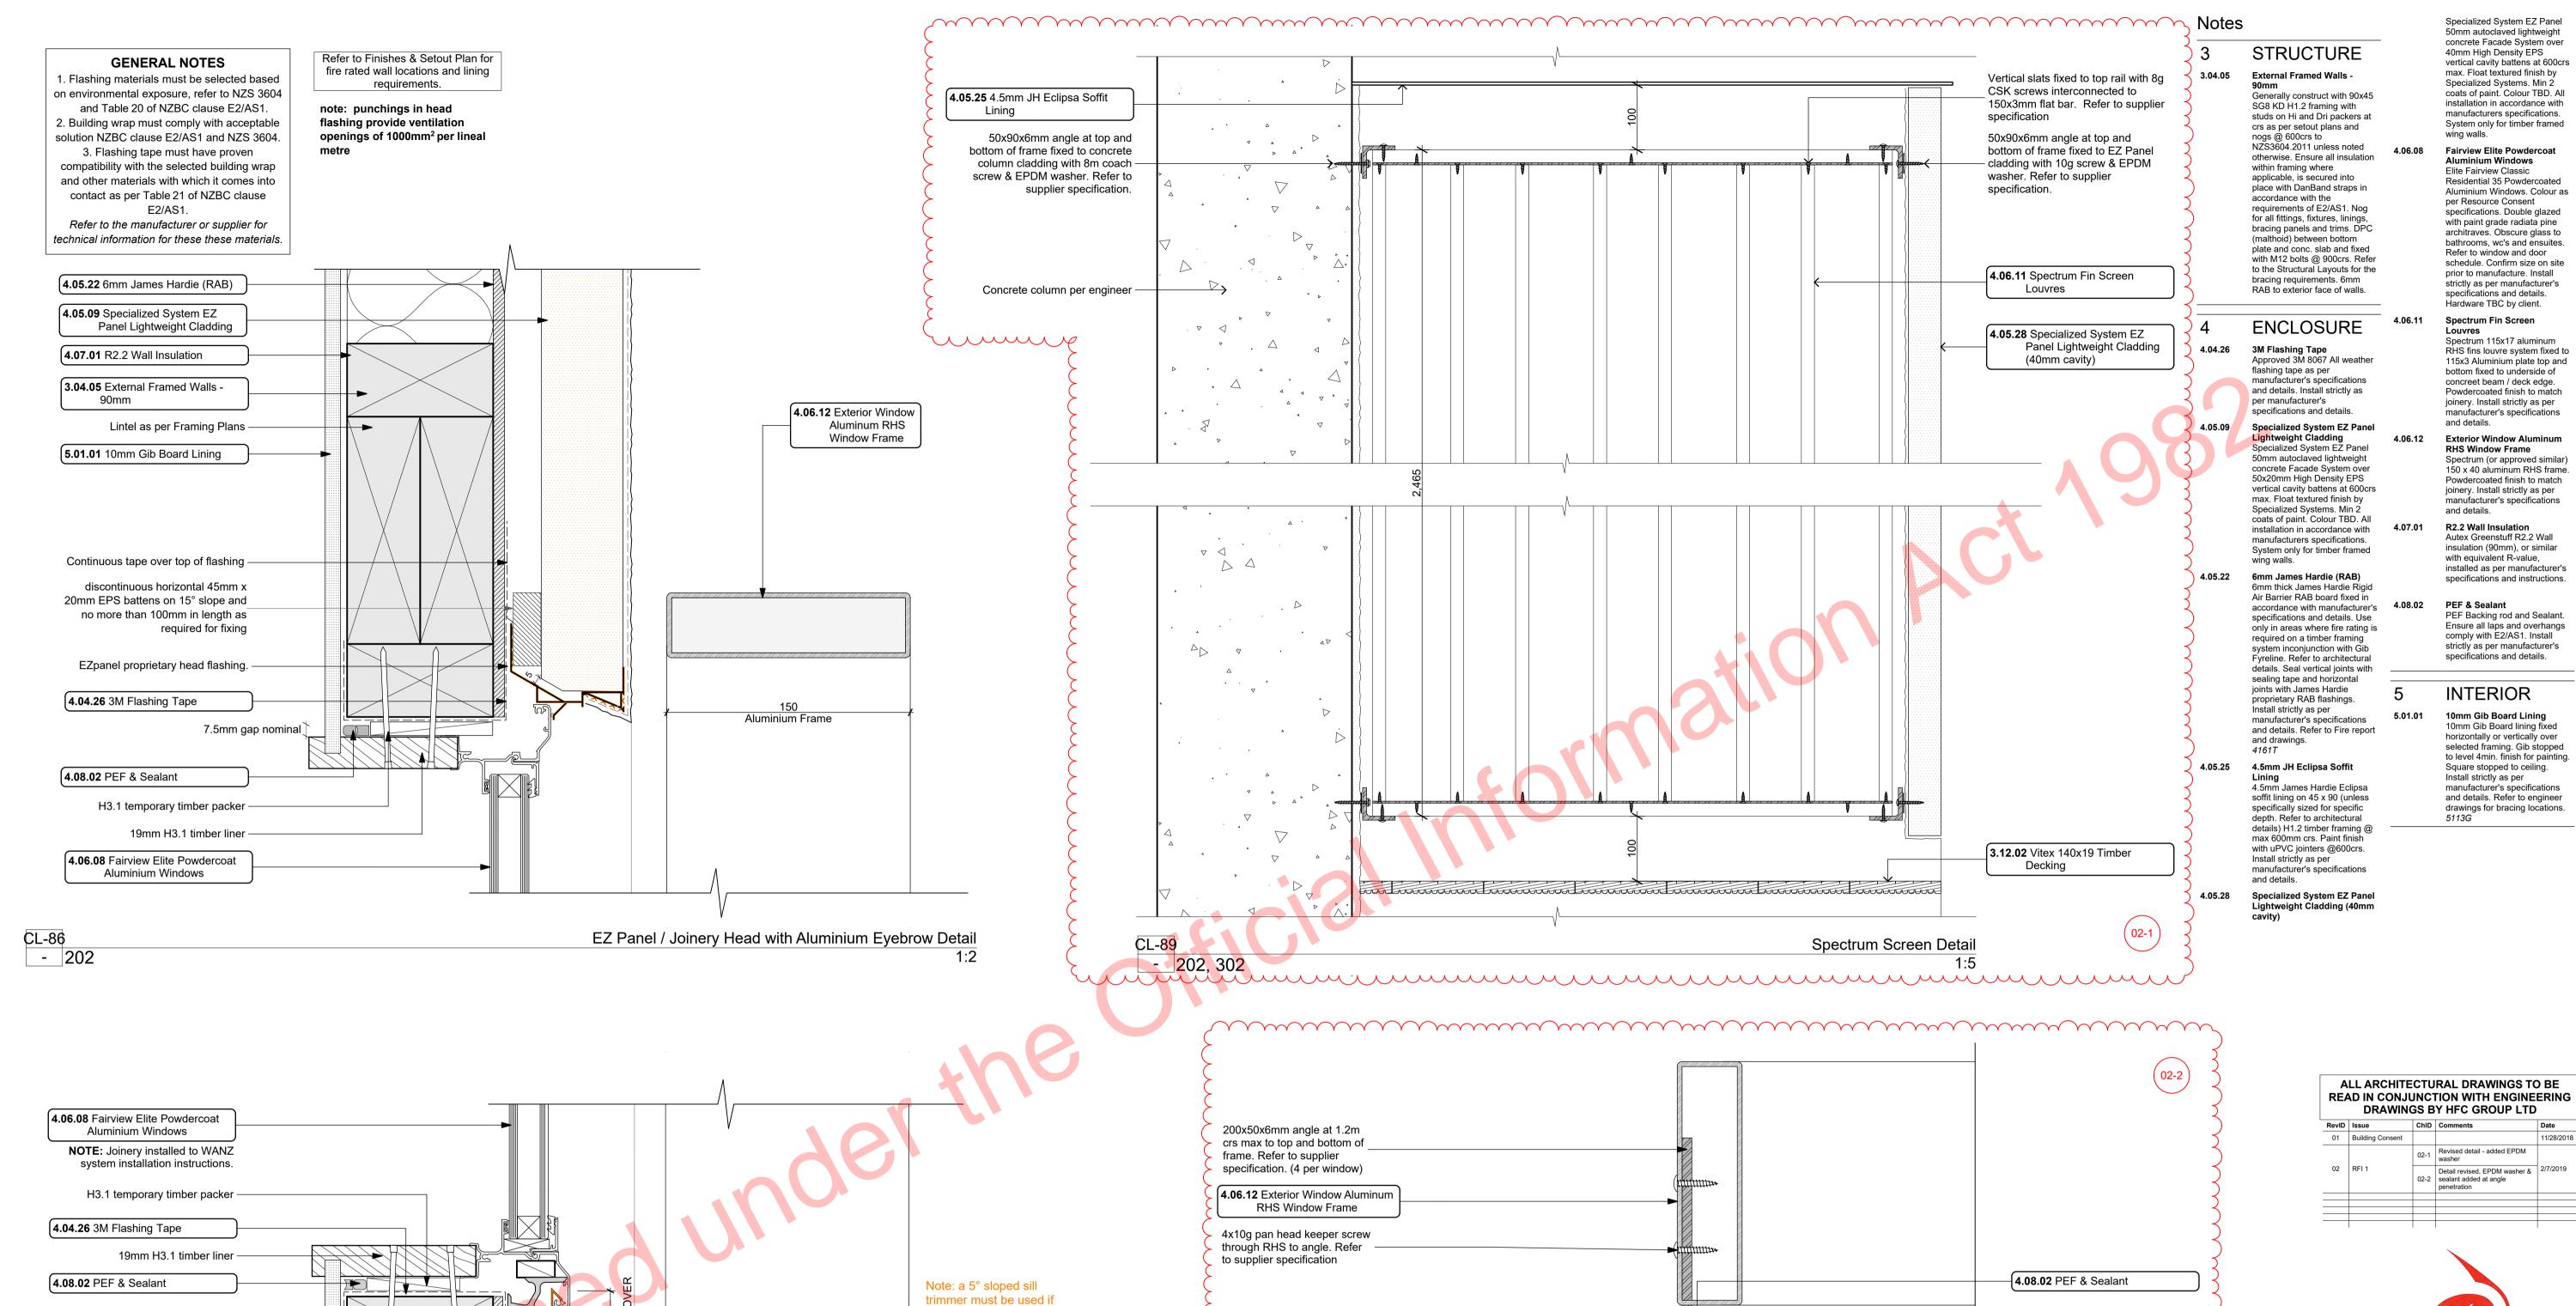

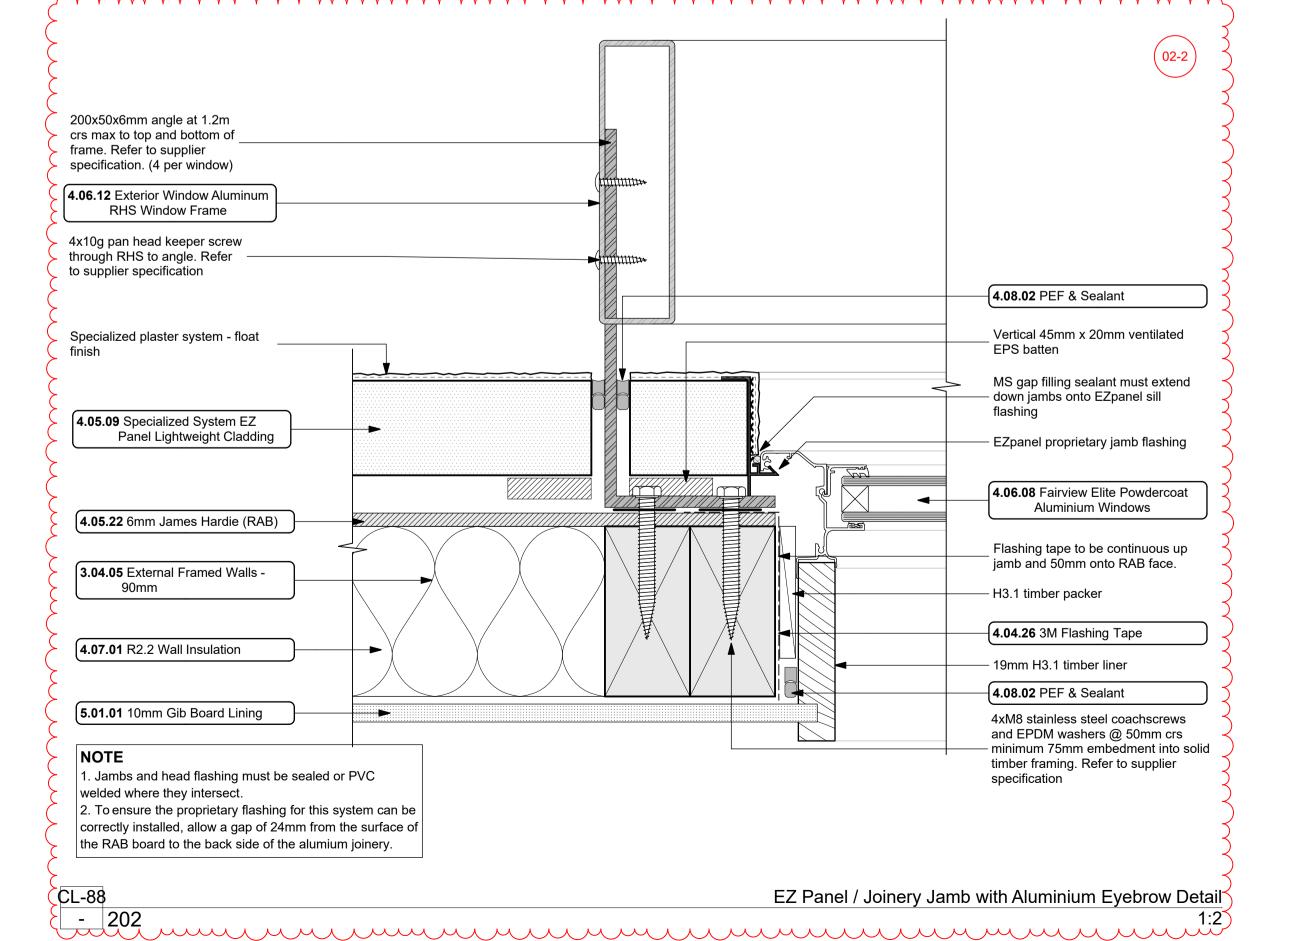



BC Block B rev n#:

1:2, 1:5 @ A1

CAD ref: KrisindaBIM Server: CAL-BIM - BIMcloud Basic for ARCHICAD 21/Creative Arch/2005_Broadway Property Group_BLOCK B_BC

NOTE: Drawings are ½ scale @ A3

5mm bead of MS gap filling sealant -

WANZ Continuous support bar

EZ panel proprietary sill section

fixed to EPS with adhesive prior to

3.04.05 External Framed Walls -

5.01.01 10mm Gib Board Lining

4.05.09 Specialized System EZ

4.05.22 6mm James Hardie (RAB)

Panel Lightweight Cladding

4.07.01 R2.2 Wall Insulation

in accordance with E2/AS1

plastering.

Vertical 45 x 20mm

ventilated EPS batten

the back of the glazing

pocket is positioned back

past the line of wall frame

proprietary flashings for this

Caution: to ensure the

system can be installed

correctly, please allow a

gap of 24mm from the

surface of the building


the aluminium joinery

4.06.12 Exterior Window

Aluminum RHS

Window Frame

paper to the backside of

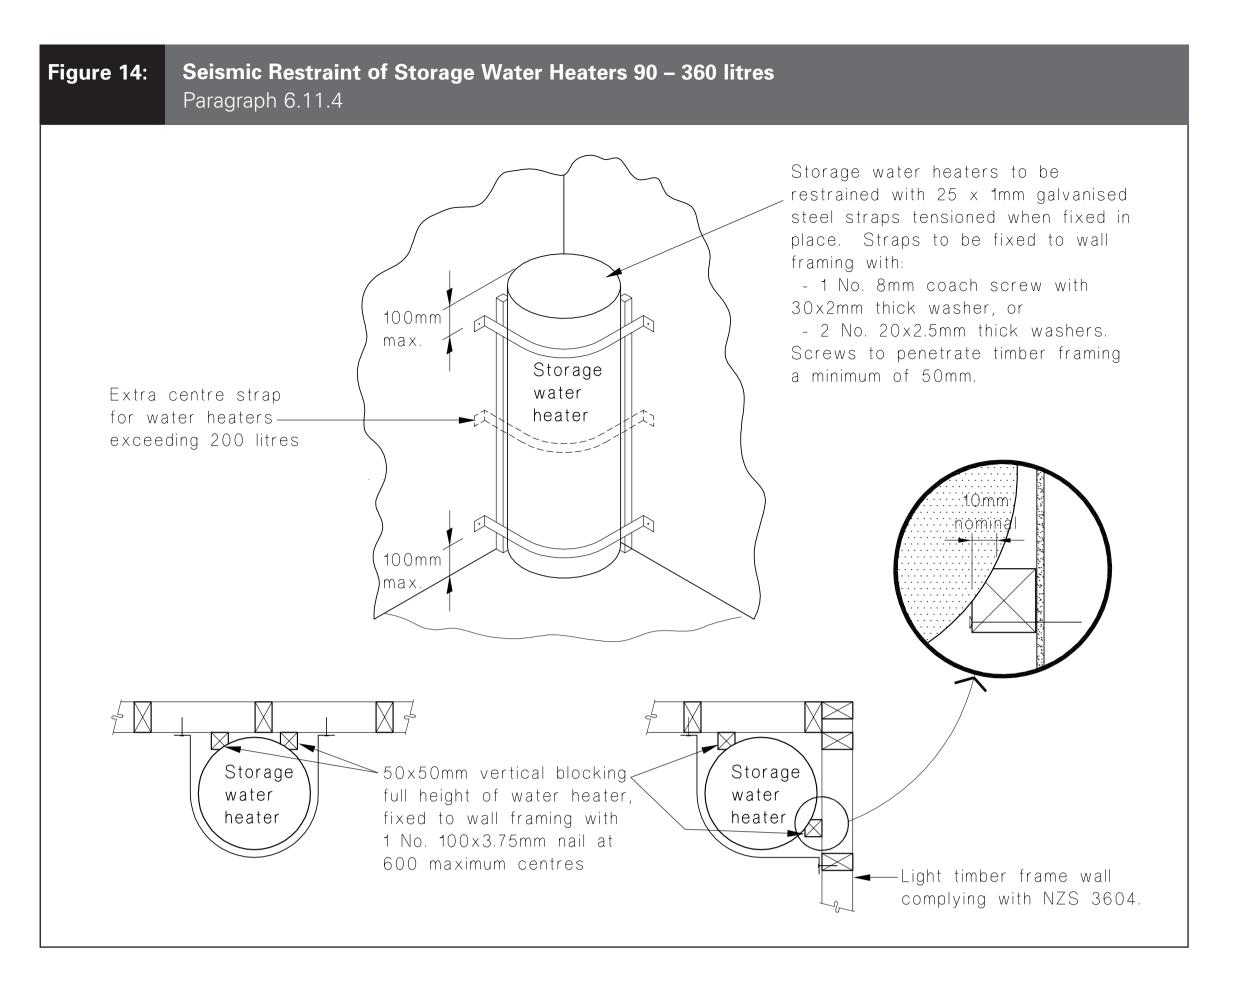

HWC Seismic Restraint

DROP IN FIRE COLLAR TEST RESULTS:

Tested on a trapezoidal steel tray concrete floor with 70mm minimum thickness and 130mm maximum thickness.


NOMINAL PIPE SIZE (MM)	NOMINAL PIPE WALL THICKNESS (MM)	PRODUCT CODE	PENETRATION HOLE SIZE (MM)	FLOOR FRL*	FTC#
PVC PLASTIC PIPE					
40	2.0	DIFC40	72	-/90/60	728
50	2.2	DIFC50	82	-/90/90	728
65	2.7	DIFC65	102	-/90/90	728
80	2.9	DIFC80	112	-/90/90	728
100	3.2	DIFC100	142	-/90/60	728
150	4.5	DIFC150	192	-/90/90	728
PVC PIPE SOCKET	CONNECTIONS				
40	4.0	DIFC40	72	-/90/60	728
100	6.4	DIFC100	142	-/90/90	728
HDPE					
150	7.0	DIFC150	192	-/90/90	728

INSTALLATION


INSTRUCTIONS:


pin anchors.

- 1. Core drill hole to specified diameter to suit pipe size. Install drop in fire collar fixing with two M5x22mm metal
- Insert pipework through collar. 4. Seal gaps between concrete/ collar and collar/pipe with

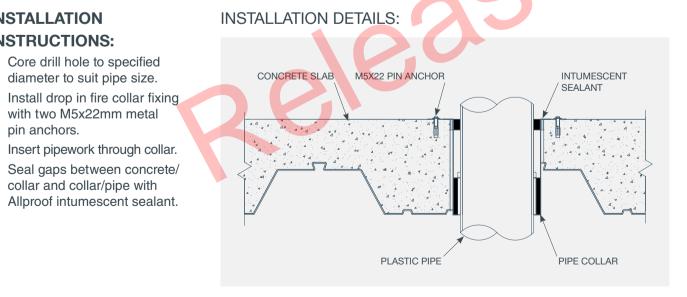

Allproof Drop In Fire Collars Details 1:1

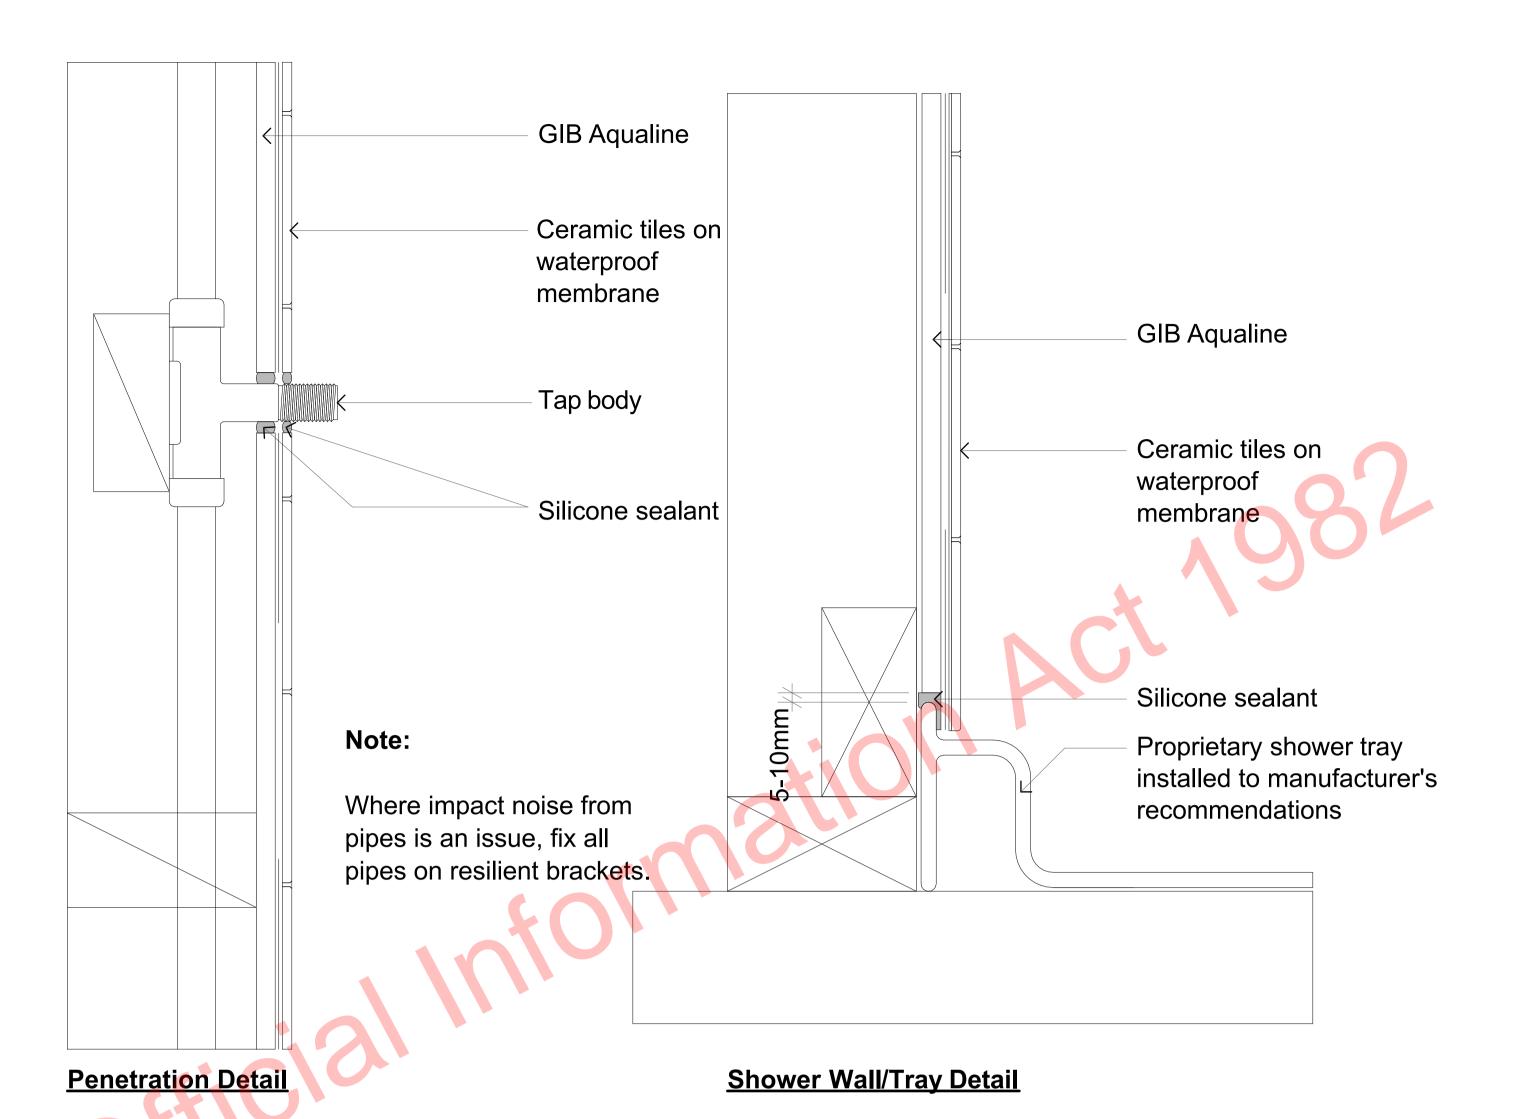

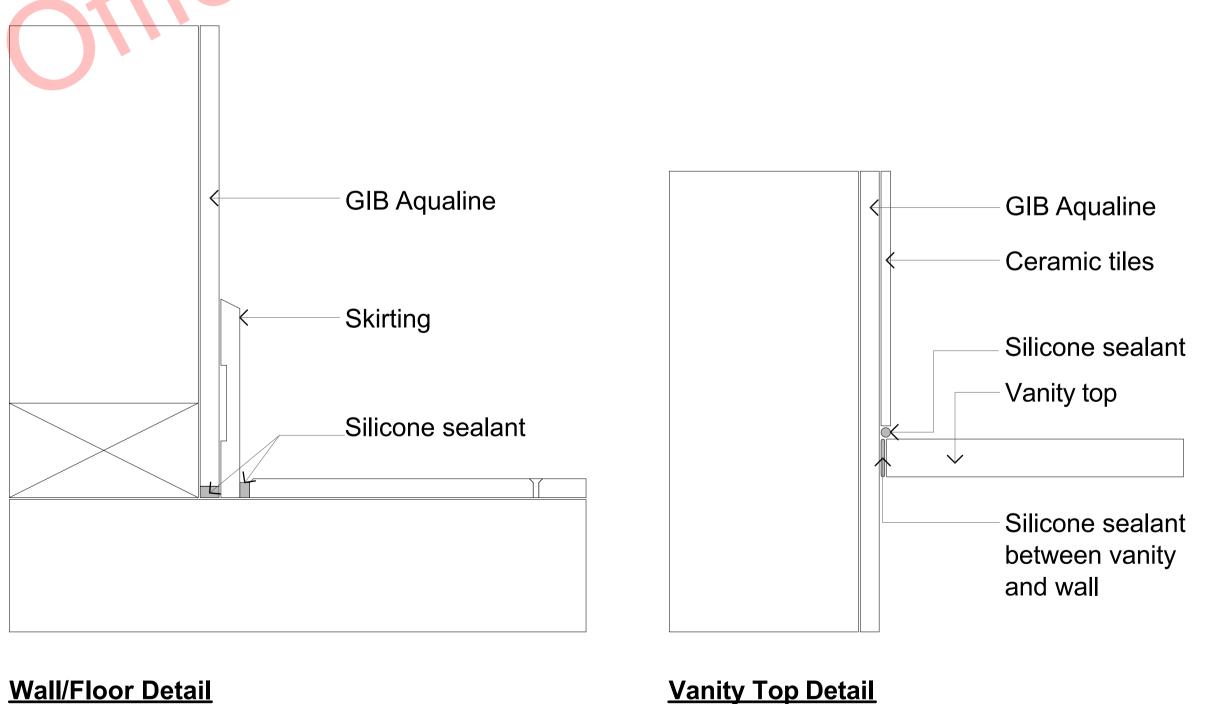


Bathroom Detail



BC Block B rev n#: 1:1 @ A1

CAD ref. KrisindaBIM Server: CAL-BIM - BIMCloud Basic for ARCHICAD 21/Creative Arch/2005_Broadway Property Group_BLOCK B_BC

NOTE: Drawings are ½ scale @ A3

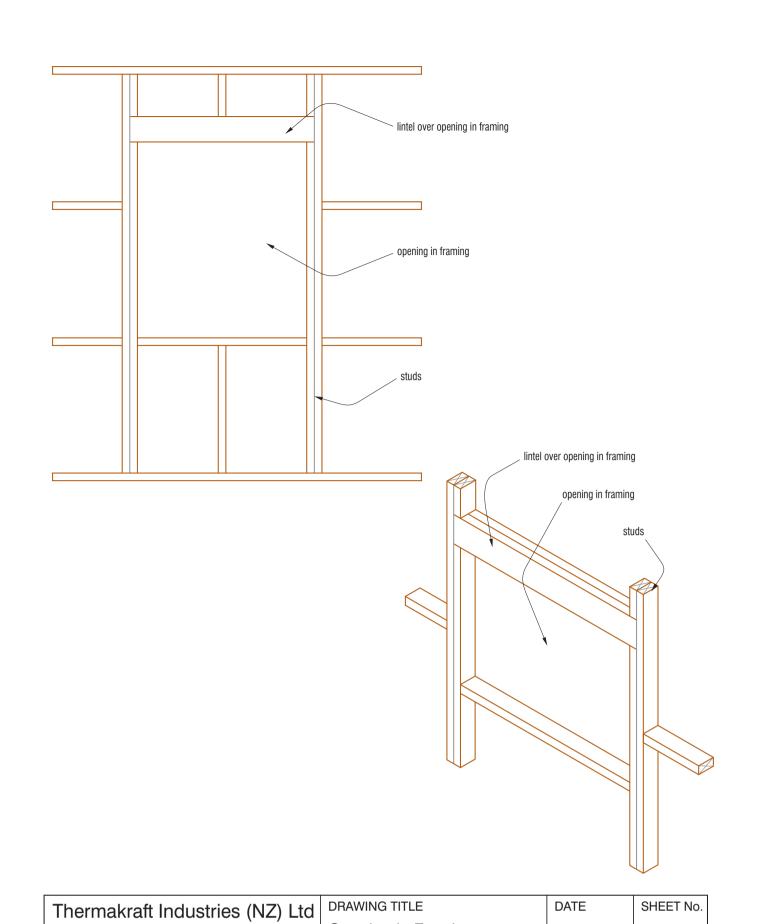

Opening in Framing

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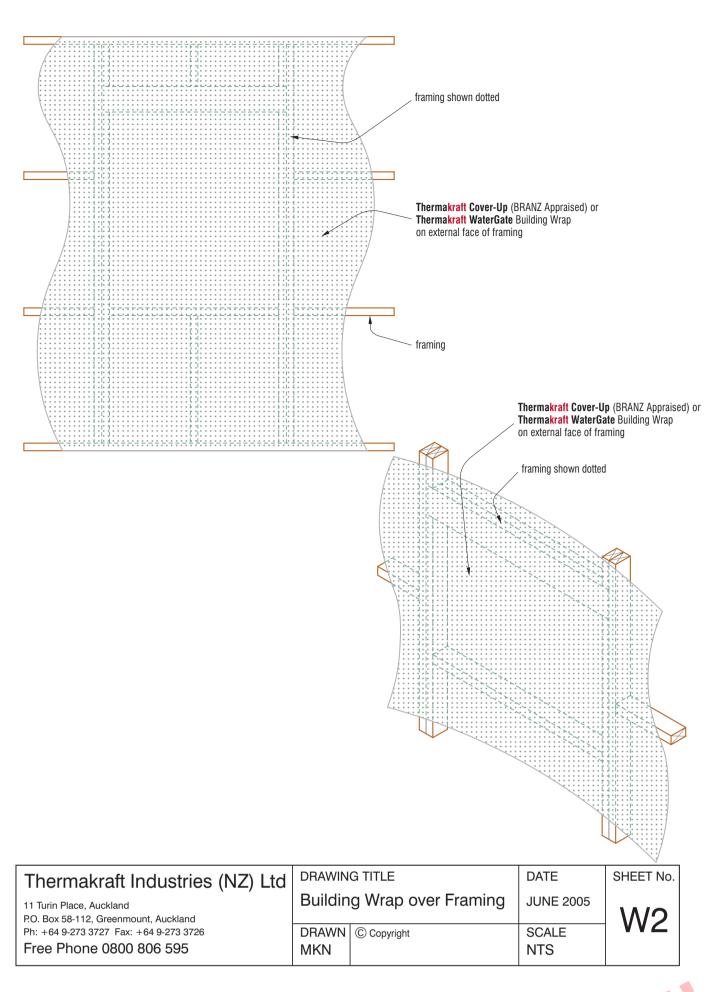
Free Phone 0800 806 595


Ph: +64 9-273 3727 Fax: +64 9-273 3726


JUNE 2005

SCALE


NTS




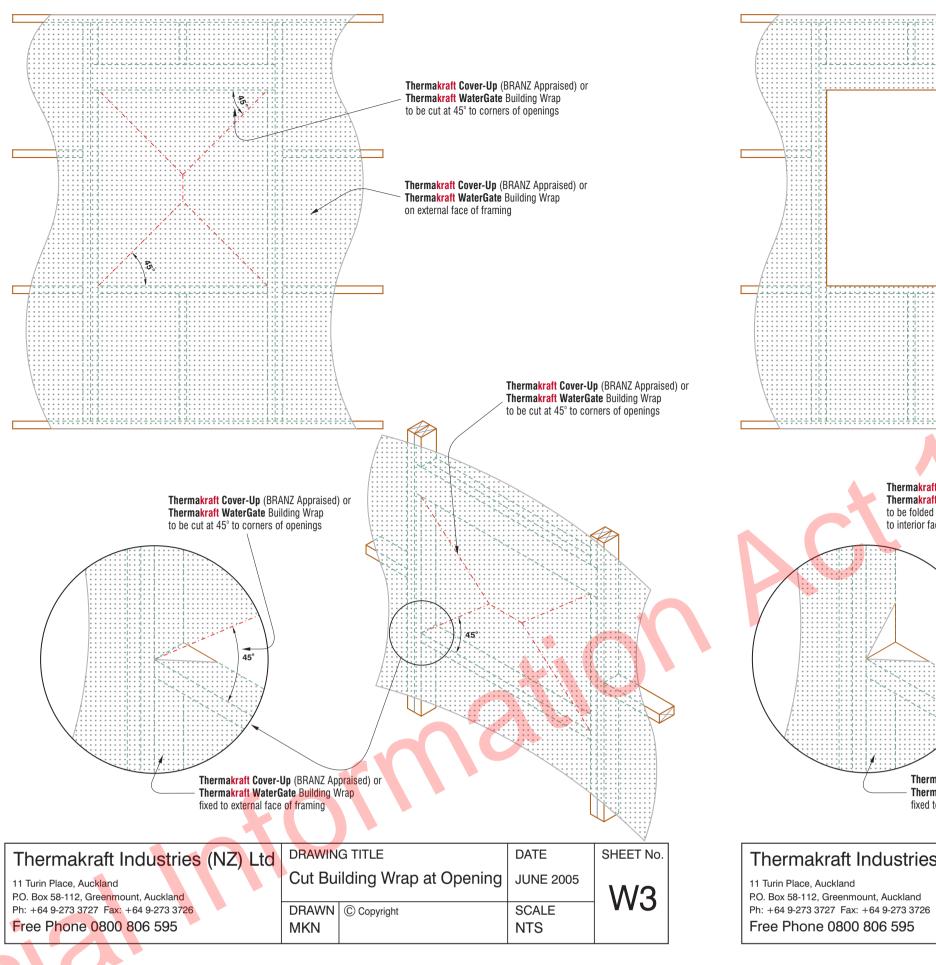

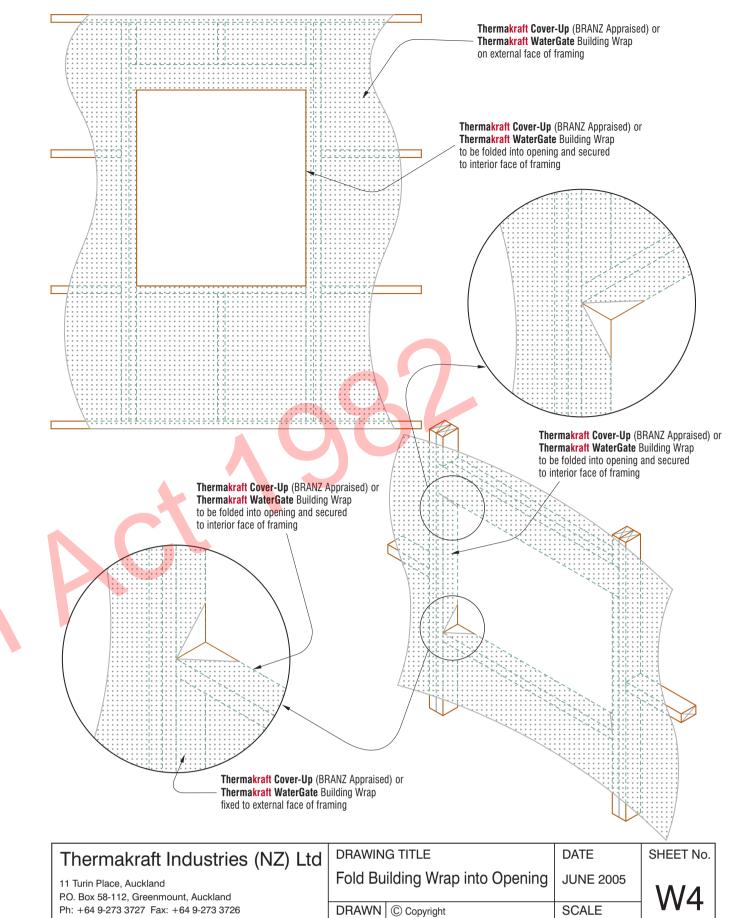

MKN

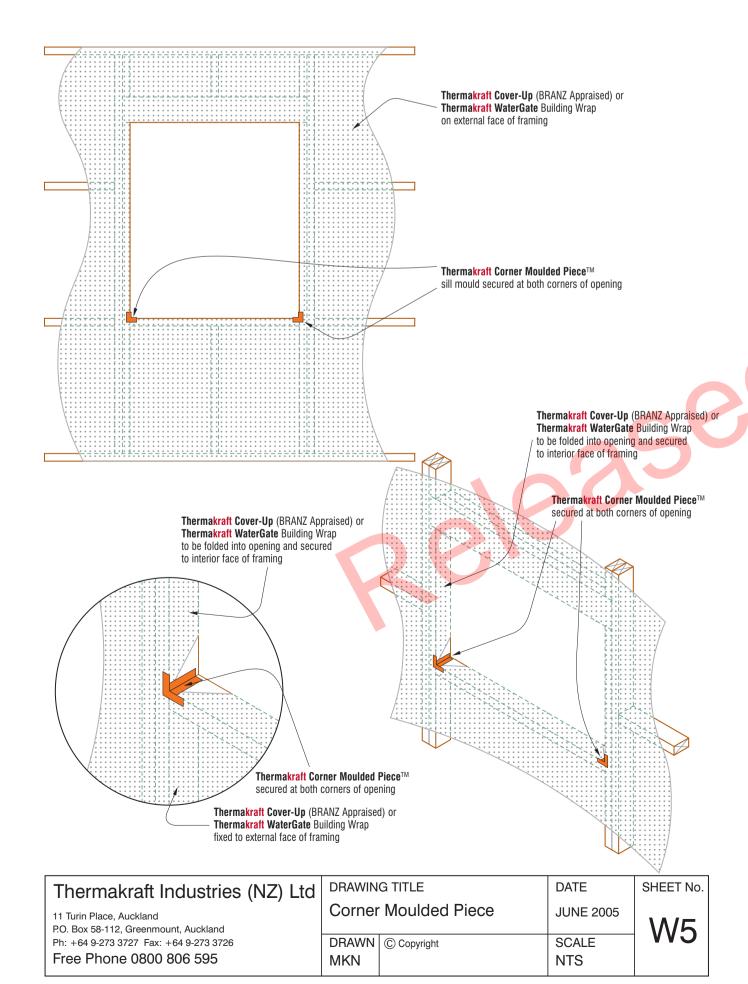

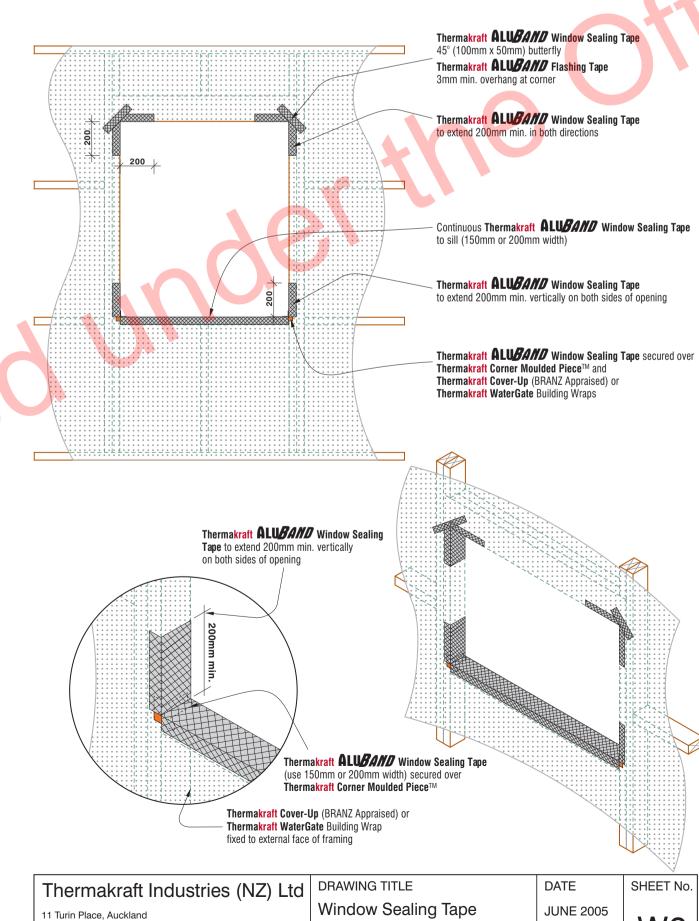

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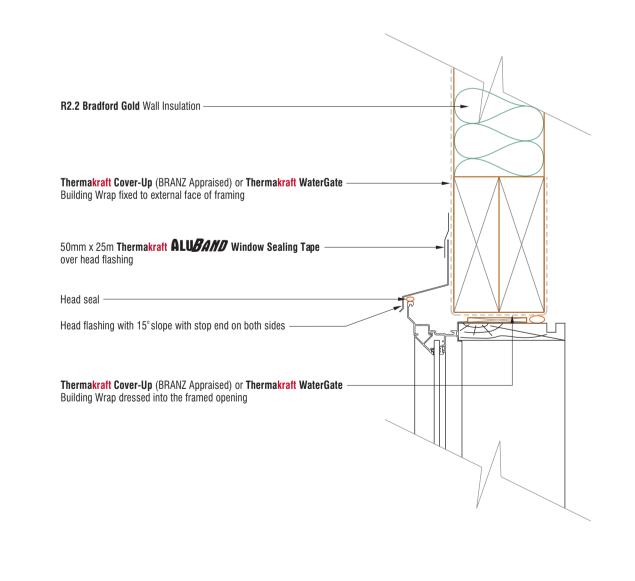
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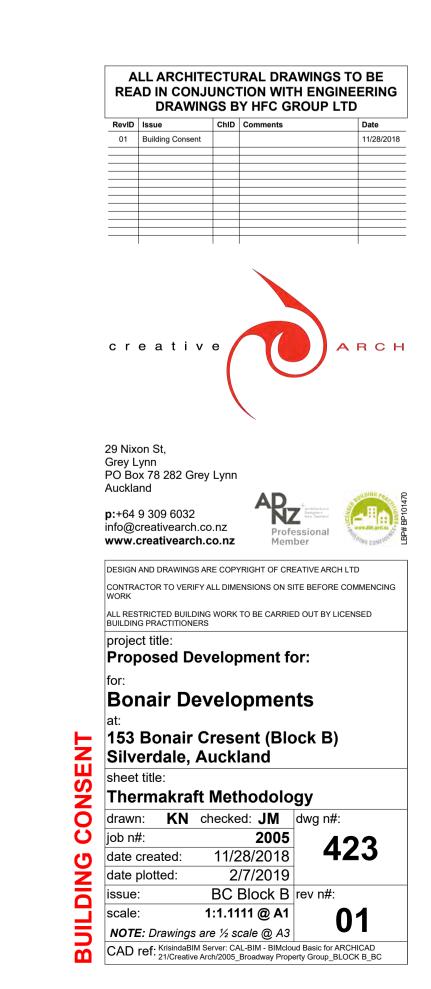
P.O. Box 58-112, Greenmount, Auckland

Free Phone 0800 806 595

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Thermakraft Industries (NZ) Ltd	DRAWIN	G TITLE	DATE	SHEET No.
11 Turin Place, Auckland P.O. Box 58-112, Greenmount, Auckland	Windo	w Sealing Tape	JUNE 2005	W7
	DRAWN MKN	© Copyright	SCALE NTS	



NTS

10/2011


Wind Zone

LINTEL FIXING SCHEDULE

ALTERNATIVE TO TABLE 8.14 & FIGURE 8.12 NZS 3604:2011

★ All fixings are designed for vertical loads only. Dead loads include the roof weight and standard ceiling

- Refer to Table 8.19 NZS 3604:2011 for nailing schedule to resist horizontal loads. ★ These fixings assume the correct choice of rafter/truss to top plate connections have been made.
- ★ All fixings assume bottom plate thickness of 45mm maximum. Note: TYLOK options on timber species.
- ★ Wall framing arrangements under girder trusses are not covered in this schedule. ★ All timber selections are as per NZS 3604:2011.

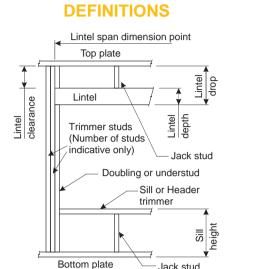


____Jack stud **Lintel Supporting Girder Trusses:** Tributary Wind Zone Wind Zone


1) Roof Tributary Area = approx. 1/2 x (Total roof area on girder and rafter trusses supported by lintel) 2) Assumed girder truss is at mid-span or middle third span of lintel 3) Use similar fixings for both ends of lintel 4) All other cases require specific engineering design


SELECTION CHART FOR LINTEL FIXING

Wind Zone

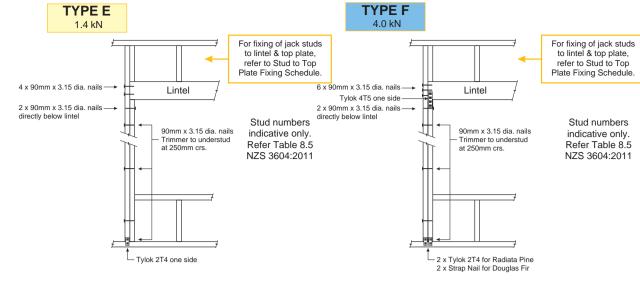

LINTEL FIXING OPTIONS

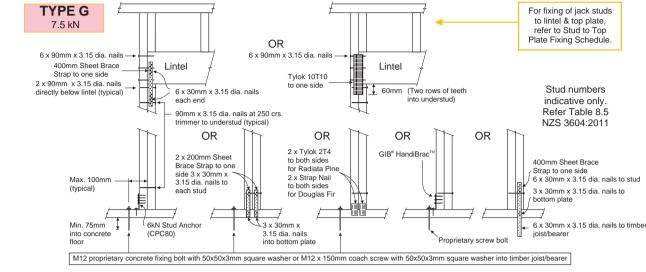

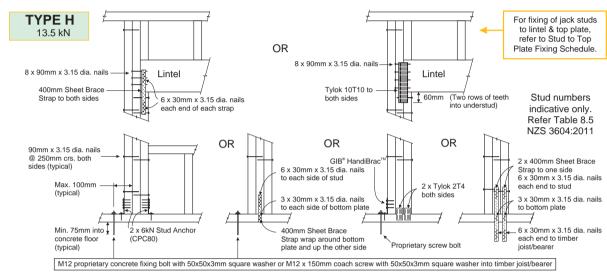

STANDARD FIXING OPTIONS

FIXING DEFINITIONS

3.45kN

FIXING TYPE E

2 BLUE SCREWS

2 SKEW NAILS plus 2 WIRE DOGS (for purlin on edge)

2 NAILS plus 1 CT200

1 PAIR of CPC40

MiTek New Zealand Limited MiTek[®]

GANG-NAIL® LUMBERLOK® BOWMAC®

0.55kN

1 NAIL

FIXING TYPE B

0.8kN

2 NAILS

FIXING TYPE C 2.4kN

1 BLUE SCREW

NOTE:

Note: Two nails maybe preferred to prevent

batten rolling over with high roof pitches.

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Purlin / Batten

1UMBERLOK®

07/2011


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PURLIN & BATTEN FIXING CHART

ALTERNATIVE SOLUTION TO NZS 3604:2011 TABLES 10.10 & 10.12

NOTE:

- ★ All purlin and batten sizes are as per NZS 3604:2011.
- ★ All fixings assume that the purlin and battens are installed on their flat over the top of the rafter or truss. The minimum fixing requirements apply to all purlin locations within the roof area.
- ★ The LUMBERLOK BLUE SCREW where specified requires a minimum of 30mm penetration into rafter or truss i.e. it is suitable for rough sawn timber up to 50mm thick at 18% moisture content.

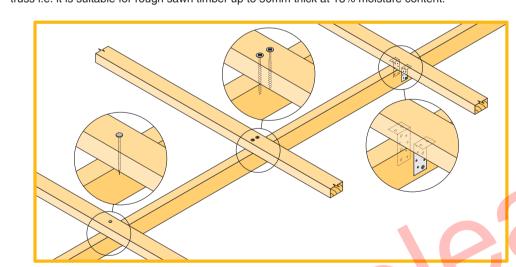

SELECTION CHART FIXING OPTION (minimum fixing requirements)

ROOF WEIGHT	PURLIN SPAN PURLIN	MAX. PURLIN CRS.	WIND ZONE				
		(mm)	L	М	Н	VH	EH
HEAVY ROOF Tile Battens	900	370	А	А	А	А	Α
LIGHT ROOF Tile Battens	900	370	Α	Α	В	С	С
	1200	370	Α	В	С	С	С
LIGHT ROOF Purlins	900	900	С	С	С	С	D
	1200	900	С	С	С	D	D
	1200	1200	С	С	D	Е	Е

As per NZS 3604:2011 H = High Wind VH = Very High Wind EH = Extra High Wind

NAIL = Either 90mm x 3.15 dia. power-driven nail

BLUE SCREW = 80mm x 10 gauge LUMBERLOK

BLUE SCREW

or 100mm x 3.75 dia. hand-driven nail

WIRE DOG = LUMBERLOK WIRE DOG either LH or RH

FIXING TOLERANCES

LUMBERLOK BLUE SCREW

PURLIN / BATTEN SPLICE FIXING OPTIONS FIXING TYPE 1 nail in each A & B OVER PURLIN SPLICE Skew nail when fixing to 35mm rafter or truss C. D or E OVER to chord or rafter with PURLIN SPLICE 4 x 75mm nails

CT200 = LUMBERLOK Ceiling Tie CT200 bend over purlin, 4 x LUMBERLOK Product Nails

2 x Type 17-14g x 35mm Hex Head Screws

30mm x 3.15 dia. each end

CPC40 = LUMBERLOK CPC40 with

per flange

FIXING TYPE 90 x 35mm block fixed • TYPE C 1 SCREW to each purlin • TYPE D & E 1 NAIL plus 1 SCREW to each purlin

MiTek

Locate fixings within the shaded area. Care to


be taken to avoid over tightening of screws.

LUMBERLOK®


MULTI-BRACE


★ Commercial and Industrial Roof/Wall Bracing

★ Economically comparable to Steel Rod or Timber Bracing systems

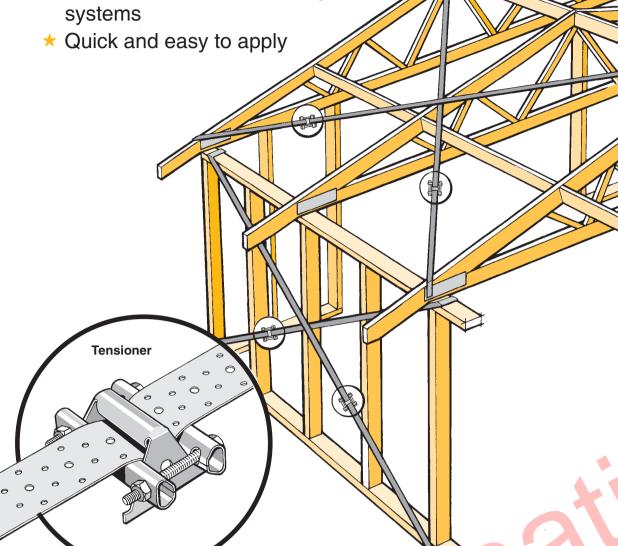

Available from leading Builders Supply Merchants throughout New Zealand

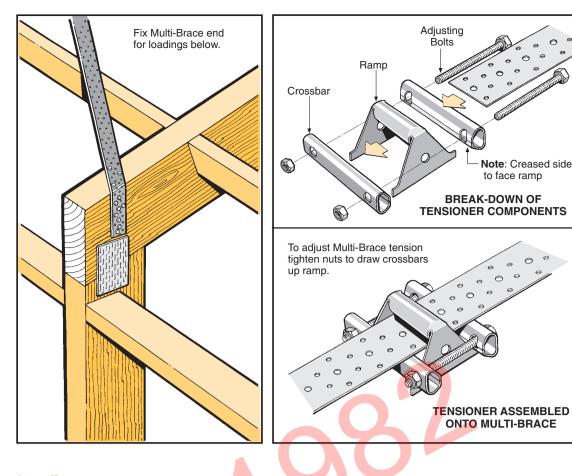

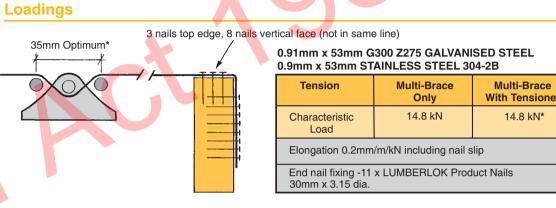

Use tensioner to ensure Multi-Brace is taut prior to roof fixing. *Note: Not available in Stainless Steel so tension must be provided during installation phase.

LUMBERLOK merchant. (Special lengths available on request).

Multi-Brace is available in 10m, 15m and 30m coil lengths which may be ordered through your local

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FIXING OPTIONS

11/2011

USE STAINLESS STEEL

OPTION IN

EXTERIOR SITUATIONS

09/2011

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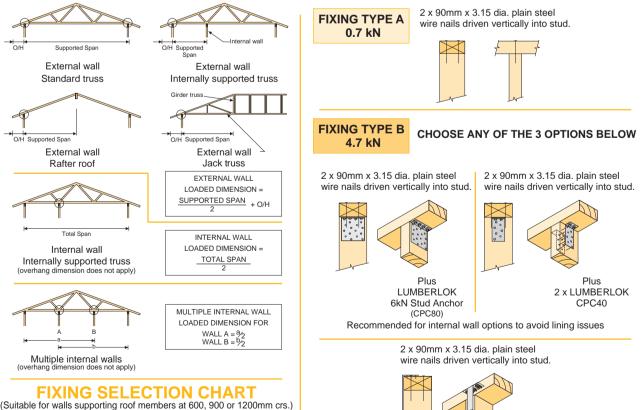
STUD TO TOP PLATE FIXING SCHEDULE

ALTERNATIVE TO TABLE 8.18 NZS 3604:2011

All fixings are designed to resist vertical loads only. Dead loads include the roof weight and standard ceiling weight of 0.20 kPa. Refer to Table 8.19 NZS 3604:2011 for nailing schedule to resist lateral loads. These fixings assume the correct choice of rafter/truss to top plate connections have been made. Gable end wall top plate/stud connections where the adjacent rafter/truss is located within 1200mm of gable end wall with a maximum verge overhang of 750mm, requires fixing type A as shown below.

All fixings assume top plate thickness of 45mm maximum. Wall framing arrangements under girder trusses are not covered in this schedule. All timber selections are as per NZS 3604:2011.

LOADED DIMENSION DEFINITION



2 x 90mm x 3.15 dia. plain steel wire nails driven vertically into stud. Wind Zones L, M, H, VH, EH, as per NZS 3604:2011 Light Roof Heavy Roof Stud Centres Wind Zone Wind Zone 300mm 400mm 600mm L M H VH EH L M H VH EH LUMBERLOK Stud Strap To calculate the number of B type fixings required, divide the wall length

as evenly as possible along the wall length. This figure includes the start and end studs in each wall length. **MiTek New Zealand Limited**

DRAWINGS BY HFC GROUP LTD



ALL ARCHITECTURAL DRAWINGS TO BE

READ IN CONJUNCTION WITH ENGINEERING

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Bonair Developments

Silverdale, Auckland

sheet title: **Mitek Details** drawn: KN checked: JM dwg n#: 2005 11/28/2018 date created:

2/7/2019 BC Block B rev n#: 1:1.1111 @ A1 scale:

CAD ref: KrisindaBIM Server: CAL-BIM - BIMcloud Basic for ARCHICAD 21/Creative Arch/2005_Broadway Property Group_BLOCK B_BC

NOTE: Drawings are ½ scale @ A3

GANG-NAIL® LUMBERLOK® BOWMAC®

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by the stud centres, add 1 to this figure and locate this number of fixings

